

# NMSU AGRICULTURAL MODERNIZATION PHASE 3: NEALE HALL DEMOLITION



95% CONSTRUCTION DOCUMENTS  
MARCH 14, 2024

## GENERAL

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G-001 BUILDING CODE ANALYSIS

## CIVIL

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C-100 UTILITY PLAN

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FRAMING & ROOF FRAMING PLANS  
SECTIONS  
S-201

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AS-101 SITE PLAN  
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AE-101 EXISTING PLANS  
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T-101 TECHNOLOGY SYSTEMS FLOOR PLAN  
T-601 TECHNOLOGY DIAGRAM

## OWNER

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## PROJECT DESCRIPTION

The NMSU Biomedical Research Building Expansion will require the North end of Neale Hall to be demolished. FBT, in cooperation with the Design Team's Mechanical, Electrical, Plumbing, Civil and Structural Engineers, has evaluated the existing facility and identified the logical demolition line. The Design Team recognizes the existing tenants on the South end of the building most remain operational during the demolition process. Utilities were evaluated. A new sewer line tap will be required. New electrical transformer relocated and mechanical rooms to support new services including panels for new transformer and hot water heater. The existing structural basement will need careful stabilization during demolition to not impact the existing structure. Two existing windows will be impacted by the demolition line and a new exterior wall with foundations will be required to closeout the existing facility. Note this work does not support bringing the remaining building up to code relative to electrical, mechanical and plumbing. This project merely restores existing utilities.

## BIM MODEL REQUIREMENTS

### BIM MODEL SUBMITTAL & COORDINATION REQUIREMENTS

All requirements noted in individual specification sections for submittal of coordination drawings and shop drawings shall be strictly followed. Item or Equipment fabrications and installations that occur prior to the approval of these drawings shall be subject to removal and replacement at no additional cost to the owner.


In addition to the required drawings noted above, contractor shall prepare BIM (Building Information Model) for the systems noted below. The intent of this BIM model is to determine conflicts and coordinate solutions that will resolve final system installation. The contractor may use the overall BIM model to generate the coordination drawings and vice-versa.

1. HVAC
2. Plumbing
3. Electrical
4. Fire Protection
5. Special Systems
6. Structural

## VICINITY MAP



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CODE ANALYSIS

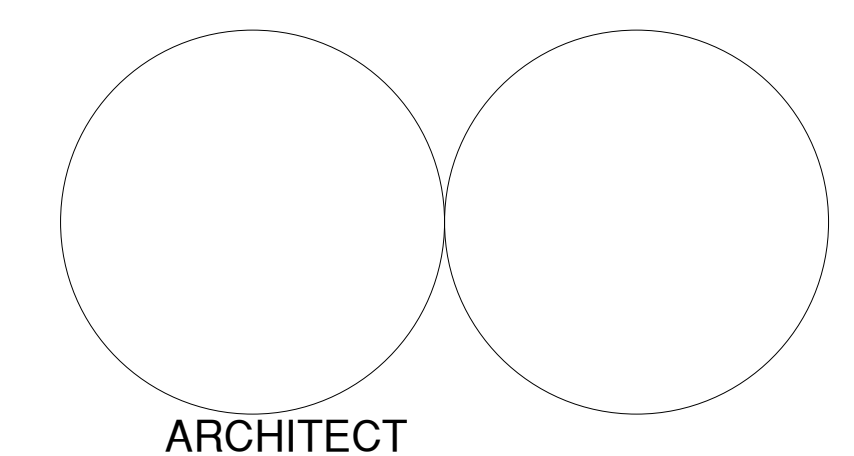ALTERATION LEVEL 2 SUMMARY

**DEMOLITION:**  
 THE ADDITION THAT WAS BUILT IN 1972 WILL BE DEMOLISHED IN ITS ENTIRETY INCLUDING THE CAPPING OF UTILITIES WITHIN 2' OF MAIN LINES. THIS ADDITION HAD NO IMPACT ON THE ORIGINAL BUILDING EGRESS OR UTILITIES AND THERE FOR THE DEMOLITION OF THE ADDITION HAS NO IMPACT ON THE CURRENT FUNCTION OF THE BUILDING TO REMAIN.

THE 3-STORY PORTION OF THE EXISTING BUILDING FROM 1980 IS TO BE DEMOLISHED IN ITS ENTIRETY. THIS INCLUDES THE MAIN FLOOR LEVEL AND BASEMENT AS SHOWN IN DRAWINGS. THIS ALSO INCLUDED THE ASSOCIATED LOADING DOCK, CANOPY AND ANIMAL HANDLING SITE ELEMENTS.

**BUILDING TO REMAIN:**  
 BUILDINGS ORIGINAL EGRESS ROUTES WERE NOT MODIFIED FOR THE PORTION OF THE BUILDING TO REMAIN. RESTROOMS, INTERIOR FINISHES, AND UTILITY SIZING AND DISTRIBUTION IS TO STAY THE SAME. ONE SMALL ROOM IS BEING SLIGHTLY INCREASED IN SIZE TO ACCOMMODATE A NEW HOT WATER HEATER THAT WAS PREVIOUSLY IN THE BASEMENT OF THE BUILDING.

UTILITIES WILL BE RECONNECTED TO CONTINUE SERVICING THE PORTION OF THE BUILDING TO REMAIN. FIRE PROTECTION, SEWER, GAS, AND ELECTRICAL WILL BE RECONNECTED AND NOT EXPANDED WITHIN THE BUILDING. UNDER SLAB UTILITIES WILL REQUIRE THE DEMOLITION AND REPLACEMENT OF CONCRETE SLAB TO PERFORM RECONNECTION WORK. THE CURRENT TRANSFORMER THAT SERVICES THIS BUILDING IS WITH THE PLANNED DEMOLITION AREA AND WILL NEED TO BE RELOCATED.

ONE NEW EXTERIOR WALL NEEDS TO BE ADDED TO THE NORTH-EAST SIDE OF THE BUILDING TO CLOSE UP THE BUILDING. 2 NEW INTERIOR WALL WILL BE CONSTRUCTED TO CREATE A CLOSET FOR THE WATER HEATER AND UTILITY VALUES.

REFERENCES

- 2021 NEW MEXICO EXISTING BUILDING CODE (2021EBC)
- 2021 INTERNATIONAL BUILDING CODE (2021 IBC)
- 2021 INTERNATIONAL EXISTING BUILDING CODE
- 2017 ANSI AMERICAN NATIONAL STANDARDS (ADA CODE)
- 2018 NEW MEXICO ENERGY CONSERVATION CODE
- 2019 INTERNATIONAL ENERGY CODE
- 2012 NEW MEXICO MECHANICAL CODE
- 2015 UNIFORM MECHANICAL CODE
- 2012 UNIFORM PLUMBING CODE
- 2017 NEW MEXICO ELECTRICAL CODE
- 2012 NEW MEXICO PLUMBING CODE
- 2015 INTERNATIONAL FIRE CODE (IFC)
- 2015 INTERNATIONAL MECHANICAL CODE OF THE ICC
- 2009 INTERNATIONAL ENERGY CONSERVATION CODE
- 2007 NATIONAL FIRE PROTECTION ASSOCIATION
- 2015 INTERNATIONAL FUEL GAS CODE OF THE ICC
- 2012 NEW MEXICO ELECTRICAL SAFETY CODE/NATIONAL ELECTRIC SAFETY CODE
- 1990 NATIONAL FIRE PROTECTION ASSOCIATION LIFE SAFETY CODE
- 2007 NATIONAL FIRE PROTECTION ASSOCIATION

NOTE: THE STATE FIRE CODE OF NEW MEXICO IS THE 2003 IFC, WHERE THE 2015 IBC FIRE PROTECTION REQUIREMENTS EXCEED THE 2003 IFC REQUIREMENTS, THEY WILL BE USED AS THE BASIS FOR THE DESIGN. THE 2015 IBC ALSO REFERENCES THE 2015 EDITION OF NFPA 101.

**ADDRESS**  
 NMSU CAMPUS, ON S ESPINA ST, SOUTH OF FRENGER ST, LAS CRUCES, NM 88003


**LOCATION ON PROPERTY**  
 REFERENCE SITE PLAN ON COVER SHEET.

**OCCUPANCY CLASSIFICATION**  
 IBC 309.1, IBC 304.4: OCCUPANCY GROUP B - BUSINESS (HIGHER EDUCATION)


**FIRE SPRINKLER SYSTEM** 2015 IBC SECTION 903.2.1  
 EQUIPPED THROUGHOUT WITH AND AUTOMATIC SPRINKLER SYSTEM, EXISTING TO REMAIN AND BE RECONNECTED.

**TOTAL BUILDING AREAS**


|          |           |
|----------|-----------|
| PREVIOUS | 14,835 SF |
| DEMO     | 7,842 SF  |
| REMAIN   | 6,893 SF  |

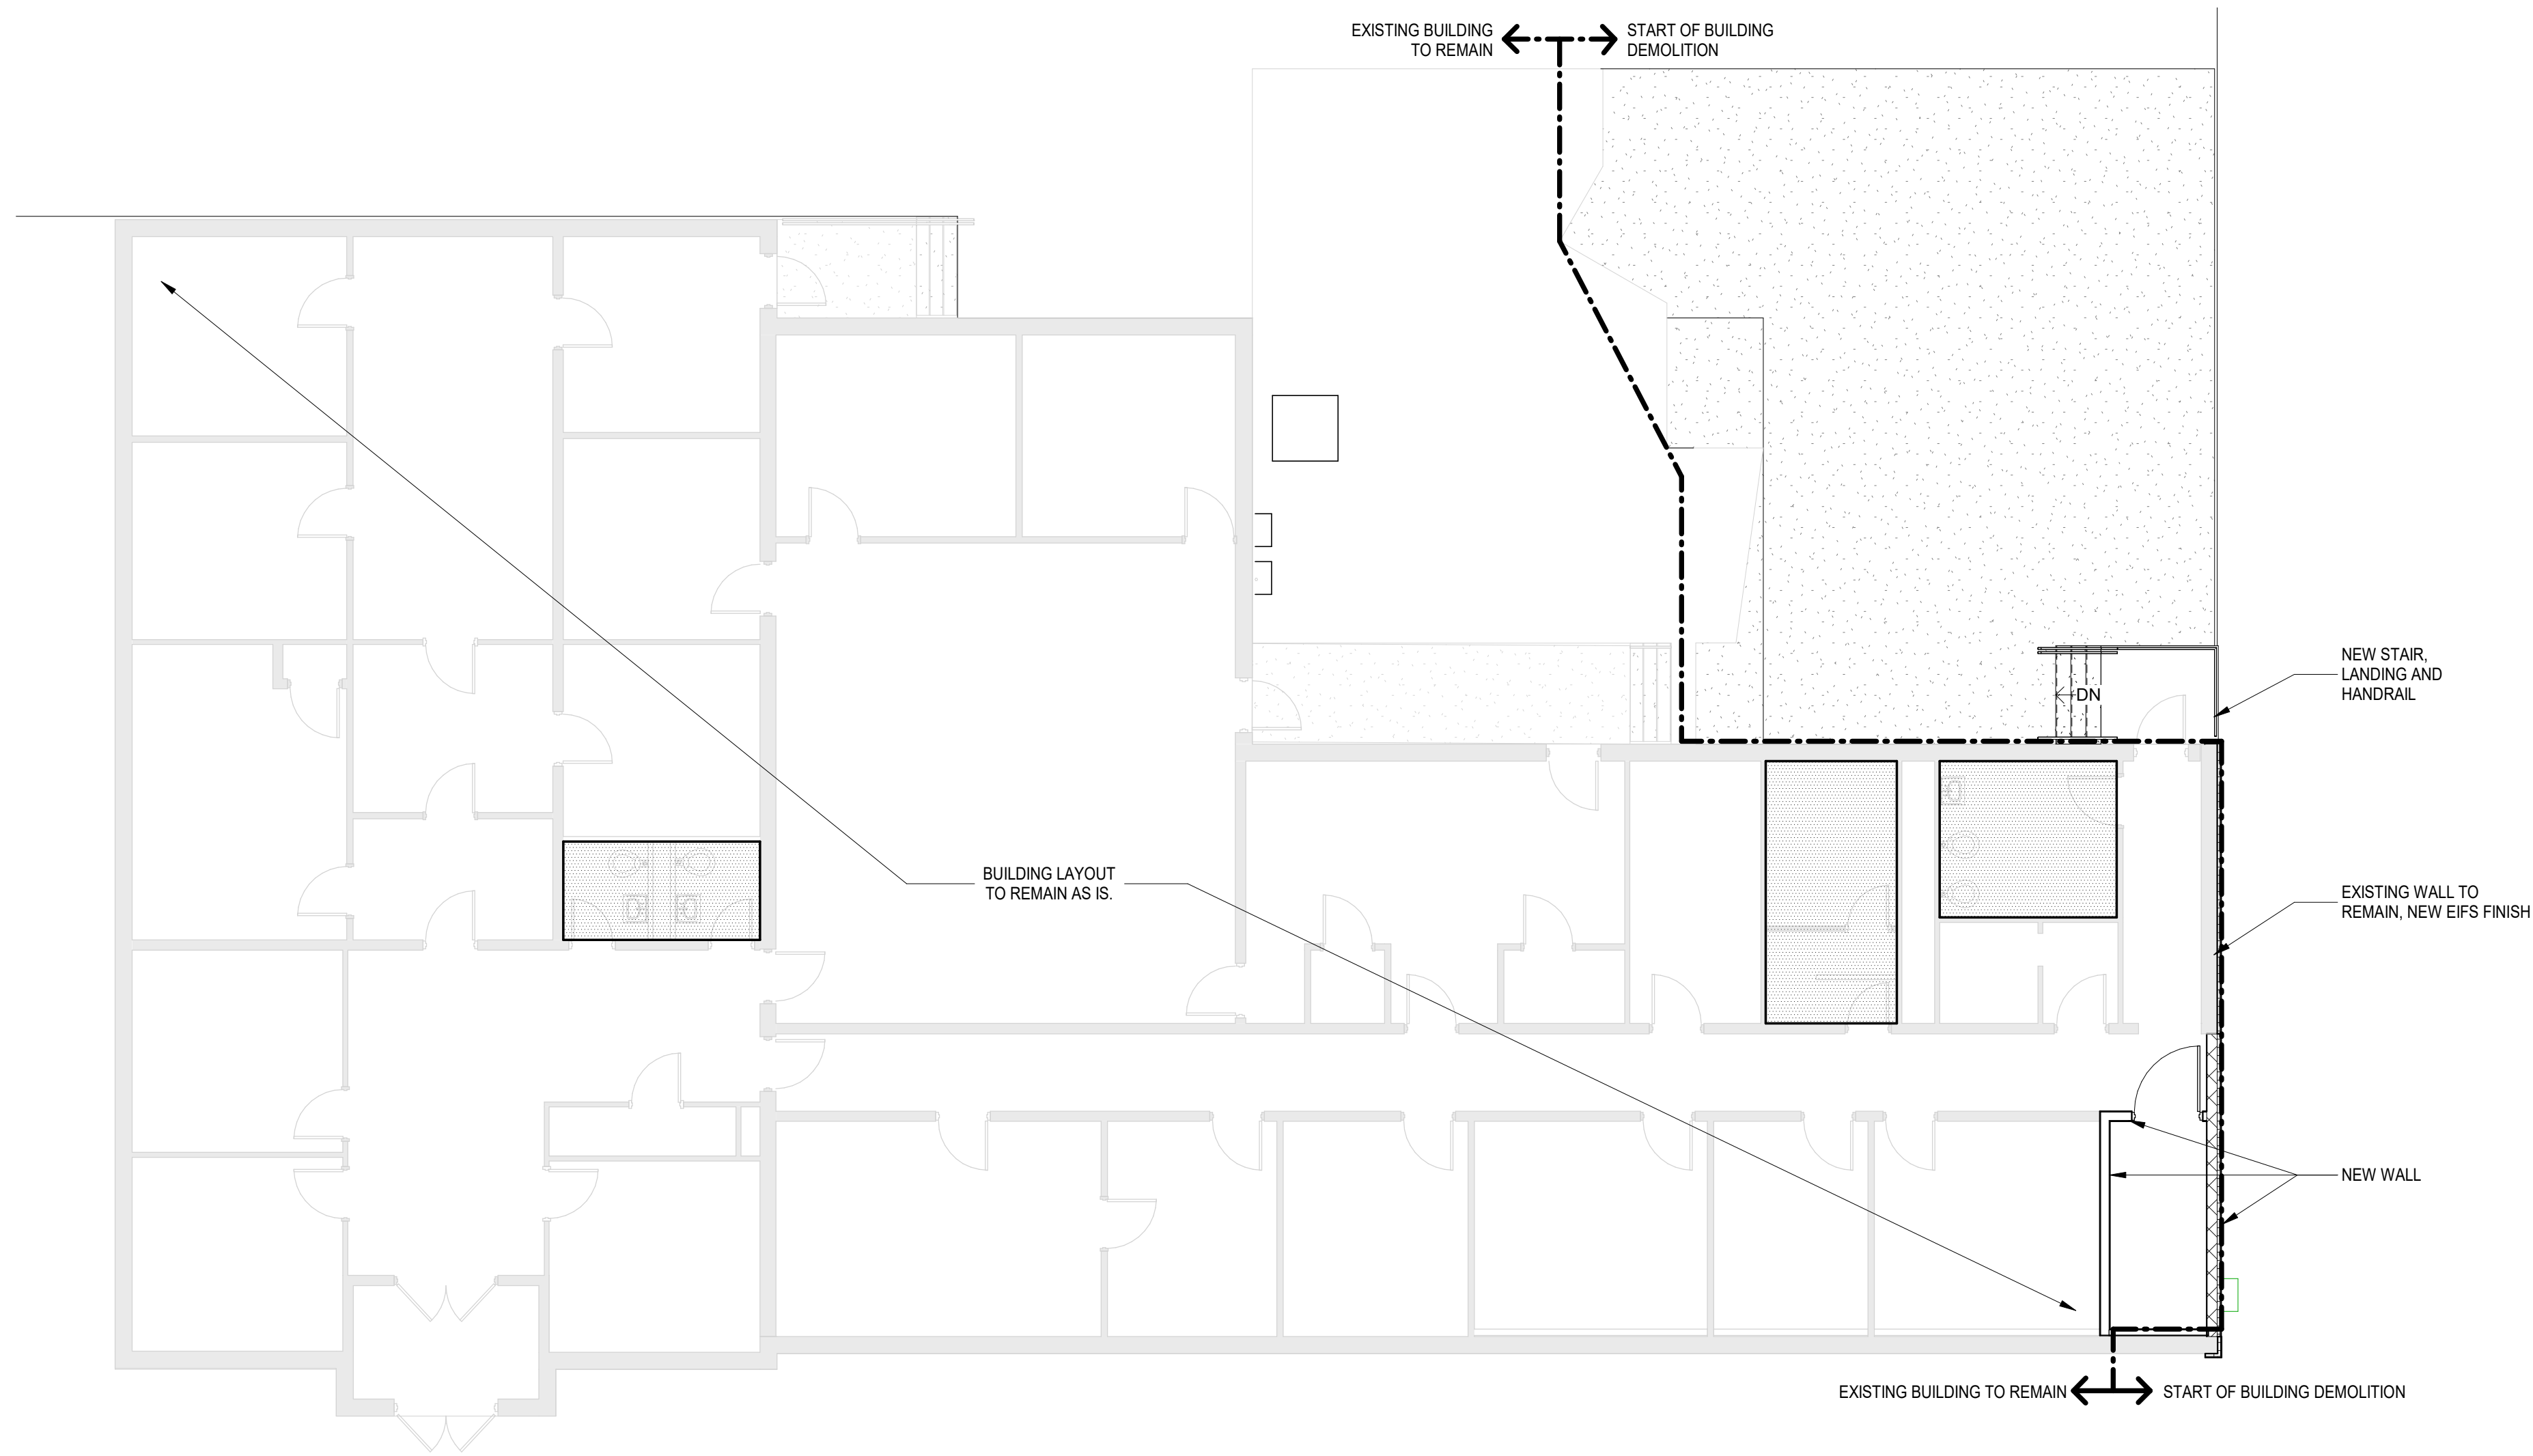

C1 OVERALL REMAINING BUILDING PLAN  
1/8" = 1'-0"

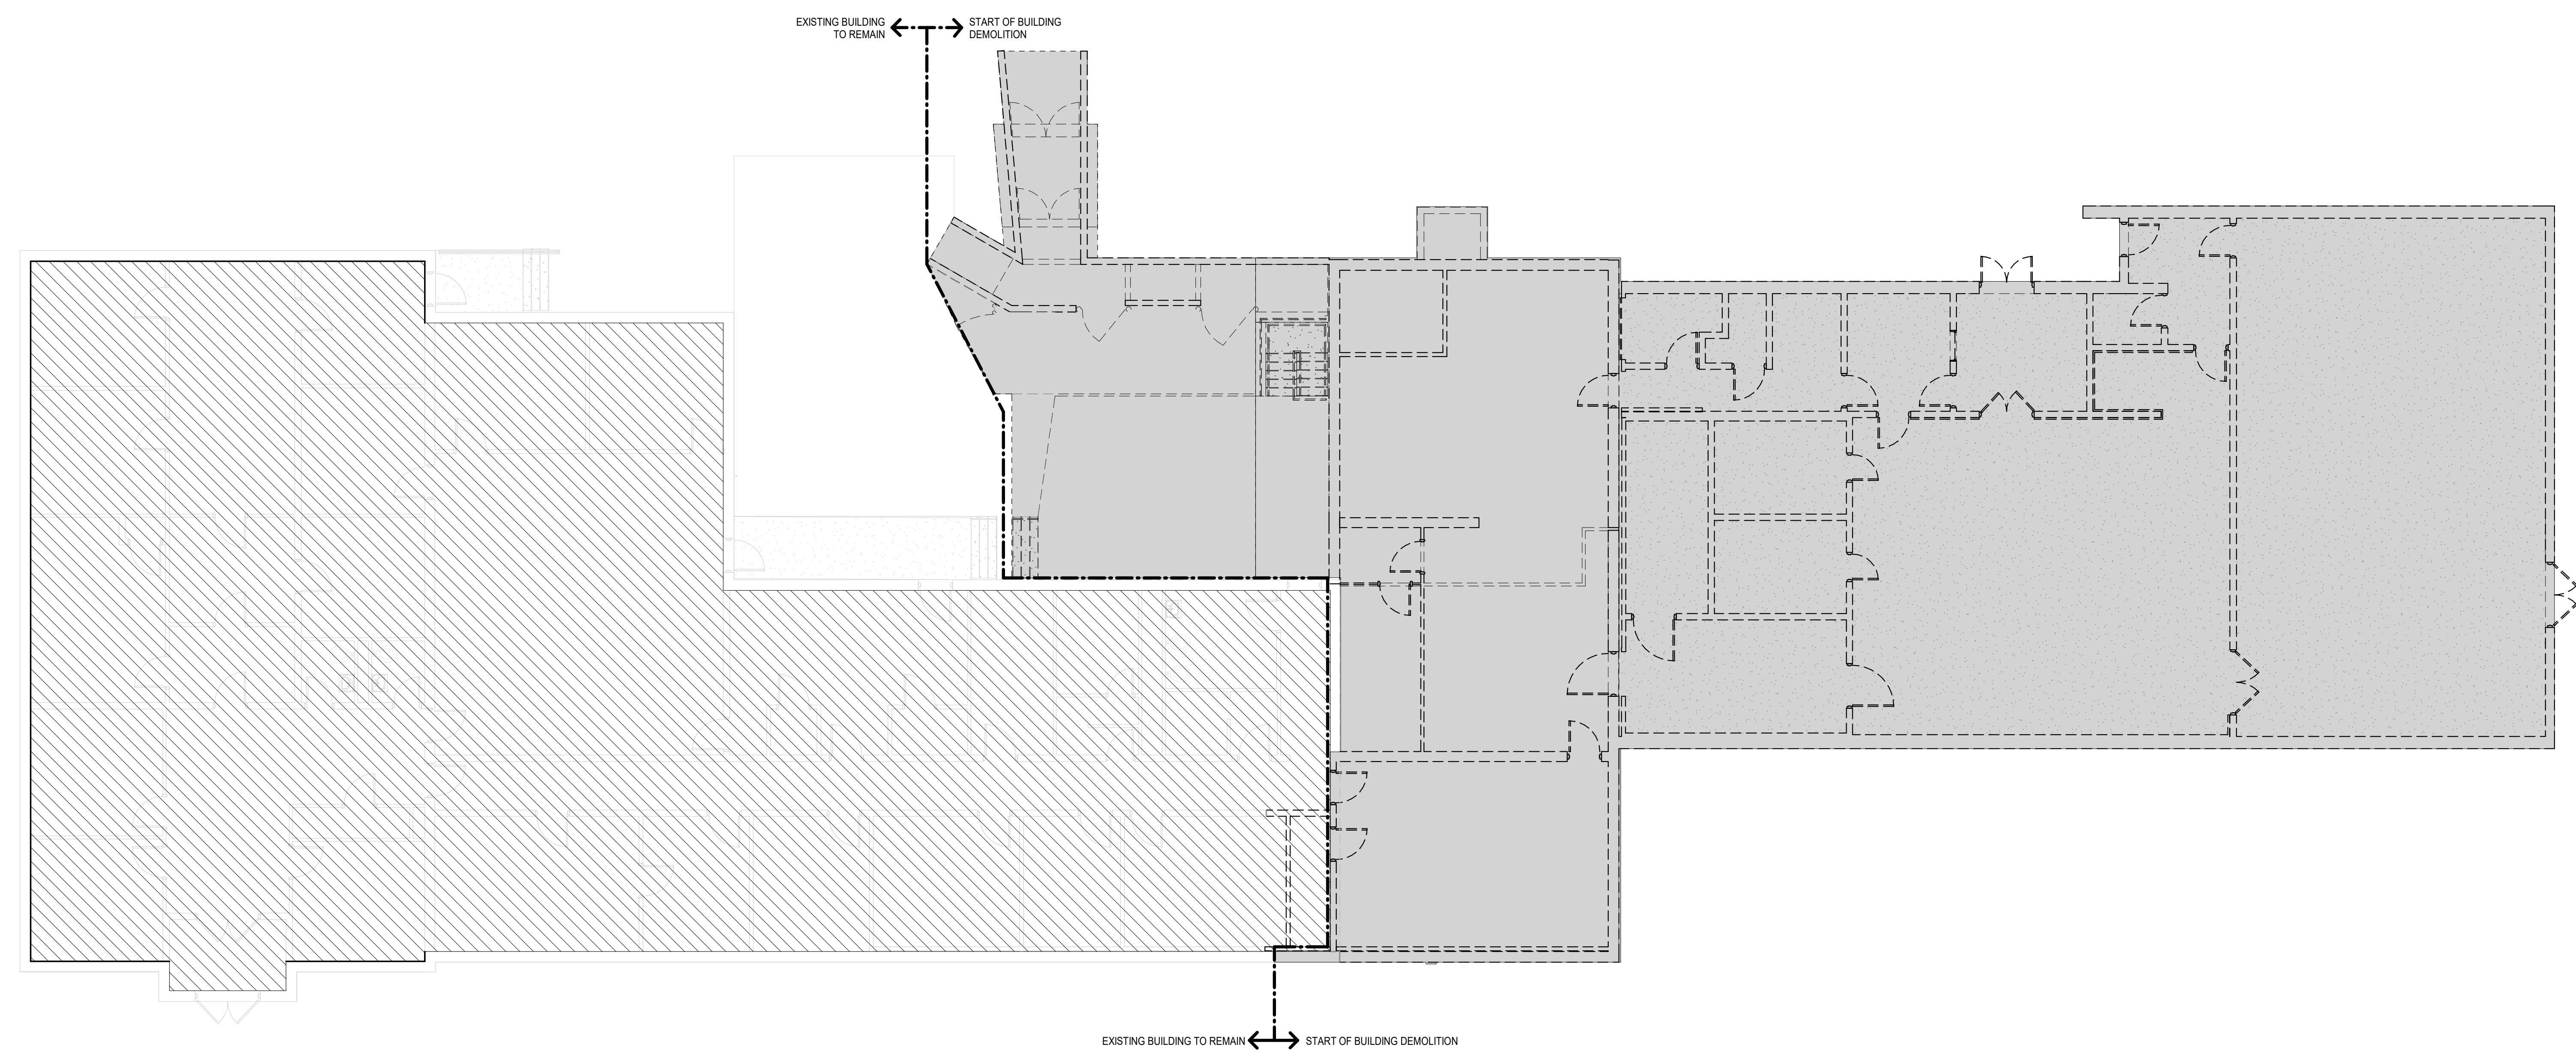

A1 OVERALL DEMOLITION PLAN  
1/8" = 1'-0"

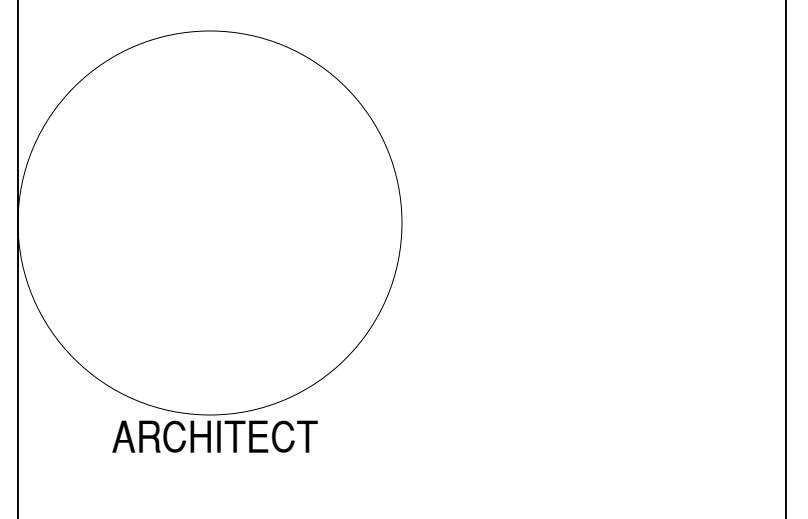

**AG MOD PHASE 3: NEALE HALL DEMO**

**95% CONSTRUCTION DOCUMENTS**


3198 S. Espina St  
 Las Cruces, NM 88001

MARCH 12, 2024

| MARK | DATE | DESCRIPTION |
|------|------|-------------|
|      |      |             |

ISSUE:  
 DATE:  
 PROJECT NO: 773B  
 DRAWN BY: JRC  
 CHECKED BY: JRC

SHEET TITLE  
 BUILDING CODE ANALYSIS

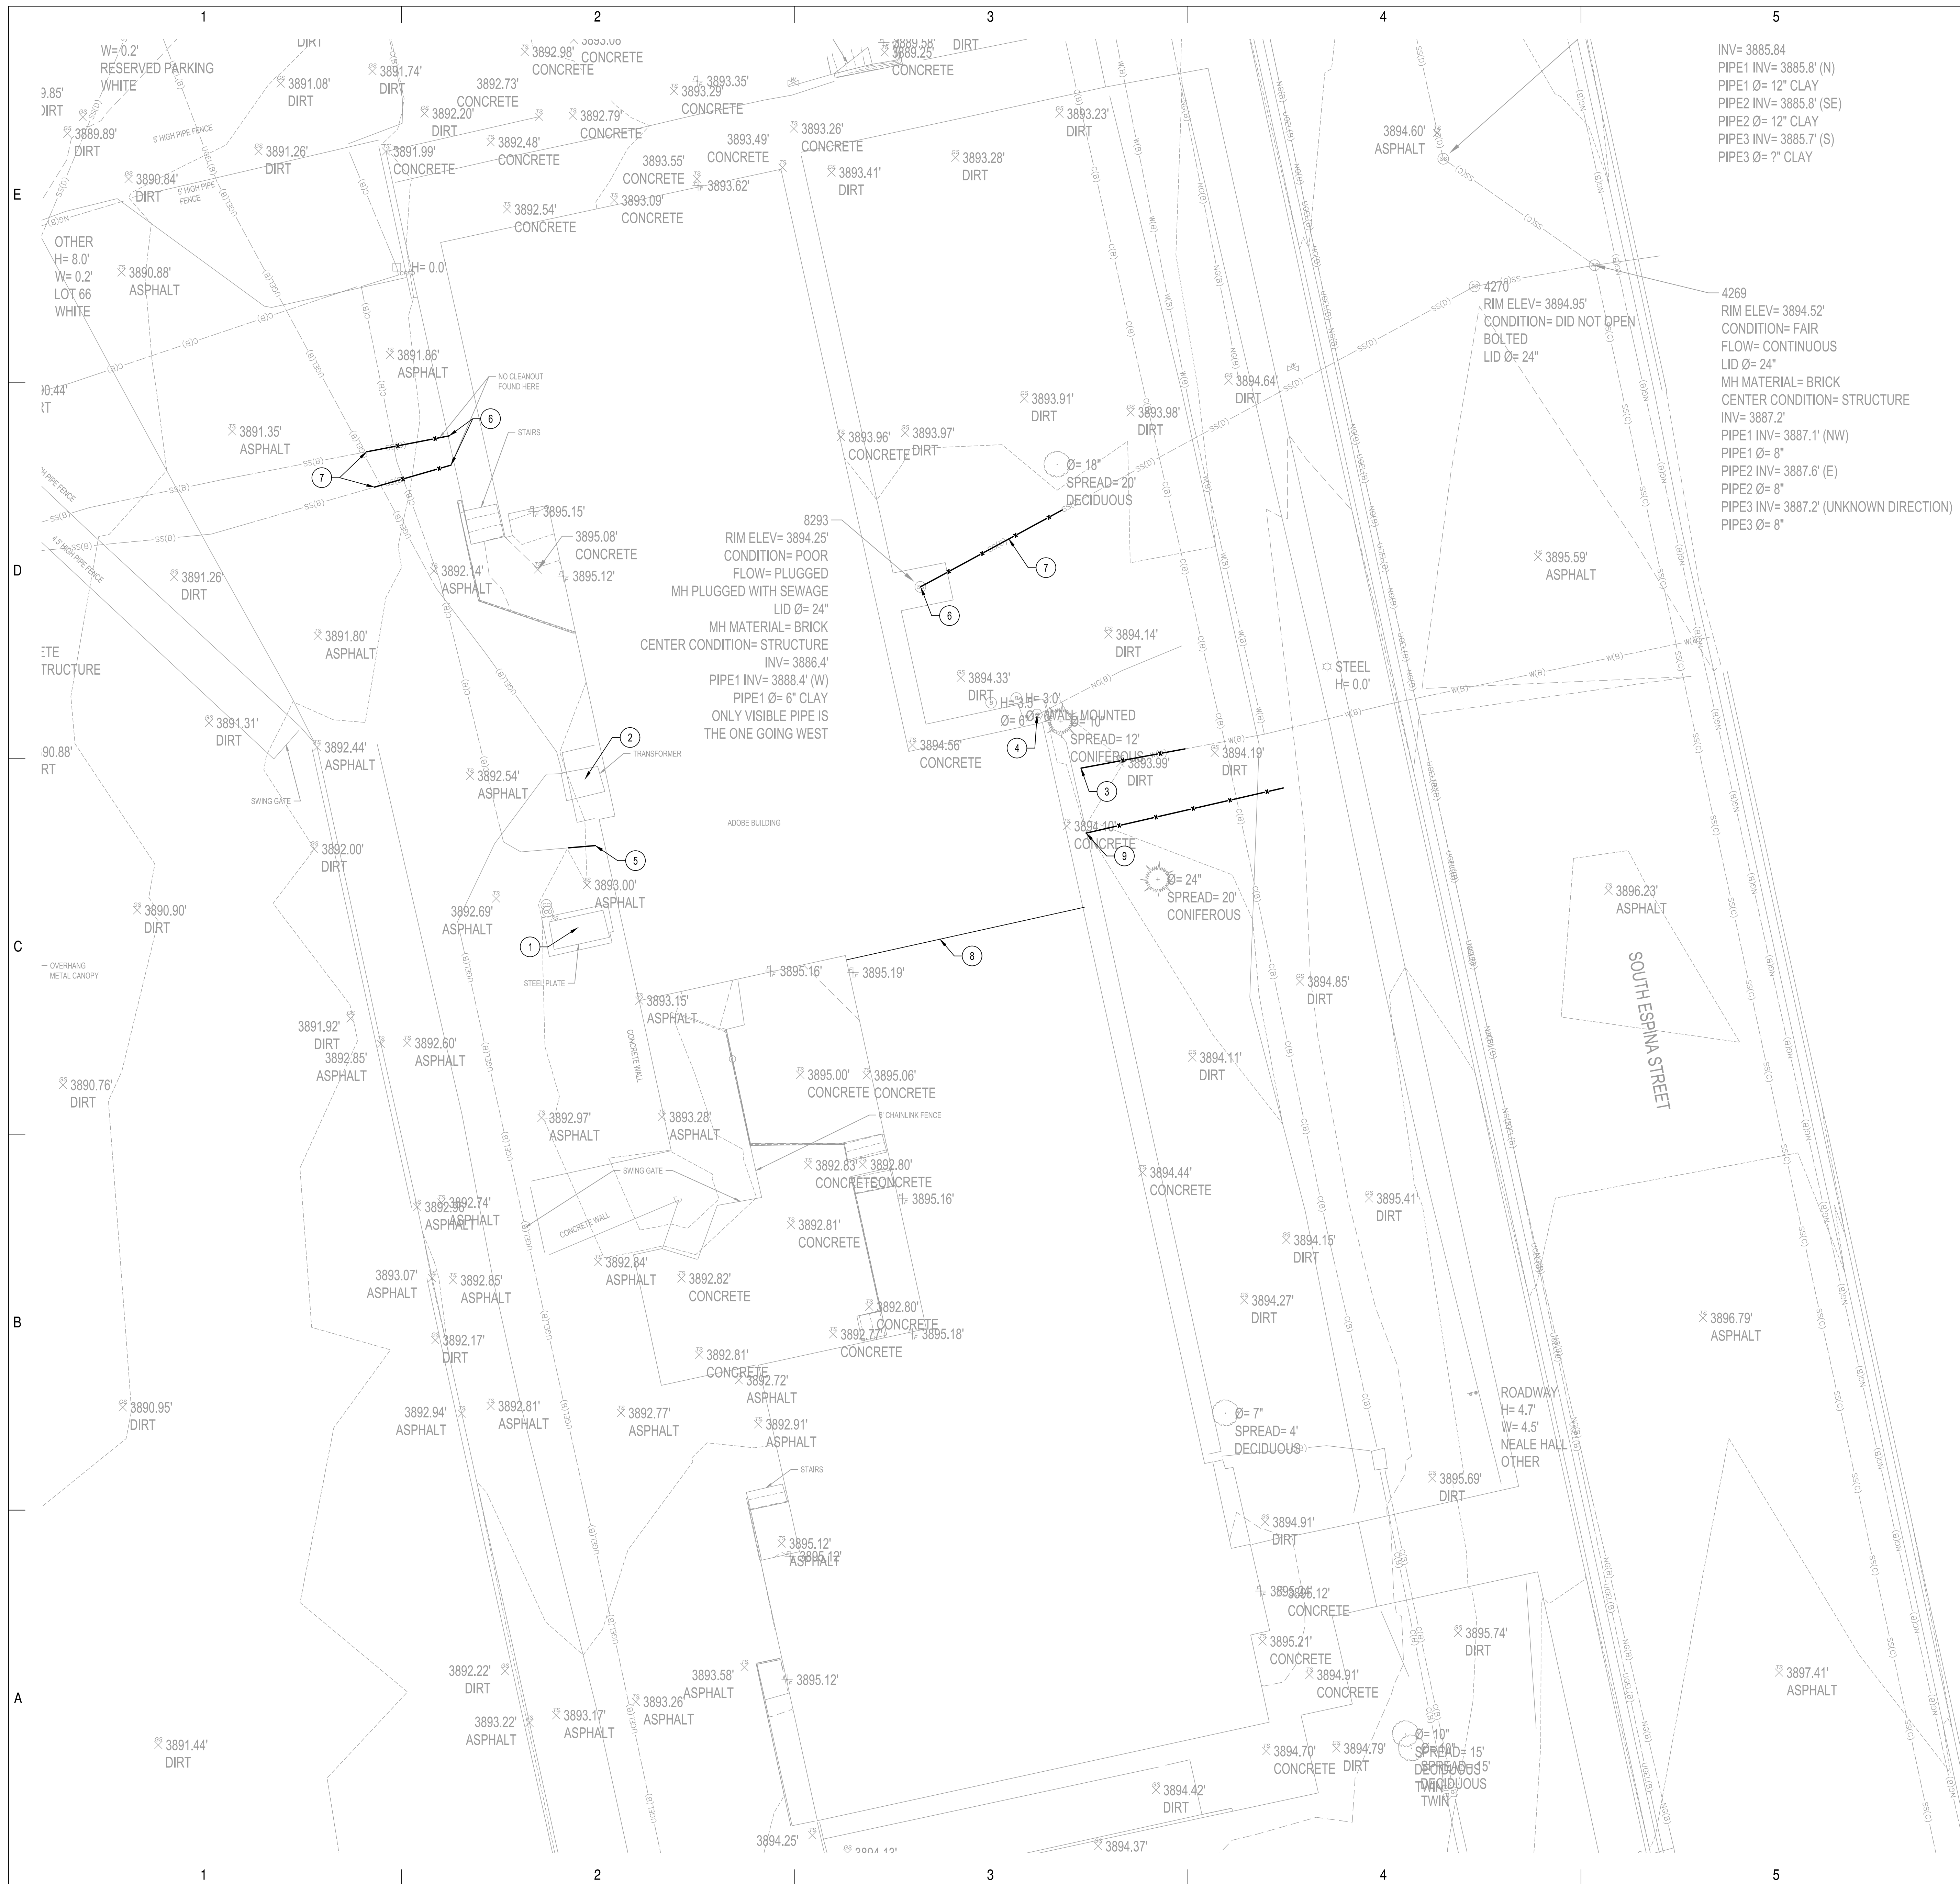

- ### GENERAL NOTES
- SEE ARCHITECTURAL PLANS FOR DEMOLITION OF BUILDING, BASEMENTS, UNDERGROUND TANKS/AREA WAYS, AND SITE RELATED FEATURES.
  - ALL EXISTING UTILITIES AND STRUCTURES ARE TO BE FIELD VERIFIED FOR SIZE, LOCATION AND DEPTH BY THE CONTRACTOR PRIOR TO START OF WORK.
  - CONTRACTOR TO CONTACT NMSU PRIOR TO BEGINNING SCOPE OF WORK TO DETERMINE WHEN DEMOLITION ACTIVITIES CAN OCCUR AND THEIR ASSOCIATED DURATIONS.
  - EXISTING UTILITIES AS SHOWN ARE BASED ON LATEST AVAILABLE TOPOGRAPHIC SURVEY INFORMATION DATED MAY 5TH, 2020.
  - CONTRACTOR TO PROVIDE SURVEYED AS-BUILTS UPON COMPLETION BY A NM LICENSED SURVEYOR. AS-BUILTS SHALL INCLUDE THE LOCATION AND DEPTH OF BELOW GRADE CAPPED UTILITIES AND ANY OTHER LARGE OBJECTS NOT COMPLETELY REMOVED. TIE SURVEY TO NMSU OR COUNTY BENCHMARKS IN THE AREA.
  - LIMITS OF DEMOLITION IS BASED ON THE PROPOSED BIOMED PHASE 3 BUILDING LIMITS.
- ### DEMO KEYED NOTES
- EXISTING UTILITY STRUCTURE AND UTILITY LINE IS UNKNOWN BUT IS IN CONFLICT WITH FUTURE DESIGN. THEREFORE THE CONTRACTOR IS TO FIELD VERIFY AND NOTIFY ENGINEER IMMEDIATELY IF THERE ARE ANY DISCREPANCIES. CONTRACTOR TO ACCOUNT FOR DEMOLITION AND REMOVAL OF SAID UTILITY LINE AND STRUCTURE. SEE GENERAL NOTE B FOR MORE INFORMATION.
  - EXISTING TRANSFORMER AND ELECTRICAL LINES TO BE REMOVED AND RELOCATED. SEE ELECTRICAL PLANS FOR MORE INFORMATION.
  - CONTRACTOR TO REMOVE 2" FIRE AND 4" DOMESTIC WATER SERVICES UP TO 5 FT FROM THE BUILDING FACE AND CAP SERVICES.
  - CONTRACTOR TO RELOCATE 3" GAS METER AND SERVICE UP TO 5 FT FROM BUILDING FACE AND CAP SERVICE. SEE MEP PLANS FOR MORE INFORMATION.
  - COMMUNICATIONS SERVICE TO BE REMOVED AS SHOWN AND CAP SERVICE. ALL WORK THAT IS TO BE DONE NEEDS TO FOLLOW THE GUIDELINES SET FORTH BY NMSU DIVISION 27 GUIDELINES. THESE GUIDELINES CAN BE FOUND HERE: <https://telecomm.nmsu.edu/communications-cabling-design-documents/>
  - CONTRACTOR TO REMOVE 4" SANITARY SEWER SERVICE AS SHOWN AND CAP SERVICE.
  - APPROXIMATE LIMITS OF PROPOSED BUILDING IN CONFLICT WITH EXISTING UTILITY.
  - LIMITS OF DEMOLITION OF BUILDING. REFER TO ARCHITECTURAL PLANS FOR MORE INFORMATION.
  - CONTRACTOR TO REMOVE STEAM LINE SERVICE BETWEEN 5-FT FROM THE BUILDING FACE TO THE SOUTH FACE OF THE BIOMED PHASE 2 BUILDING. SEE ARCHITECTURAL PLANS FOR MORE INFORMATION.



### LEGEND

|  |                                    |
|--|------------------------------------|
|  | PROPERTY LINE                      |
|  | EXISTING EASEMENT                  |
|  | EXISTING UNDERGROUND ELECTRIC LINE |
|  | EXISTING COMMUNICATIONS LINE       |
|  | EXISTING GAS LINE                  |
|  | EXISTING SANITARY SEWER LINE       |
|  | EXISTING WATER LINE                |
|  | EXISTING VALVE                     |
|  | EXISTING FIRE HYDRANT              |
|  | EXISTING SANITARY SEWER MANHOLE    |
|  | EXISTING UTILITY TO BE REMOVED     |

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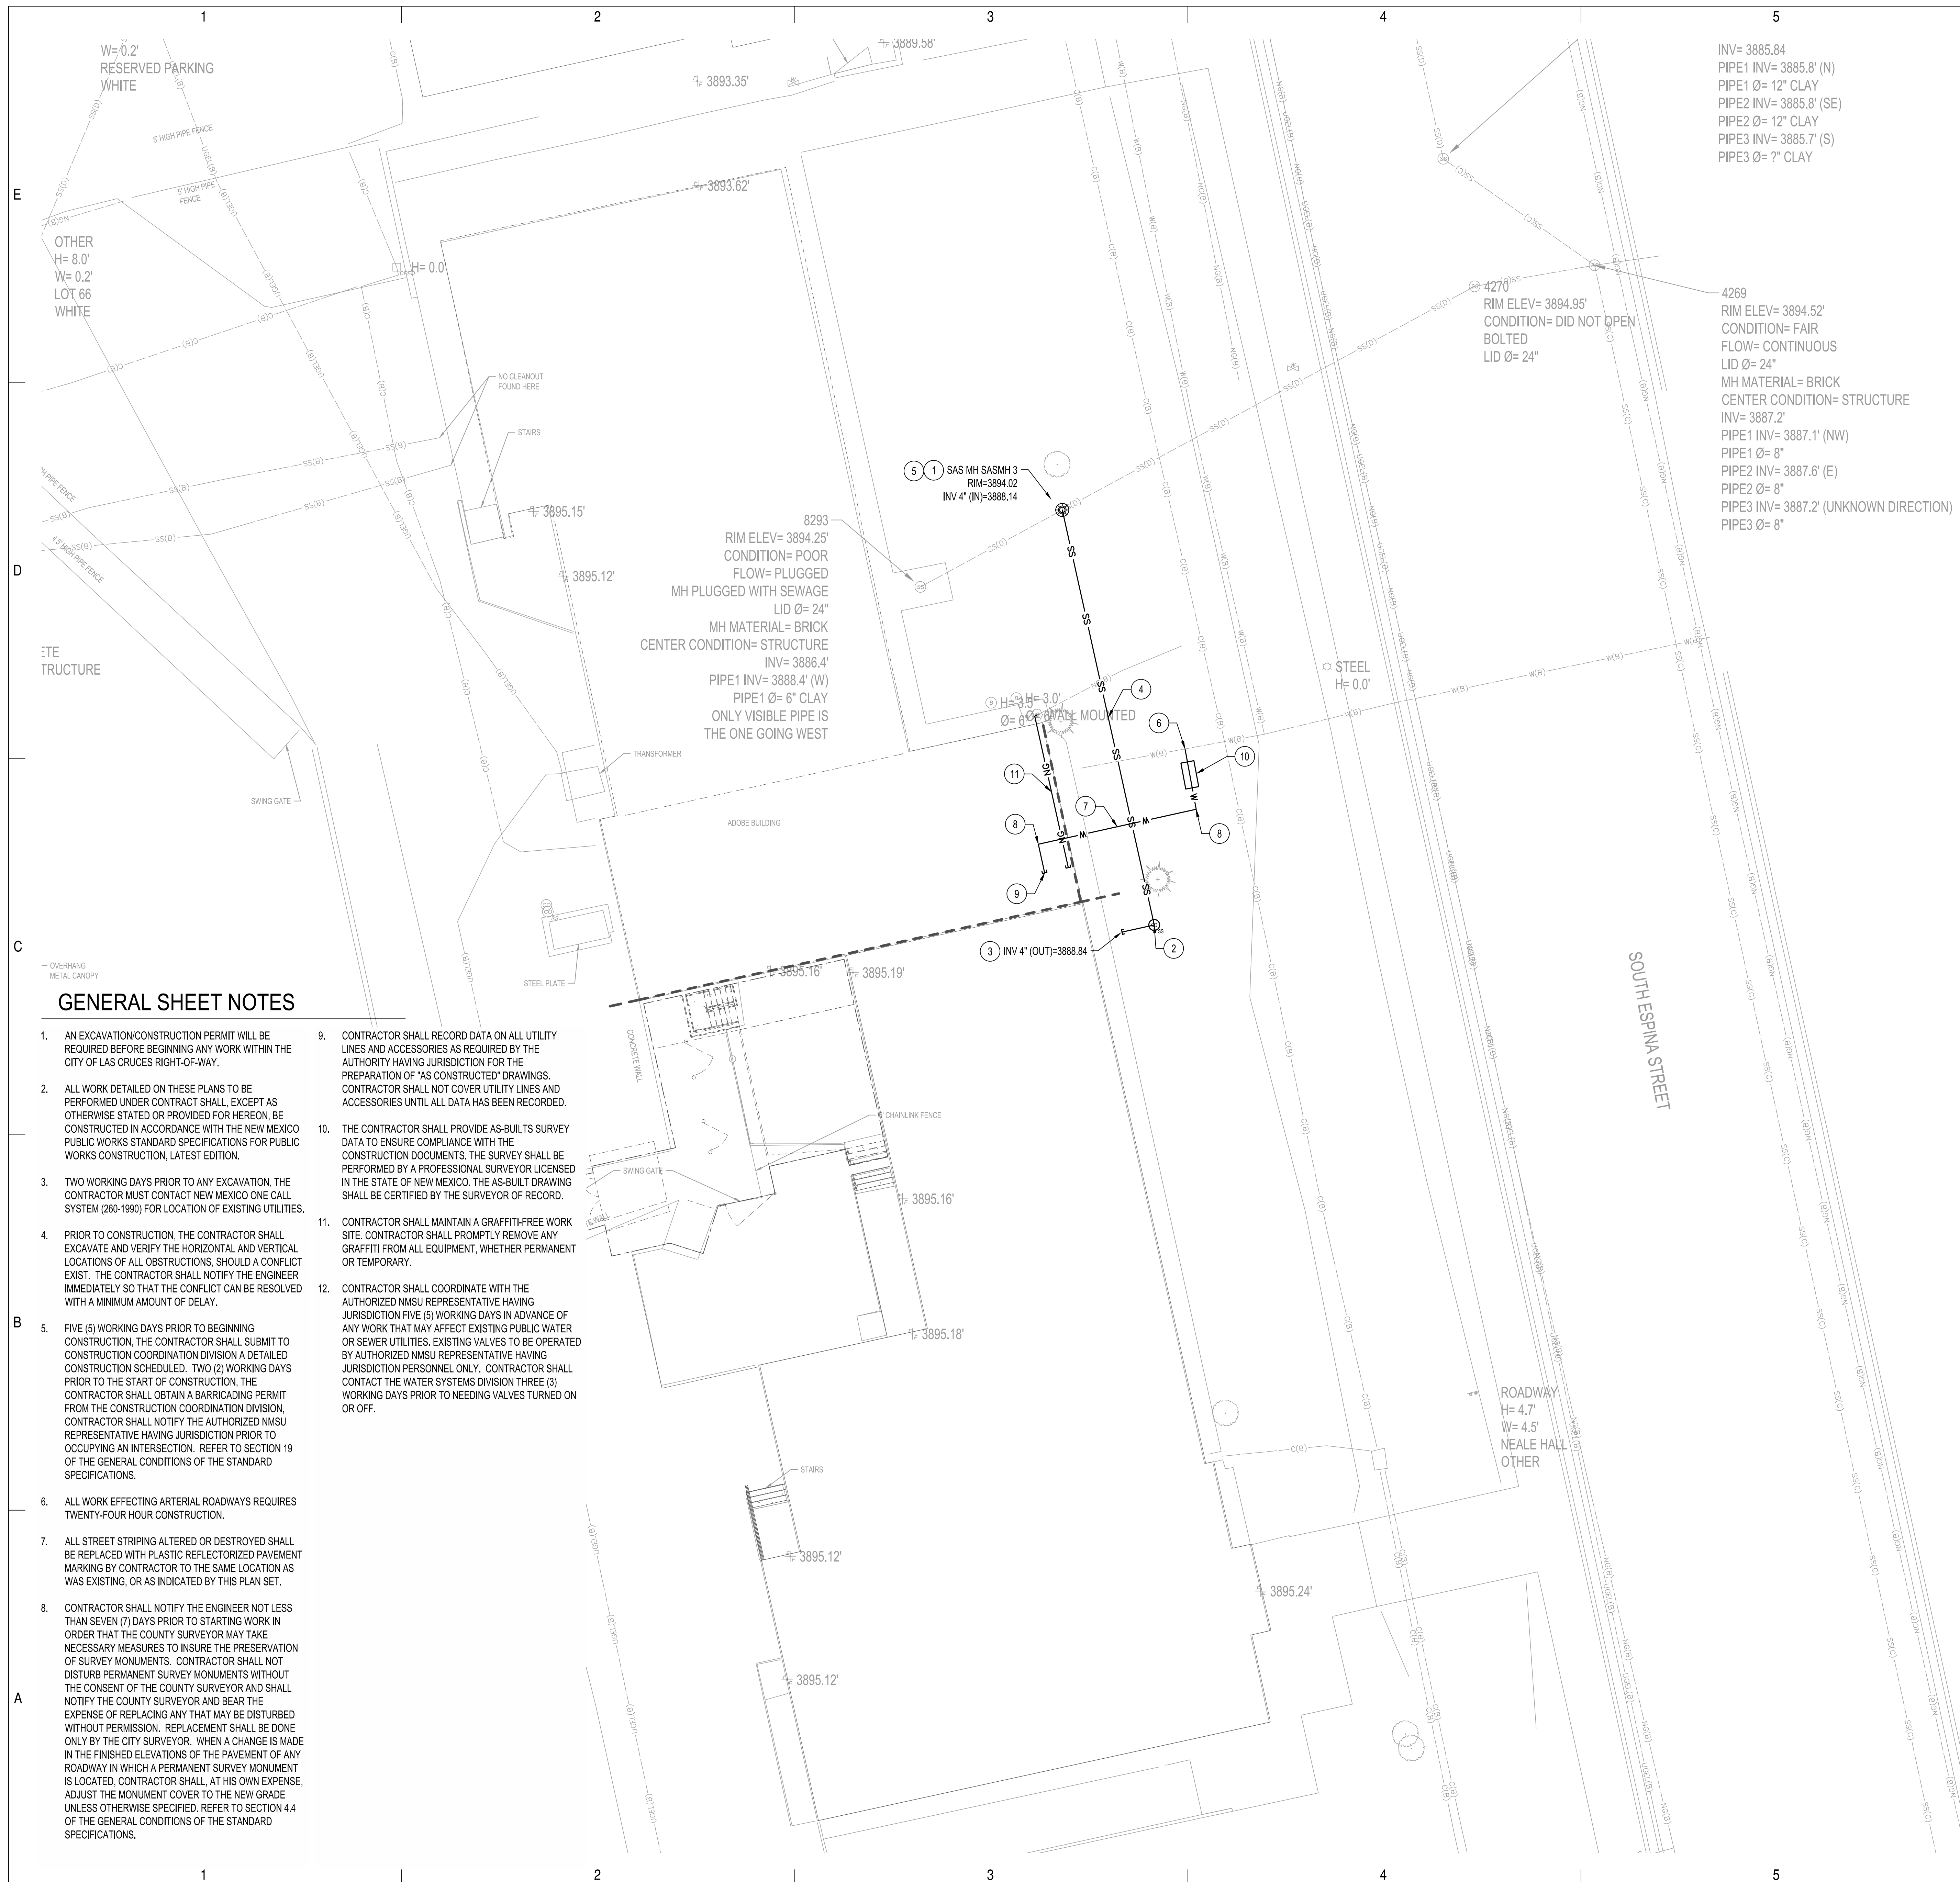
**AG MOD PHASE 3: NEALE HALL DEMO**  
**95% CONSTRUCTION DOCUMENTS**  
 3198 S. Espina St  
 Las Cruces, NM 88001  
 MARCH 12, 2024

**NM STATE**

ISSUE:  
 DATE: 03/12/2024  
 PROJECT NO: 773B  
 DRAWN BY: LS  
 CHECKED BY: AP

SHEET TITLE  
 UTILITY DEMOLITION PLAN

**CD-100**



INV= 3885.84  
 PIPE1 INV= 3885.8' (N)  
 PIPE1 Ø= 12" CLAY  
 PIPE2 INV= 3885.8' (SE)  
 PIPE2 Ø= 12" CLAY  
 PIPE3 INV= 3885.7' (S)  
 PIPE3 Ø= 7" CLAY

4269  
 RIM ELEV= 3894.52'  
 CONDITION= FAIR  
 FLOW= CONTINUOUS  
 LID Ø= 24"  
 MH MATERIAL= BRICK  
 CENTER CONDITION= STRUCTURE  
 INV= 3887.2'  
 PIPE1 INV= 3887.1' (NW)  
 PIPE1 Ø= 8"  
 PIPE2 INV= 3887.6' (E)  
 PIPE2 Ø= 8"  
 PIPE3 INV= 3887.2' (UNKNOWN DIRECTION)  
 PIPE3 Ø= 8"

8293  
 RIM ELEV= 3894.25'  
 CONDITION= POOR  
 FLOW= PLUGGED  
 MH PLUGGED WITH SEWAGE  
 LID Ø= 24"  
 MH MATERIAL= BRICK  
 CENTER CONDITION= STRUCTURE  
 INV= 3886.4'  
 PIPE1 INV= 3888.4' (W)  
 PIPE1 Ø= 6" CLAY  
 ONLY VISIBLE PIPE IS THE ONE GOING WEST

3 INV 4" (OUT)=3888.84

STEEL  
 H= 0.0'

ROADWAY  
 H= 4.7'  
 W= 4.5'  
 NEALE HALL  
 OTHER

SOUTH ESPINA STREET

**GENERAL SHEET NOTES**

- AN EXCAVATION/CONSTRUCTION PERMIT WILL BE REQUIRED BEFORE BEGINNING ANY WORK WITHIN THE CITY OF LAS CRUCES RIGHT-OF-WAY.
- ALL WORK DETAILED ON THESE PLANS TO BE PERFORMED UNDER CONTRACT SHALL, EXCEPT AS OTHERWISE STATED OR PROVIDED FOR HEREON, BE CONSTRUCTED IN ACCORDANCE WITH THE NEW MEXICO PUBLIC WORKS STANDARD SPECIFICATIONS FOR PUBLIC WORKS CONSTRUCTION, LATEST EDITION.
- TWO WORKING DAYS PRIOR TO ANY EXCAVATION, THE CONTRACTOR MUST CONTACT NEW MEXICO ONE CALL SYSTEM (260-1990) FOR LOCATION OF EXISTING UTILITIES.
- PRIOR TO CONSTRUCTION, THE CONTRACTOR SHALL EXCAVATE AND VERIFY THE HORIZONTAL AND VERTICAL LOCATIONS OF ALL OBSTRUCTIONS. SHOULD A CONFLICT EXIST, THE CONTRACTOR SHALL NOTIFY THE ENGINEER IMMEDIATELY SO THAT THE CONFLICT CAN BE RESOLVED WITH A MINIMUM AMOUNT OF DELAY.
- FIVE (5) WORKING DAYS PRIOR TO BEGINNING CONSTRUCTION, THE CONTRACTOR SHALL SUBMIT TO CONSTRUCTION COORDINATION DIVISION A DETAILED CONSTRUCTION SCHEDULED. TWO (2) WORKING DAYS PRIOR TO THE START OF CONSTRUCTION, THE CONTRACTOR SHALL OBTAIN A BARRICADING PERMIT FROM THE CONSTRUCTION COORDINATION DIVISION, CONTRACTOR SHALL NOTIFY THE AUTHORIZED NMSU REPRESENTATIVE HAVING JURISDICTION PRIOR TO OCCUPYING AN INTERSECTION. REFER TO SECTION 19 OF THE GENERAL CONDITIONS OF THE STANDARD SPECIFICATIONS.
- ALL WORK EFFECTING ARTERIAL ROADWAYS REQUIRES TWENTY-FOUR HOUR CONSTRUCTION.
- ALL STREET STRIPING ALTERED OR DESTROYED SHALL BE REPLACED WITH PLASTIC REFLECTORIZED PAVEMENT MARKING BY CONTRACTOR TO THE SAME LOCATION AS WAS EXISTING, OR AS INDICATED BY THIS PLAN SET.
- CONTRACTOR SHALL NOTIFY THE ENGINEER NOT LESS THAN SEVEN (7) DAYS PRIOR TO STARTING WORK IN ORDER THAT THE COUNTY SURVEYOR MAY TAKE NECESSARY MEASURES TO INSURE THE PRESERVATION OF SURVEY MONUMENTS. CONTRACTOR SHALL NOT DISTURB PERMANENT SURVEY MONUMENTS WITHOUT THE CONSENT OF THE COUNTY SURVEYOR AND SHALL NOTIFY THE COUNTY SURVEYOR AND BEAR THE EXPENSE OF REPLACING ANY THAT MAY BE DISTURBED WITHOUT PERMISSION. REPLACEMENT SHALL BE DONE ONLY BY THE CITY SURVEYOR. WHEN A CHANGE IS MADE IN THE FINISHED ELEVATIONS OF THE PAVEMENT OF ANY ROADWAY IN WHICH A PERMANENT SURVEY MONUMENT IS LOCATED, CONTRACTOR SHALL, AT HIS OWN EXPENSE, ADJUST THE MONUMENT COVER TO THE NEW GRADE UNLESS OTHERWISE SPECIFIED. REFER TO SECTION 4.4 OF THE GENERAL CONDITIONS OF THE STANDARD SPECIFICATIONS.
- CONTRACTOR SHALL RECORD DATA ON ALL UTILITY LINES AND ACCESSORIES AS REQUIRED BY THE AUTHORITY HAVING JURISDICTION FOR THE PREPARATION OF "AS CONSTRUCTED" DRAWINGS. CONTRACTOR SHALL NOT COVER UTILITY LINES AND ACCESSORIES UNTIL ALL DATA HAS BEEN RECORDED.
- THE CONTRACTOR SHALL PROVIDE AS-BUILTS SURVEY DATA TO ENSURE COMPLIANCE WITH THE CONSTRUCTION DOCUMENTS. THE SURVEY SHALL BE PERFORMED BY A PROFESSIONAL SURVEYOR LICENSED IN THE STATE OF NEW MEXICO. THE AS-BUILT DRAWING SHALL BE CERTIFIED BY THE SURVEYOR OF RECORD.
- CONTRACTOR SHALL MAINTAIN A GRAFFITI-FREE WORK SITE. CONTRACTOR SHALL PROMPTLY REMOVE ANY GRAFFITI FROM ALL EQUIPMENT, WHETHER PERMANENT OR TEMPORARY.
- CONTRACTOR SHALL COORDINATE WITH THE AUTHORIZED NMSU REPRESENTATIVE HAVING JURISDICTION FIVE (5) WORKING DAYS IN ADVANCE OF ANY WORK THAT MAY AFFECT EXISTING PUBLIC WATER OR SEWER UTILITIES. EXISTING VALVES TO BE OPERATED BY AUTHORIZED NMSU REPRESENTATIVE HAVING JURISDICTION PERSONNEL ONLY. CONTRACTOR SHALL CONTACT THE WATER SYSTEMS DIVISION THREE (3) WORKING DAYS PRIOR TO NEEDING VALVES TURNED ON OR OFF.

**UTILITY GENERAL NOTES**



- THIS CONTRACTOR SHALL BE RESPONSIBLE FOR THE COMPLETE INSTALLATION OF ALL WORK RELATED TO MECHANICAL UTILITIES AS SHOWN ON THIS PLAN INCLUDING: TRENCHING, BACKFILL, SUPPORTS, CLEANOUT PADS, SERVICE STOPS AND BOXES, SERVICE LINES, TESTING, CLEANING AND STERILIZING. ANY WORK NOT ACCEPTED BY THE ARCHITECT OR ENGINEER DUE TO IMPROPER WORKMANSHIP OR LACK OF PROPER COORDINATION SHALL BE REMOVED AND CORRECTLY INSTALLED AT THE CONTRACTOR'S EXPENSE, AS DIRECTED.
- MINIMUM DEPTHS OF COVER SHALL BE: 36" FOR WATERLINES AND 48" FOR SEWER, EXCEPT AT BUILDING CONNECTION.
- ALL WORK DETAILED ON THESE PLANS TO BE PERFORMED UNDER CONTRACT SHALL, EXCEPT AS OTHERWISE STATED OR PROVIDED FOR HEREON, BE CONSTRUCTED IN ACCORDANCE WITH THE IAPMO UNIFORM PLUMBING CODE & NFPA 24, LATEST EDITION.
- UTILITY LINES SHALL BE INSTALLED PRIOR TO PAVEMENT, CURB AND GUTTER, AND/OR SIDEWALK, AS APPLICABLE.
- ROUGH GRADING OF SITE (40.5') SHALL BE COMPLETED PRIOR TO INSTALLATION OF UTILITY LINES.
- CONTRACTOR WILL BE RESPONSIBLE FOR CONNECTIONS TO BUILDING DRAIN LINES AND ALL NECESSARY FITTINGS.
- ALL VALVES SHALL BE ANCHORED PER NMAPWA STANDARD DWG. 2333.
- FIRE LINES SHALL USE PIPE MATERIALS UNDERWRITERS LABORATORIES LISTED AND APPROVED FOR FIRE SERVICE.
- CONTRACTOR SHALL BE RESPONSIBLE FOR ALL WATER METER, FIRE LINE, AND SEWER HOOKUP FEES FOR INSTALLATIONS. OWNER SHALL BE RESPONSIBLE FOR UTILITY EXPANSION CHARGES, PRORATA AND OTHER SPECIAL ASSESSMENTS.
- CONTRACTOR SHALL VERIFY INVERTS AND LOCATIONS OF EXISTING WATER/SAS LINES PRIOR TO BEGINNING WORK. ALL CONFLICTS SHALL BE BROUGHT TO ATTENTION OF THE ENGINEER AND RESOLVED PRIOR TO BEGINNING WORK.
- CONTRACTOR SHALL NOTIFY THE AUTHORITY HAVING JURISDICTION PRIOR TO INSTALLATION OF FIRE SERVICE LINES, AND PRIOR TO TESTING OF ALL WATERLINES. CONTRACTOR SHALL COMPLETE, SIGN, AND SUBMIT THE "CONTRACTOR'S MATERIAL & TEST CERTIFICATE FOR UNDERGROUND PIPING" IN ACCORDANCE WITH NFPA 24.
- ADJUST ALL EXISTING DISTURBED UTILITY APPURTENANCES, INCLUDING, BUT NOT LIMITED TO CLEANOUTS, VALVE COVERS, ETC. TO FINISHED GRADE.
- CONTRACTOR IS RESPONSIBLE FOR COMPLETING A FIRE PRESSURE/FLOW TEST PRIOR TO THE START OF CONSTRUCTION AND COORDINATING WITH NMSU AS NEEDED. CONTRACTOR TO PROVIDE RESULTS TO THE ENGINEER PRIOR TO THE START OF CONSTRUCTION.

**UTILITY KEYED NOTES**

- CONNECT TO EXISTING SANITARY SEWER LINE. CONTRACTOR TO FIELD VERIFY SIZE, LOCATION, AND DEPTH OF EXISTING SANITARY SEWER LINE PRIOR TO ORDERING MATERIALS. NOTIFY ENGINEER IMMEDIATELY IF THERE ARE ANY DISCREPANCIES WITH THE PROPOSED DESIGN.
- INSTALL SANITARY SEWER CLEANOUT PER NMSU DETAIL UT-S3.
- INSTALL SANITARY SEWER SERVICE TO WITHIN 5' OF BUILDING. INSTALL VERTICAL SANITARY SEWER RISER. SEE PLUMBING PLANS FOR CONTINUATION.
- INSTALL 4" PVC SDR 35 SAS LINE PER NMSU DETAIL UT-S1.
- INSTALL SANITARY SEWER MANHOLE PER NMSU DETAIL UT-S4.
- INSTALL WET CONNECTION PER NMSU DETAIL UT-W2. CONNECT TO EXISTING WATER LINE. CONTRACTOR TO VERIFY SIZE, DEPTH, AND LOCATION OF EXISTING WATER LINE PRIOR TO ORDERING MATERIALS. NOTIFY ENGINEER IMMEDIATELY IF THERE ARE ANY DISCREPANCIES WITH THE PROPOSED DESIGN.
- INSTALL 4" DOMESTIC WATER LINE PER UT-W1 AND UT-W9.
- INSTALL 90° BEND (SIZE PER PLAN) WITH RESTRAINT JOINTS.
- INSTALL DOMESTIC SERVICE LINE TO WITHIN 5' OF BUILDING. SEE PLUMBING PLANS FOR CONTINUATION.
- INSTALL DOMESTIC BACKFLOW PREVENTION DEVICE WITHIN HEATED ENCLOSURE. BACKFLOW DEVICE SHALL COMPLY WITH THE CITY OF LAS CRUCES APPLICABLE BACKFLOW ORDINANCES. SEE ELECTRICAL PLANS FOR MORE INFORMATION ON POWER CONNECTION.
- INSTALL 3" GAS SERVICE LINE. SEE MEP PLANS FOR MORE INFORMATION.

**LEGEND**

|  |                                    |
|--|------------------------------------|
|  | PROPERTY LINE                      |
|  | EXISTING EASEMENT                  |
|  | EXISTING UNDERGROUND ELECTRIC LINE |
|  | EXISTING COMMUNICATIONS LINE       |
|  | EXISTING GAS LINE                  |
|  | EXISTING SANITARY SEWER LINE       |
|  | EXISTING WATER LINE                |
|  | EXISTING VALVE                     |
|  | EXISTING FIRE HYDRANT              |
|  | EXISTING SANITARY SEWER MANHOLE    |
|  | PROPOSED GAS LINE                  |
|  | PROPOSED WATER LINE                |
|  | PROPOSED SANITARY SEWER LINE       |
|  | PROPOSED CAP                       |
|  | PROPOSED MANHOLE                   |
|  | PROPOSED CLEANOUT                  |

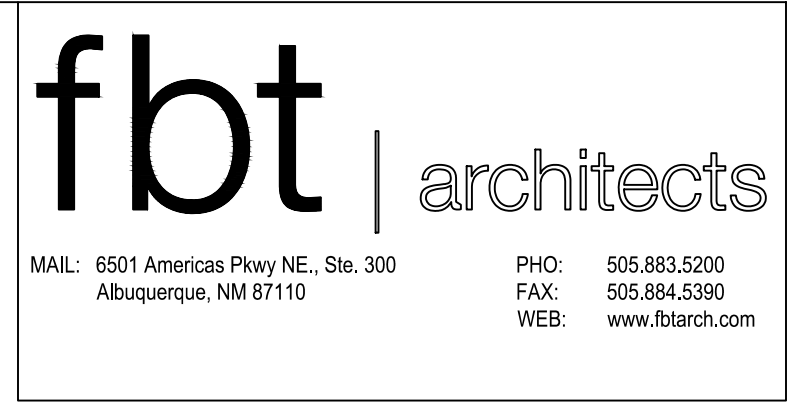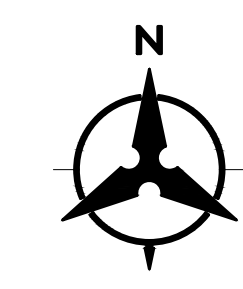


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**AG MOD PHASE 3: NEALE HALL DEMO**  
**95% CONSTRUCTION DOCUMENTS**  
 3198 S. Espina St  
 Las Cruces, NM 88001  
 MARCH 12, 2024

ISSUE:  
 DATE: 03/12/2024  
 PROJECT NO: 773B  
 DRAWN BY: LS  
 CHECKED BY: AP

SHEET TITLE  
 UTILITY PLAN

**C-100**

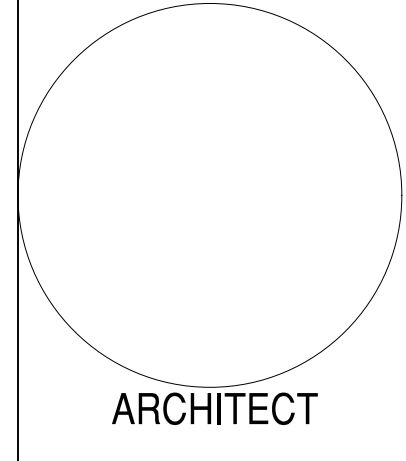

**DEMOLITION / PROCEDURE NOTES**

1. INSTALL TEMPORARY POST SHORES IN THE EXISTING BASEMENT PRIOR TO DEMOLITION OPERATIONS.
2. SAWCUT ROOF JOISTS AND DECK AT EXISTING WALL TO REMAIN PRIOR TO REMOVAL OF THE EXISTING ROOF.
3. SAWCUT MAIN LEVEL FLOOR SLAB AND FLOOR JOISTS AT REMAINING WALL SURFACE PRIOR TO REMOVAL.
4. SAWCUT UPPER AND LOWER LEVEL INTERSECTING WALLS AT THE SURFACE OF THE WALL TO REMAIN PRIOR TO REMOVAL.
5. SAWCUT AND REMOVE BASEMENT SLAB UP TO TEMPORARY BRACES AND BASEMENT WALLS.
6. BEGIN BACKFILL OPERATIONS TO BRING SITE TO GRADE. CONTRACTOR SHALL PROVIDE BACKFILL PLAN THAT DESCRIBES RE.OVAL OF TEMPORARY BRACES AND REMAINING BASEMENT SLAB ON GRADE WHILE PREVENTING DEFLECTION OF REMAINING BASEMENT WALL.





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**AG MOD PHASE 3: NEALE HALL DEMO**  
**Progress Set**


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 Las Cruces, New Mexico 88001  
 MARCH 14, 2024

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ISSUE: \_\_\_\_\_  
 DATE: \_\_\_\_\_  
 PROJECT NO: \_\_\_\_\_  
 DRAWN BY: KV  
 CHECKED BY: MJW

SHEET TITLE  
 FOUNDATION & BASEMENT FLOOR FRAMING & ROOF FRAMING PLANS

**S-101**

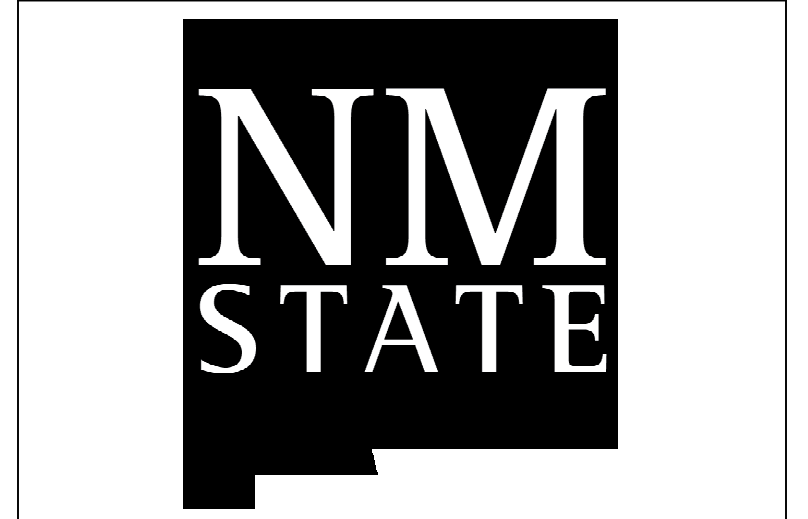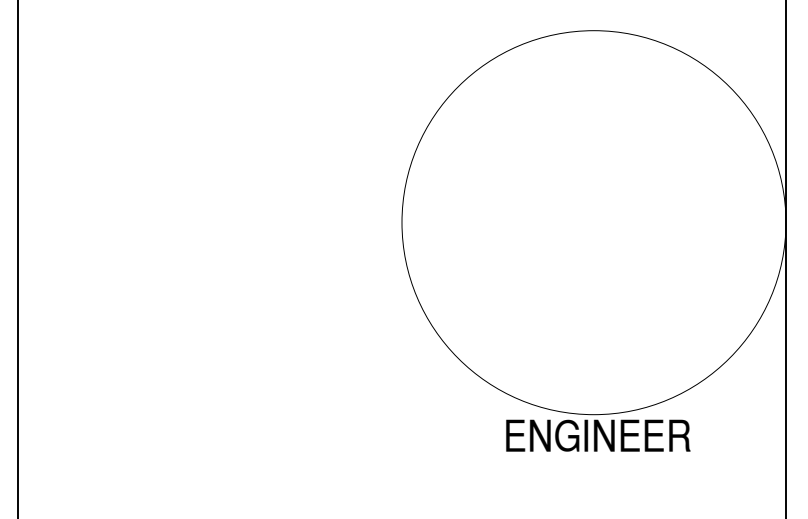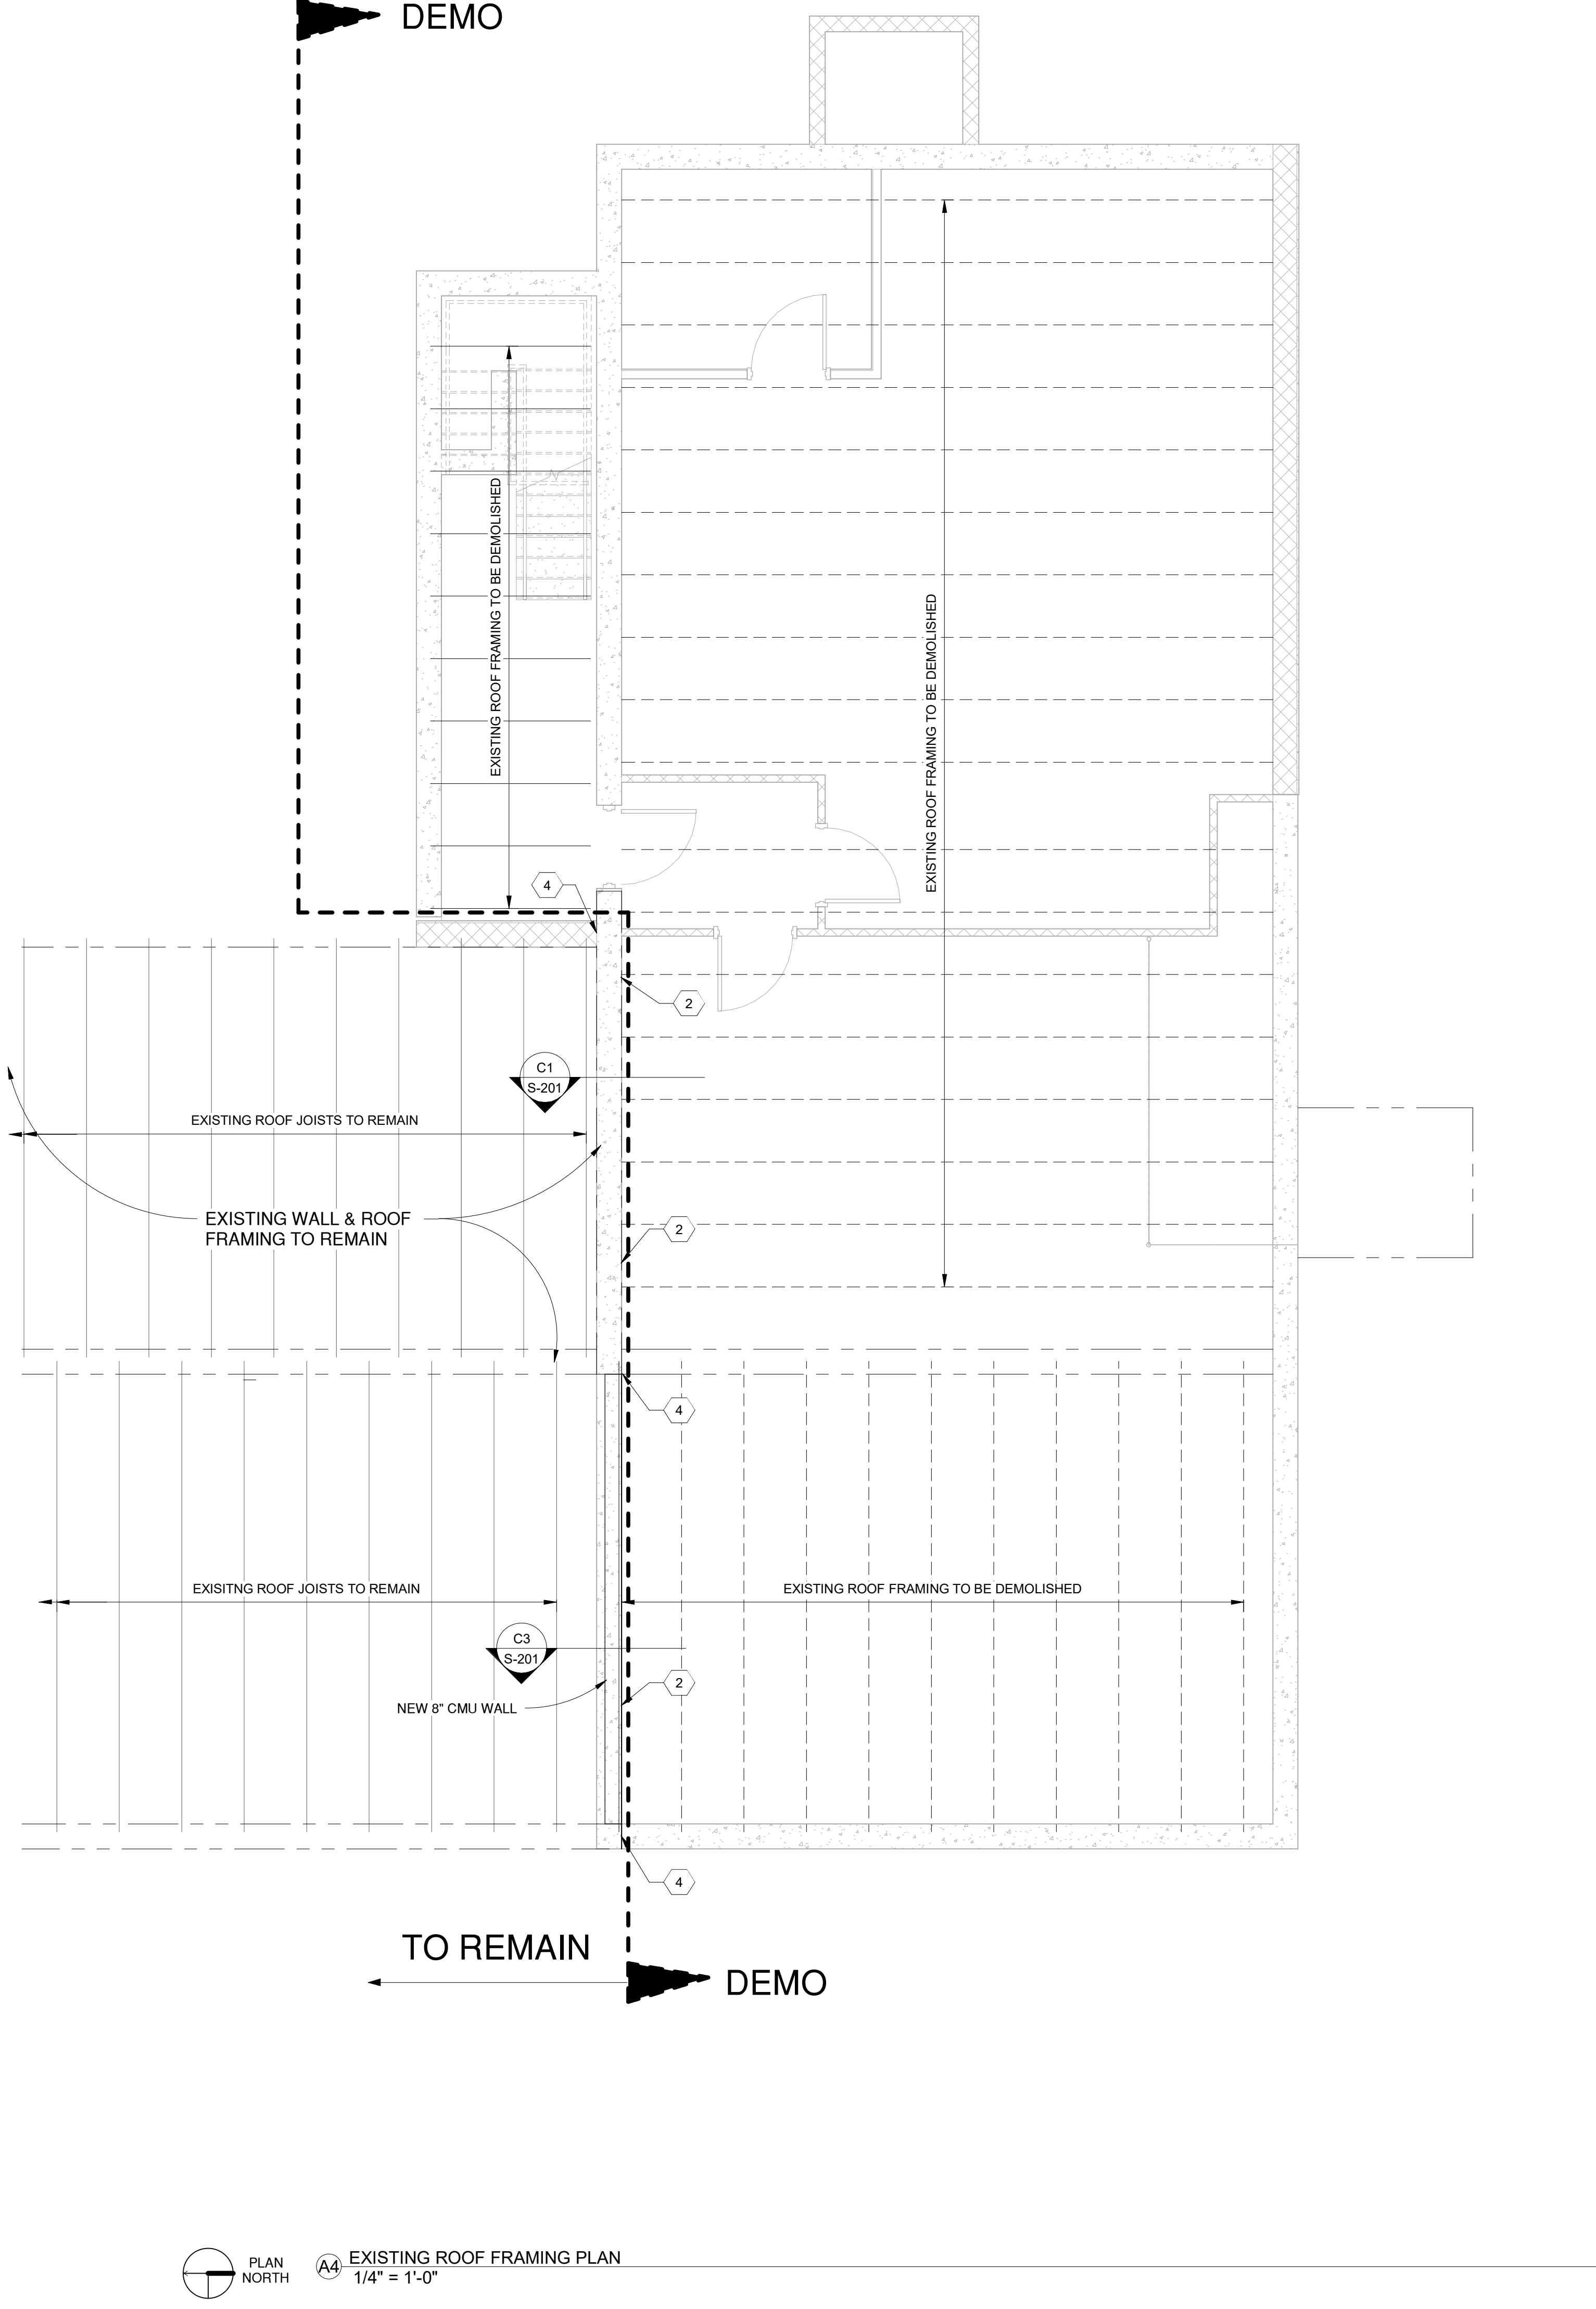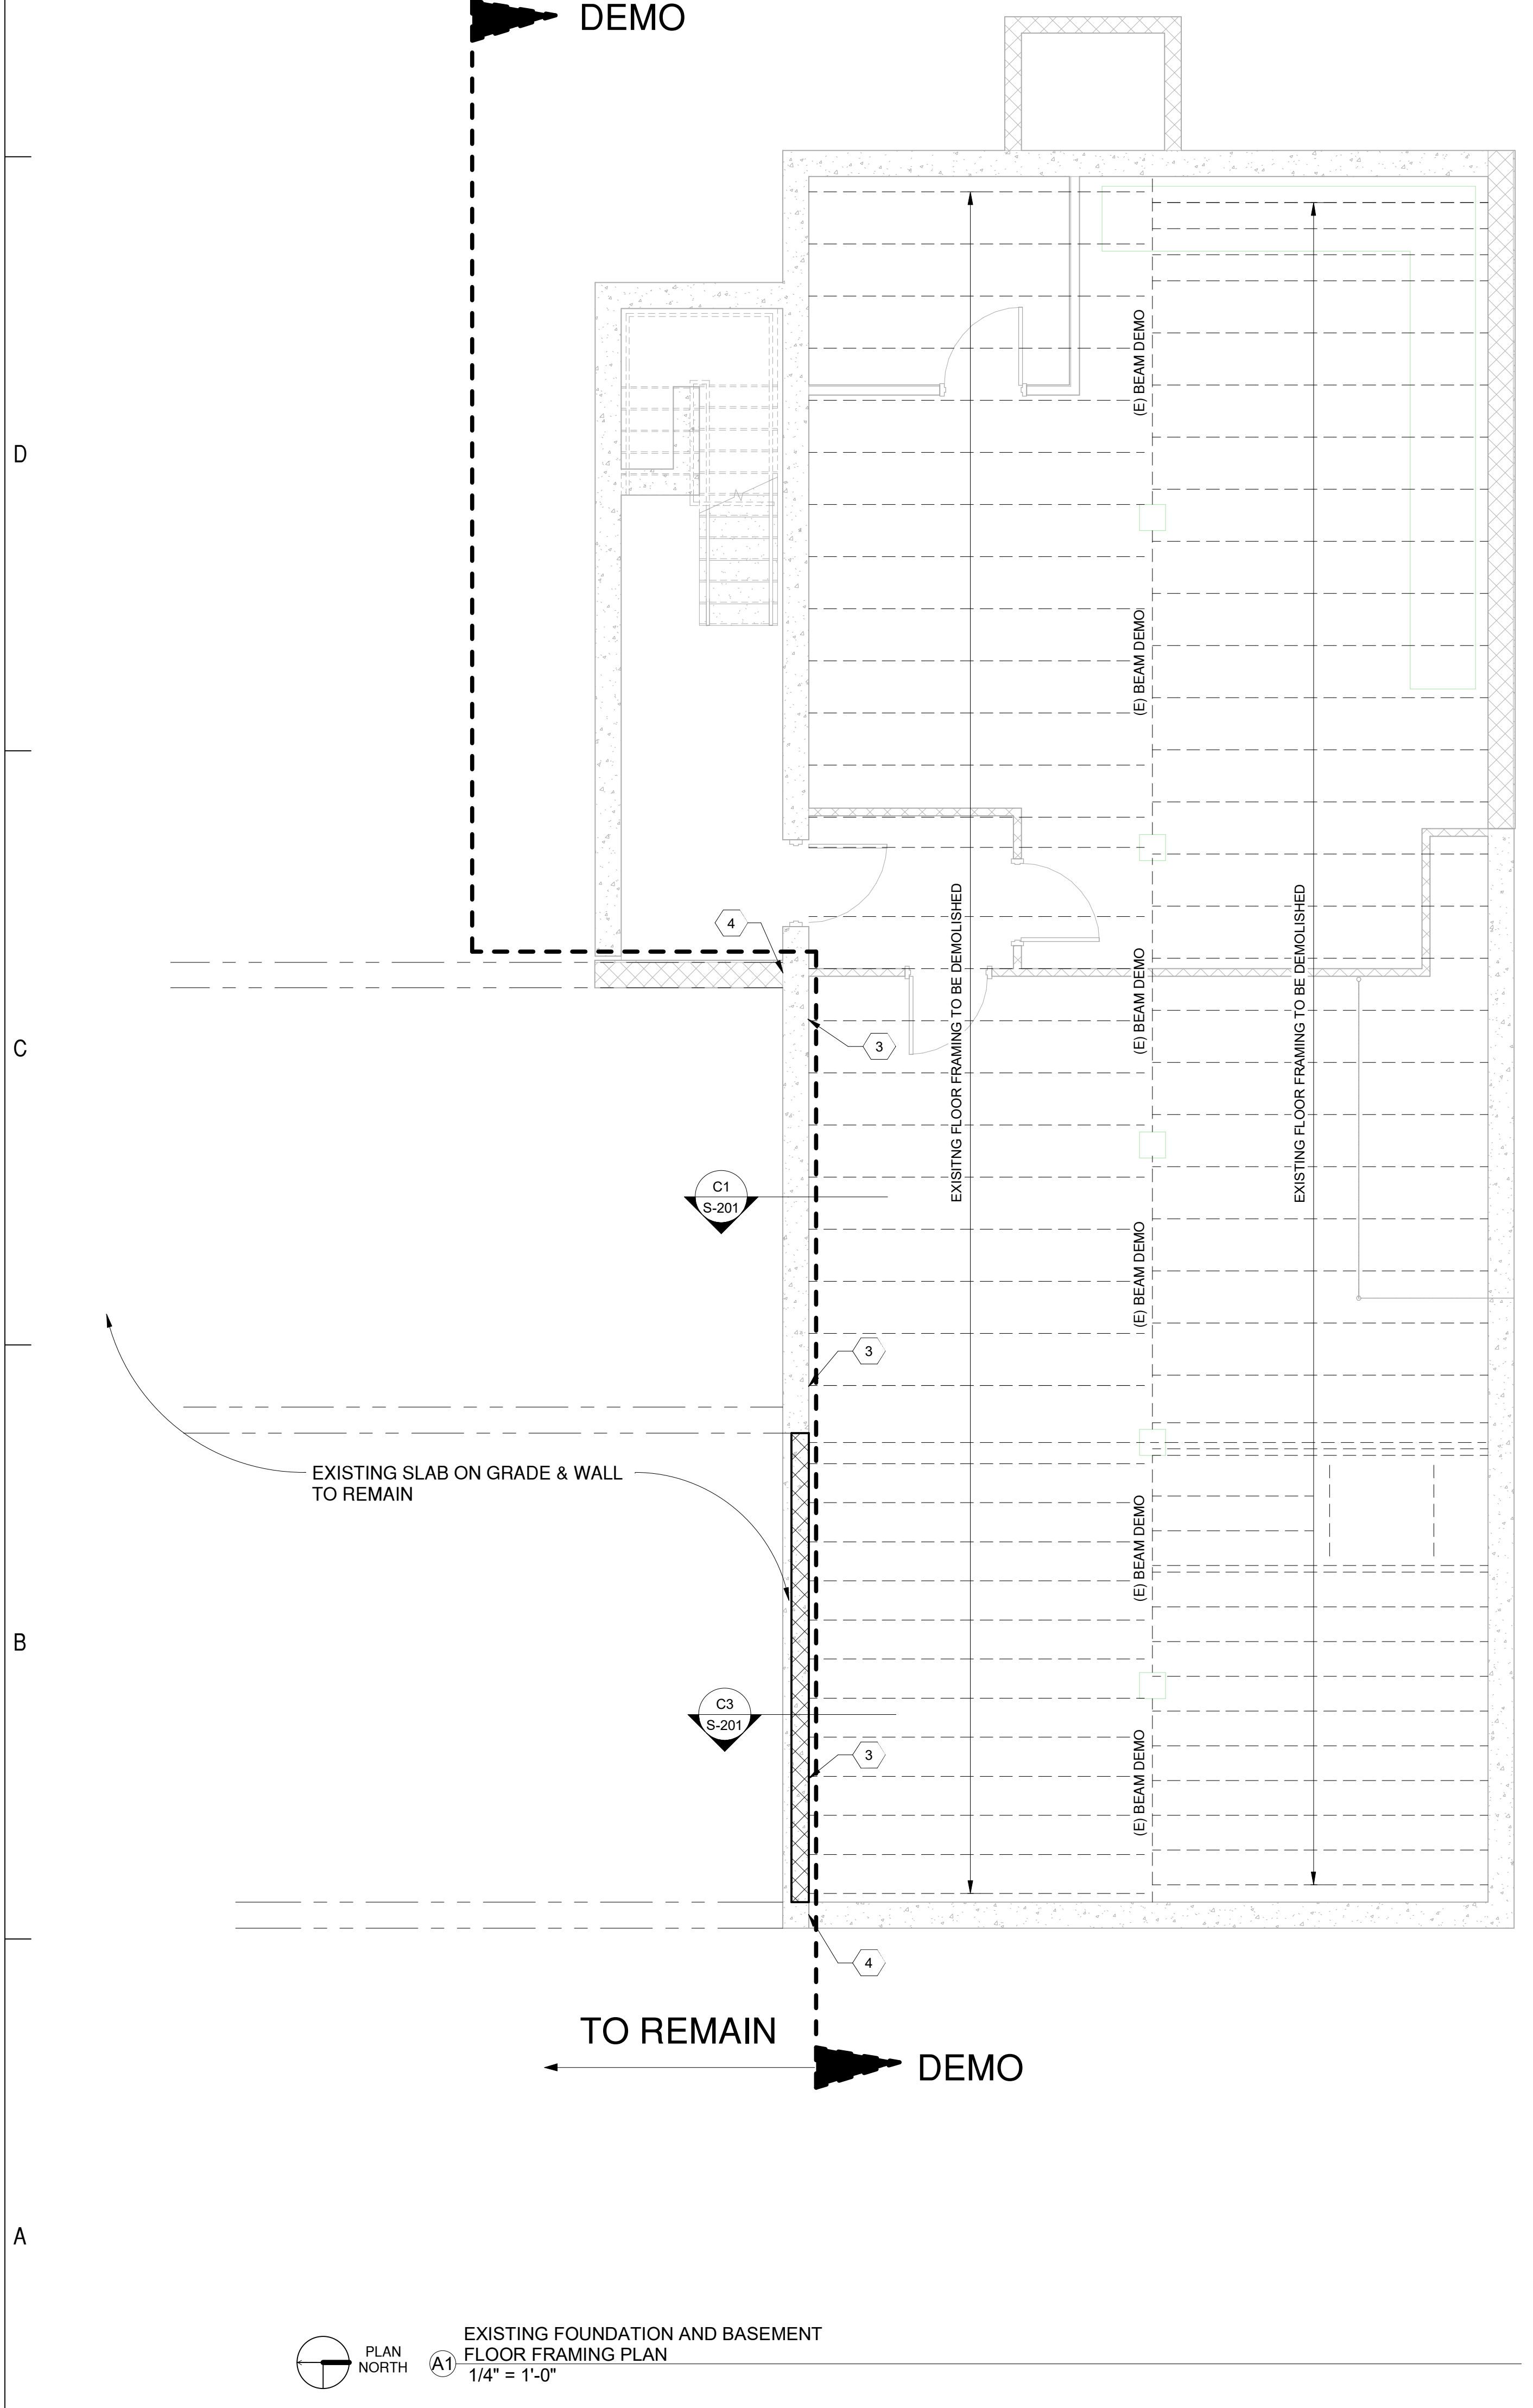

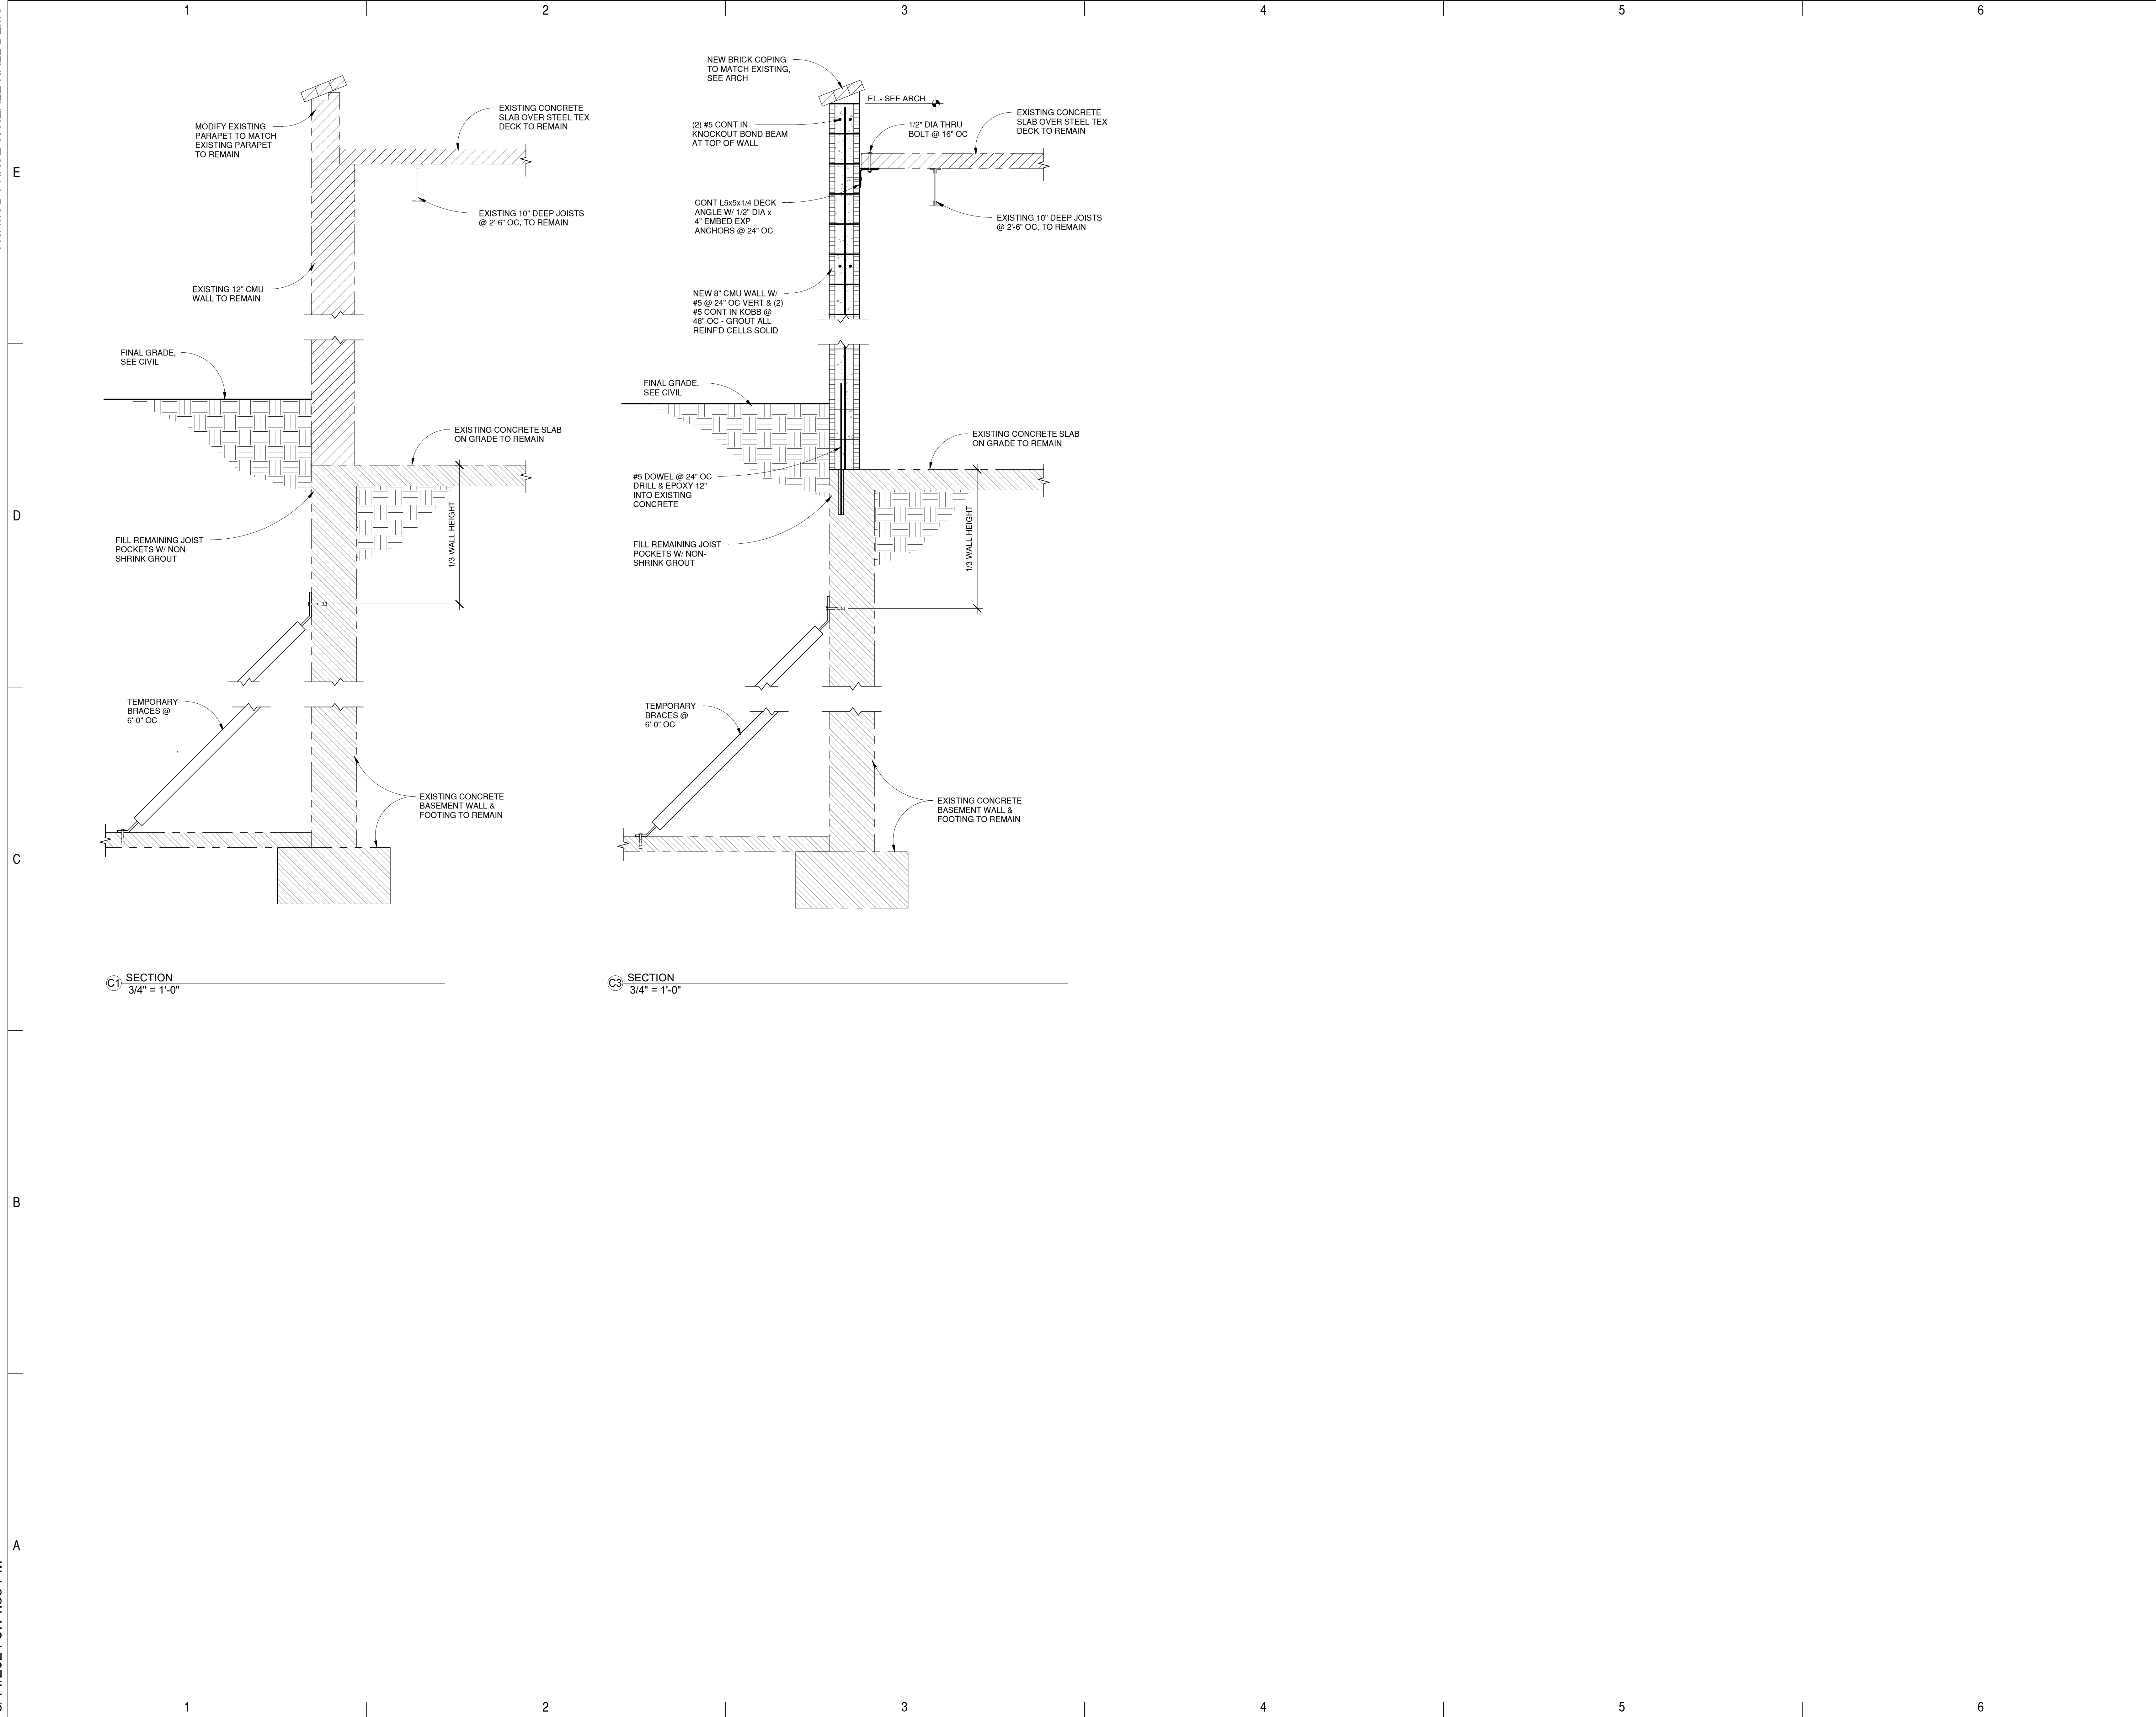
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**NM STATE**

**AG MOD PHASE 3: NEALE HALL DEMO**  
**Progress Set**

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 DATE: \_\_\_\_\_  
 PROJECT NO: \_\_\_\_\_  
 DRAWN BY: KV  
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SHEET TITLE  
 SECTIONS

**S-201**

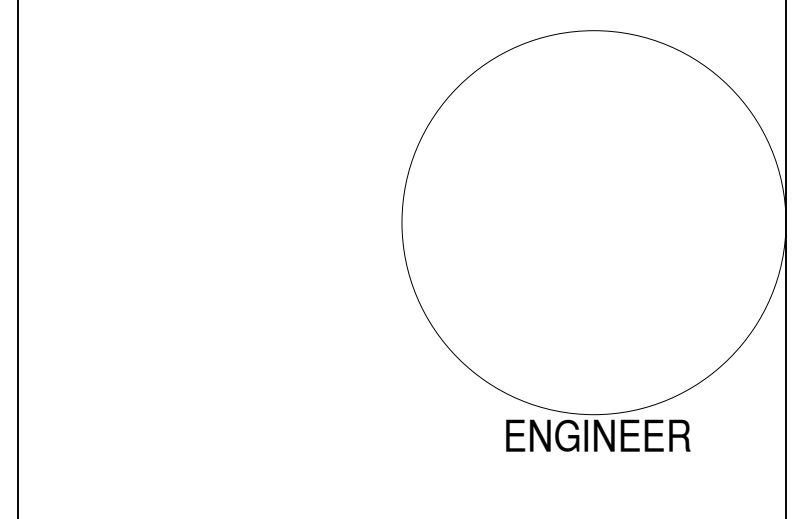School Information

AG MOD PHASE 3: NEALE HALL DEMO

3/14/2024 5:00:08 PM




A1 OVERALL SITE PLAN  
1" = 20'-0"

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**NM STATE**

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ISSUE:  
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 PROJECT NO: 773B  
 DRAWN BY: Author  
 CHECKED BY: Checker

SHEET TITLE  
 SITE PLAN


**AS-101**

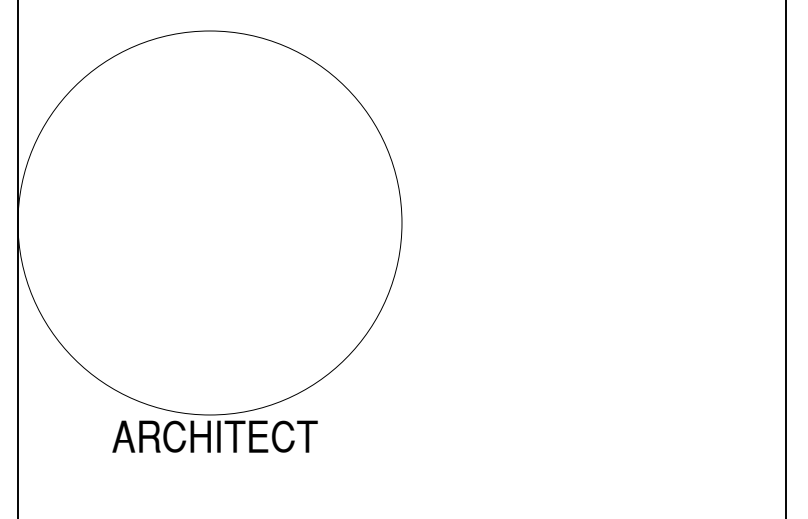School Information



AG MOD PHASE 3: NEALE HALL DEMO

3/14/2024 5:00:08 PM

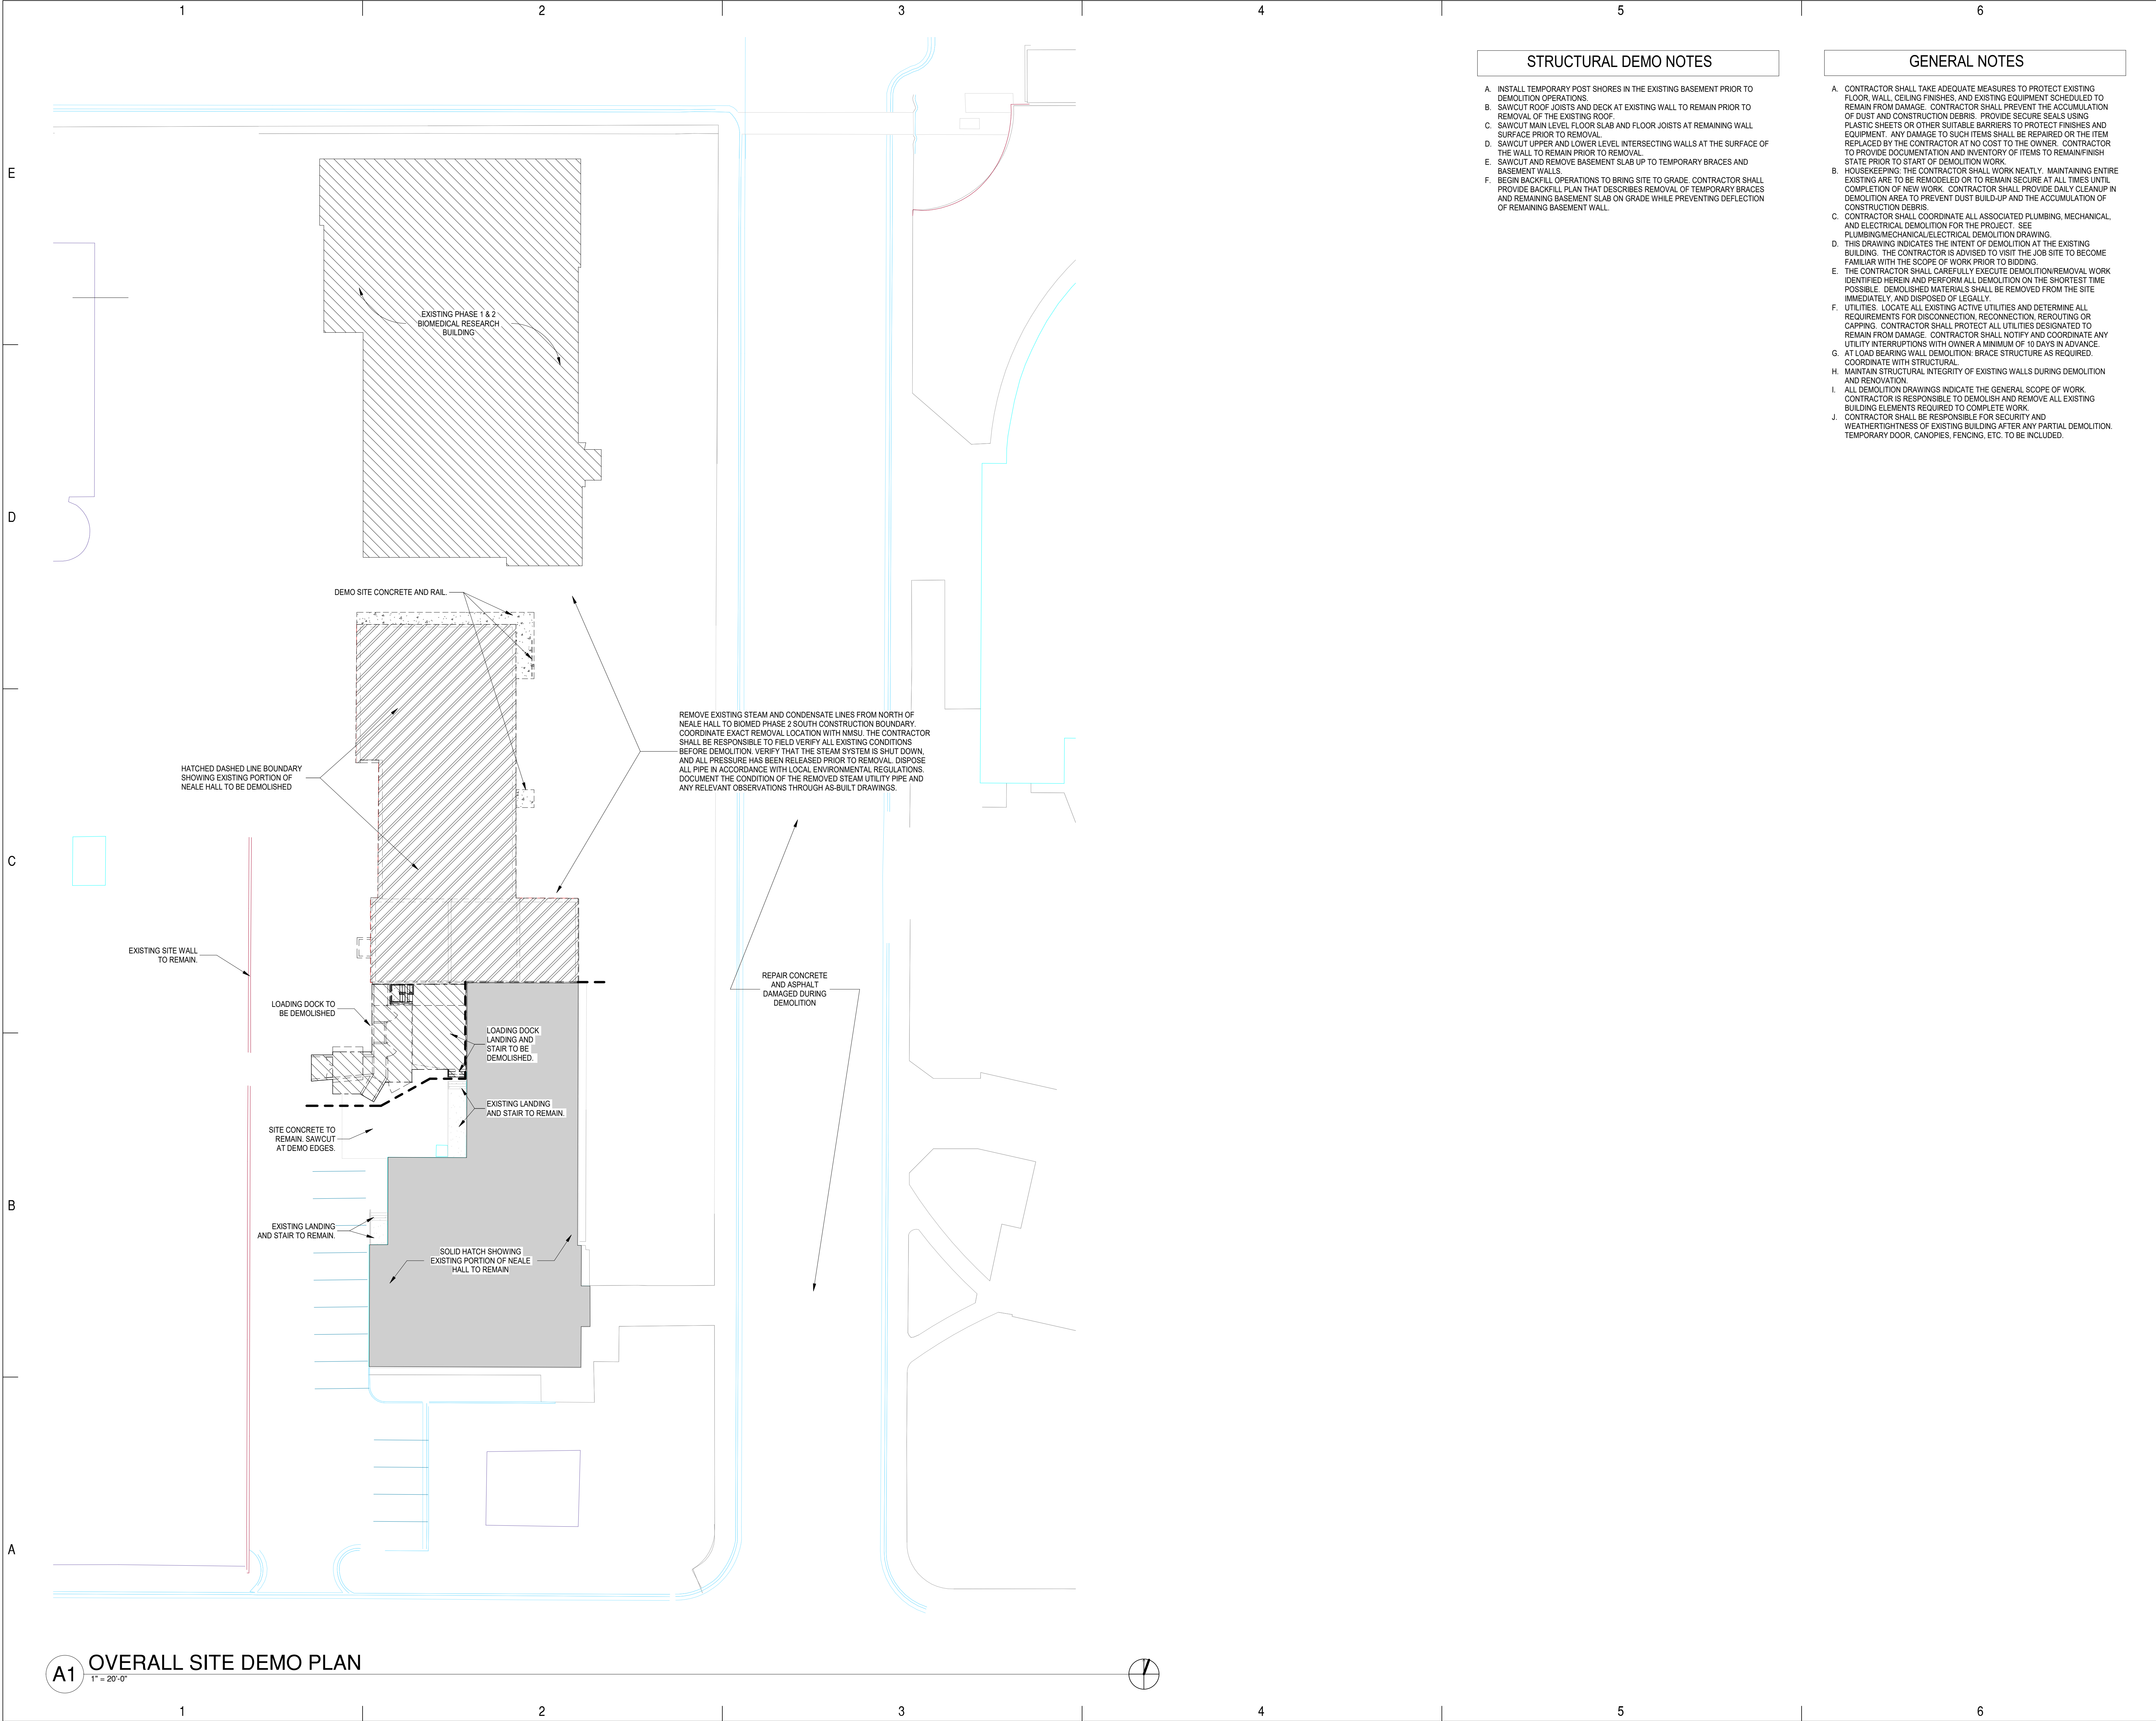

**STRUCTURAL DEMO NOTES**

- A. INSTALL TEMPORARY POST SHORES IN THE EXISTING BASEMENT PRIOR TO DEMOLITION OPERATIONS.
- B. SAWCUT ROOF JOISTS AND DECK AT EXISTING WALL TO REMAIN PRIOR TO REMOVAL OF THE EXISTING ROOF.
- C. SAWCUT MAIN LEVEL FLOOR SLAB AND FLOOR JOISTS AT REMAINING WALL SURFACE PRIOR TO REMOVAL.
- D. SAWCUT UPPER AND LOWER LEVEL INTERSECTING WALLS AT THE SURFACE OF THE WALL TO REMAIN PRIOR TO REMOVAL.
- E. SAWCUT AND REMOVE BASEMENT SLAB UP TO TEMPORARY BRACES AND BASEMENT WALLS.
- F. BEGIN BACKFILL OPERATIONS TO BRING SITE TO GRADE. CONTRACTOR SHALL PROVIDE BACKFILL PLAN THAT DESCRIBES REMOVAL OF TEMPORARY BRACES AND REMAINING BASEMENT SLAB ON GRADE WHILE PREVENTING DEFLECTION OF REMAINING BASEMENT WALL.

**GENERAL NOTES**

- A. CONTRACTOR SHALL TAKE ADEQUATE MEASURES TO PROTECT EXISTING FLOOR, WALL, CEILING FINISHES, AND EXISTING EQUIPMENT SCHEDULED TO REMAIN FROM DAMAGE. CONTRACTOR SHALL PREVENT THE ACCUMULATION OF DUST AND CONSTRUCTION DEBRIS. PROVIDE SECURE SEALS USING PLASTIC SHEETS OR OTHER SUITABLE BARRIERS TO PROTECT FINISHES AND EQUIPMENT. ANY DAMAGE TO SUCH ITEMS SHALL BE REPAIRED OR THE ITEM REPLACED BY THE CONTRACTOR AT NO COST TO THE OWNER. CONTRACTOR TO PROVIDE DOCUMENTATION AND INVENTORY OF ITEMS TO REMAIN/FINISH STATE PRIOR TO START OF DEMOLITION WORK.
- B. HOUSEKEEPING: THE CONTRACTOR SHALL WORK NEATLY. MAINTAINING ENTIRE EXISTING ARE TO BE REMODELED OR TO REMAIN SECURE AT ALL TIMES UNTIL COMPLETION OF NEW WORK. CONTRACTOR SHALL PROVIDE DAILY CLEANUP IN DEMOLITION AREA TO PREVENT DUST BUILD-UP AND THE ACCUMULATION OF CONSTRUCTION DEBRIS.
- C. CONTRACTOR SHALL COORDINATE ALL ASSOCIATED PLUMBING, MECHANICAL, AND ELECTRICAL DEMOLITION FOR THE PROJECT. SEE PLUMBING/MECHANICAL/ELECTRICAL DEMOLITION DRAWING.
- D. THIS DRAWING INDICATES THE INTENT OF DEMOLITION AT THE EXISTING BUILDING. THE CONTRACTOR IS ADVISED TO VISIT THE JOB SITE TO BECOME FAMILIAR WITH THE SCOPE OF WORK PRIOR TO BIDDING.
- E. THE CONTRACTOR SHALL CAREFULLY EXECUTE DEMOLITION/REMOVAL WORK IDENTIFIED HEREIN AND PERFORM ALL DEMOLITION ON THE SHORTEST TIME POSSIBLE. DEMOLISHED MATERIALS SHALL BE REMOVED FROM THE SITE IMMEDIATELY, AND DISPOSED OF LEGALLY.
- F. UTILITIES: LOCATE ALL EXISTING ACTIVE UTILITIES AND DETERMINE ALL REQUIREMENTS FOR DISCONNECTION, RECONNECTION, REROUTING OR CAPPING. CONTRACTOR SHALL PROTECT ALL UTILITIES DESIGNATED TO REMAIN FROM DAMAGE. CONTRACTOR SHALL NOTIFY AND COORDINATE ANY UTILITY INTERRUPTIONS WITH OWNER A MINIMUM OF 10 DAYS IN ADVANCE.
- G. AT LOAD BEARING WALL DEMOLITION: BRACE STRUCTURE AS REQUIRED. COORDINATE WITH STRUCTURAL.
- H. MAINTAIN STRUCTURAL INTEGRITY OF EXISTING WALLS DURING DEMOLITION AND RENOVATION.
- I. ALL DEMOLITION DRAWINGS INDICATE THE GENERAL SCOPE OF WORK. CONTRACTOR IS RESPONSIBLE TO DEMOLISH AND REMOVE ALL EXISTING BUILDING ELEMENTS REQUIRED TO COMPLETE WORK.
- J. CONTRACTOR SHALL BE RESPONSIBLE FOR SECURITY AND WEATHERIGHTNESS OF EXISTING BUILDING AFTER ANY PARTIAL DEMOLITION. TEMPORARY DOOR, CANOPIES, FENCING, ETC. TO BE INCLUDED.

**fbt** | architects

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Albuquerque, NM 87110


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**AG MOD PHASE 3: NEALE HALL DEMO**

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Las Cruces, NM 88001

MARCH 12, 2024

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ISSUE:  
DATE:  
PROJECT NO: 773B  
DRAWN BY: Author  
CHECKED BY: Checker

SHEET TITLE  
DEMO SITE PLAN

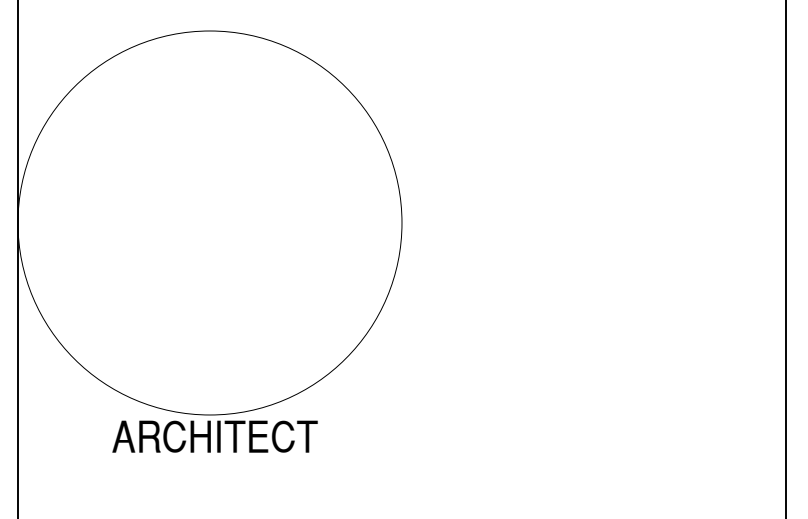**ASD-101**

**A1** OVERALL SITE DEMO PLAN  
1" = 20'-0"


School Information

CONSULTANTS





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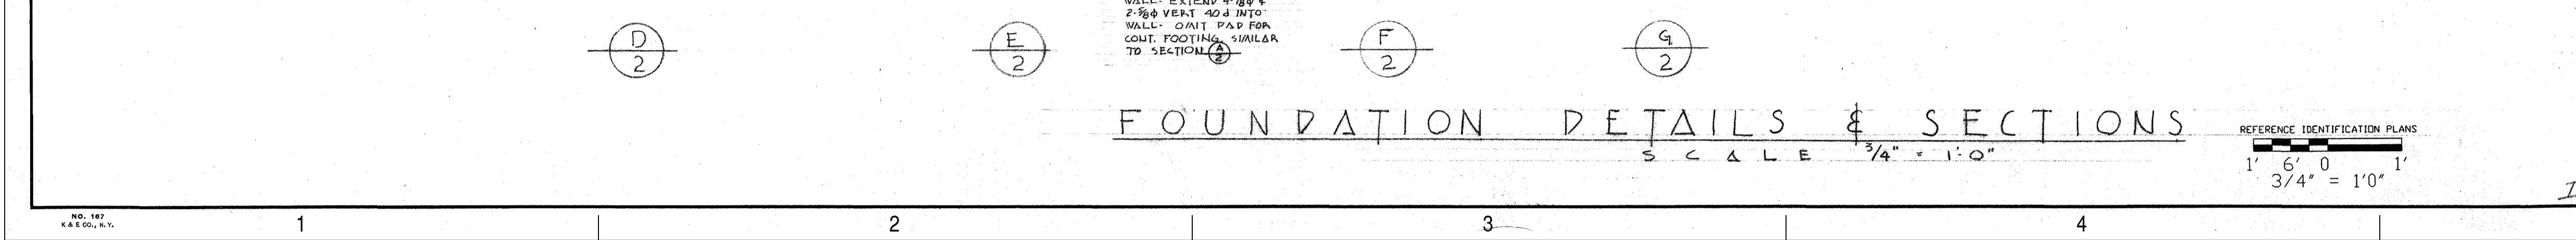
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FOUNDATION & BASEMENT PLAN



FOUNDATION DETAILS & SECTIONS

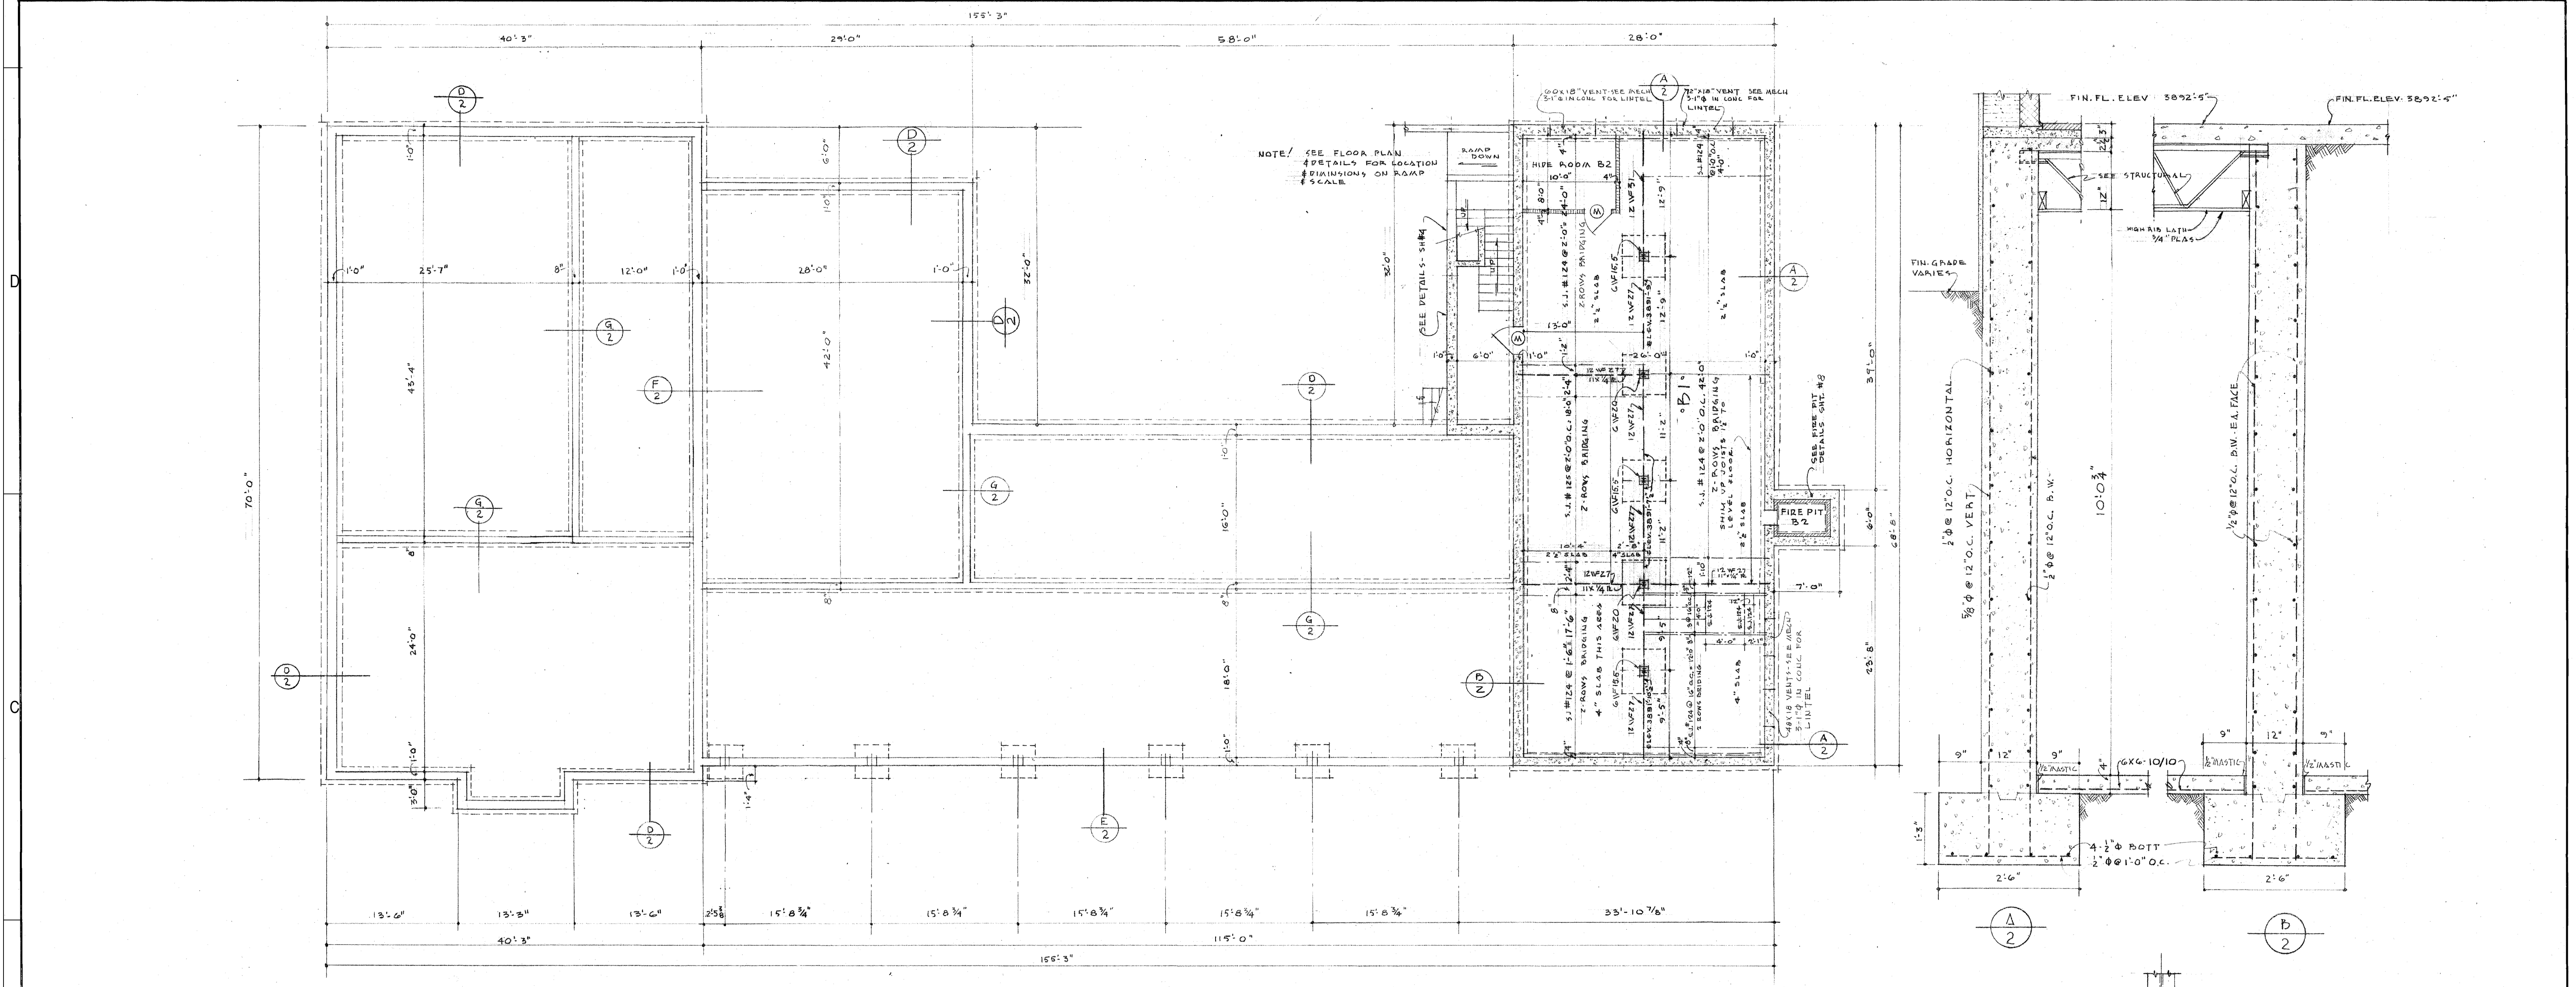

|   |                      |
|---|----------------------|
| AGRICULTURAL SCIENCE BUILDING FOR NEW MEXICO COLLEGE OF AGRICULTURE & MECHANIC ARTS STATE COLLEGE, NEW MEXICO | JOB NO. 277          |
| SCHAEFER & MERRELL ARCHITECTS CLOVIS NEW MEXICO   | DATE P.E.C. 12/19/99 |
|   | REVISIONS            |
|   | 2                    |
|   | 2                    |
|   | 2                    |
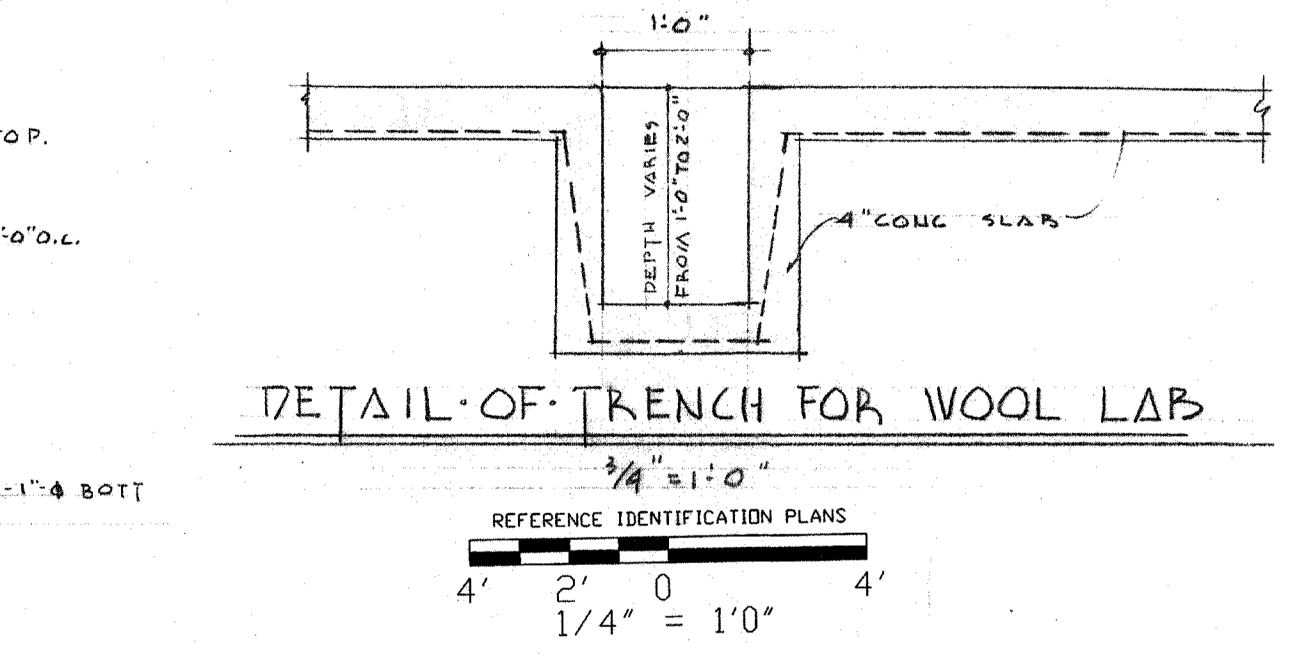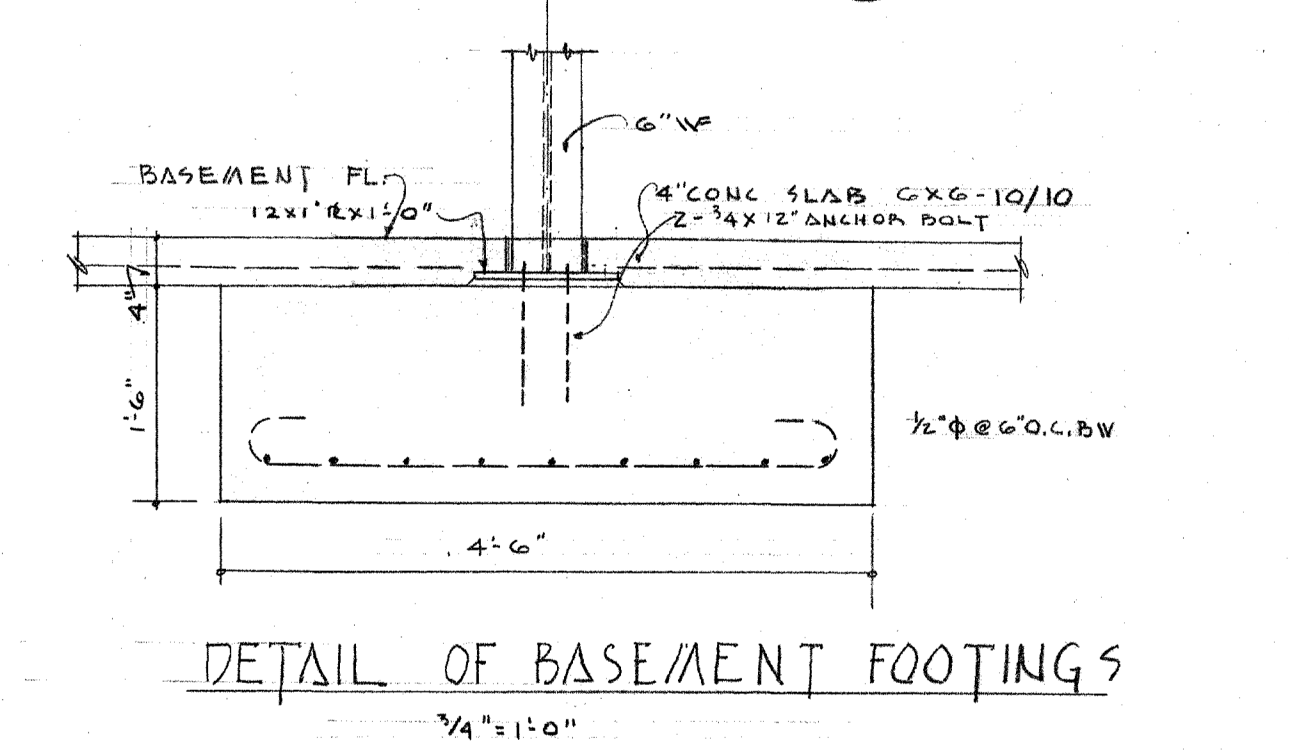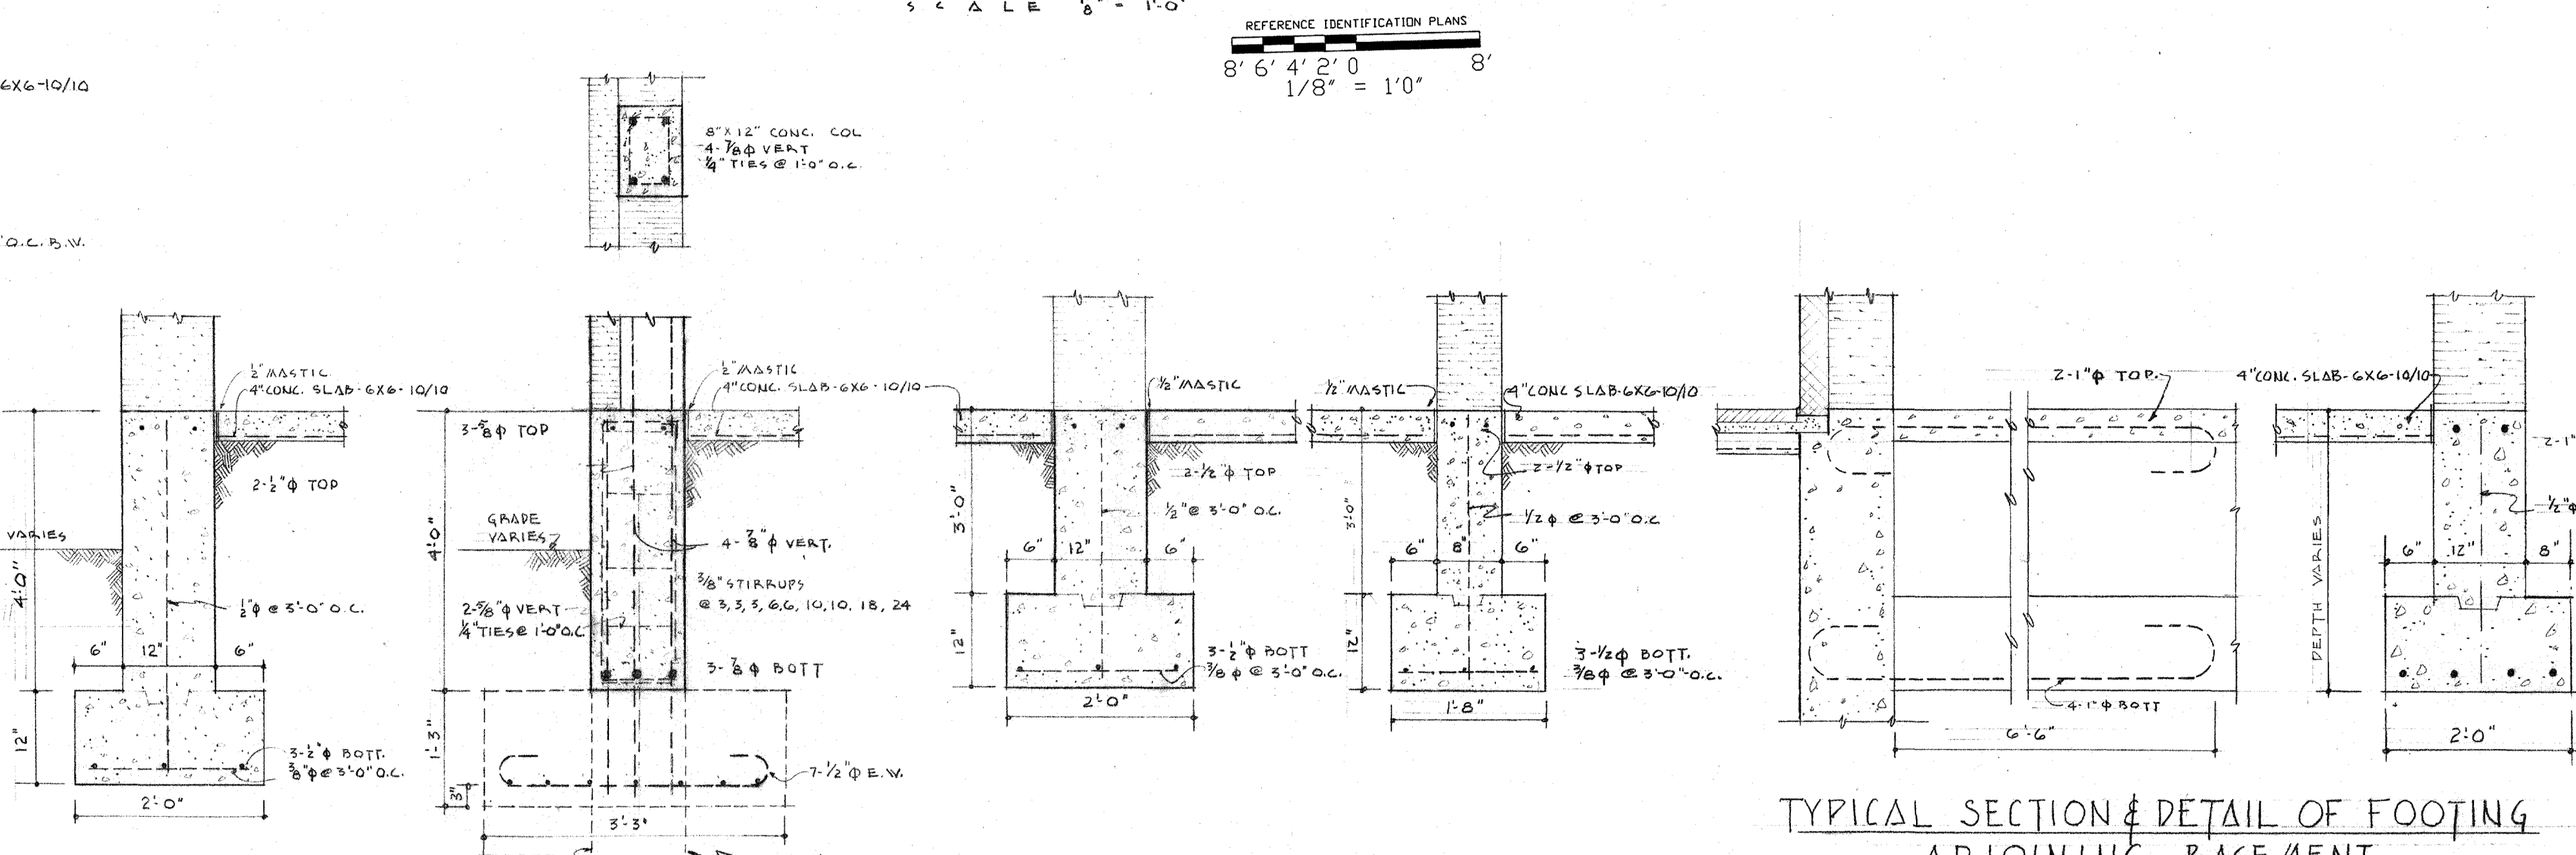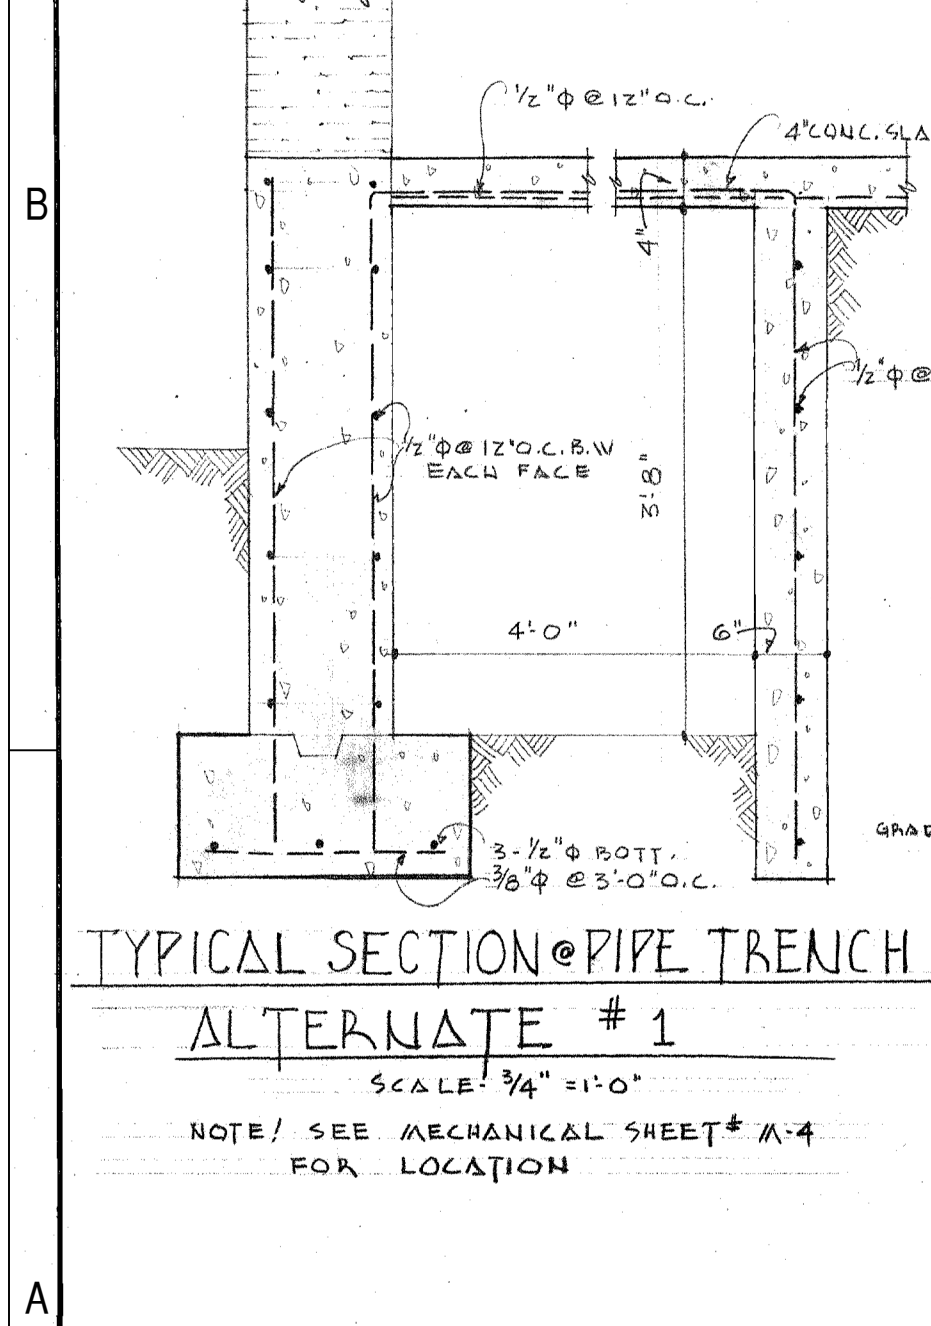
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SHEET TITLE  
 EXISTING PLANS



AE-100

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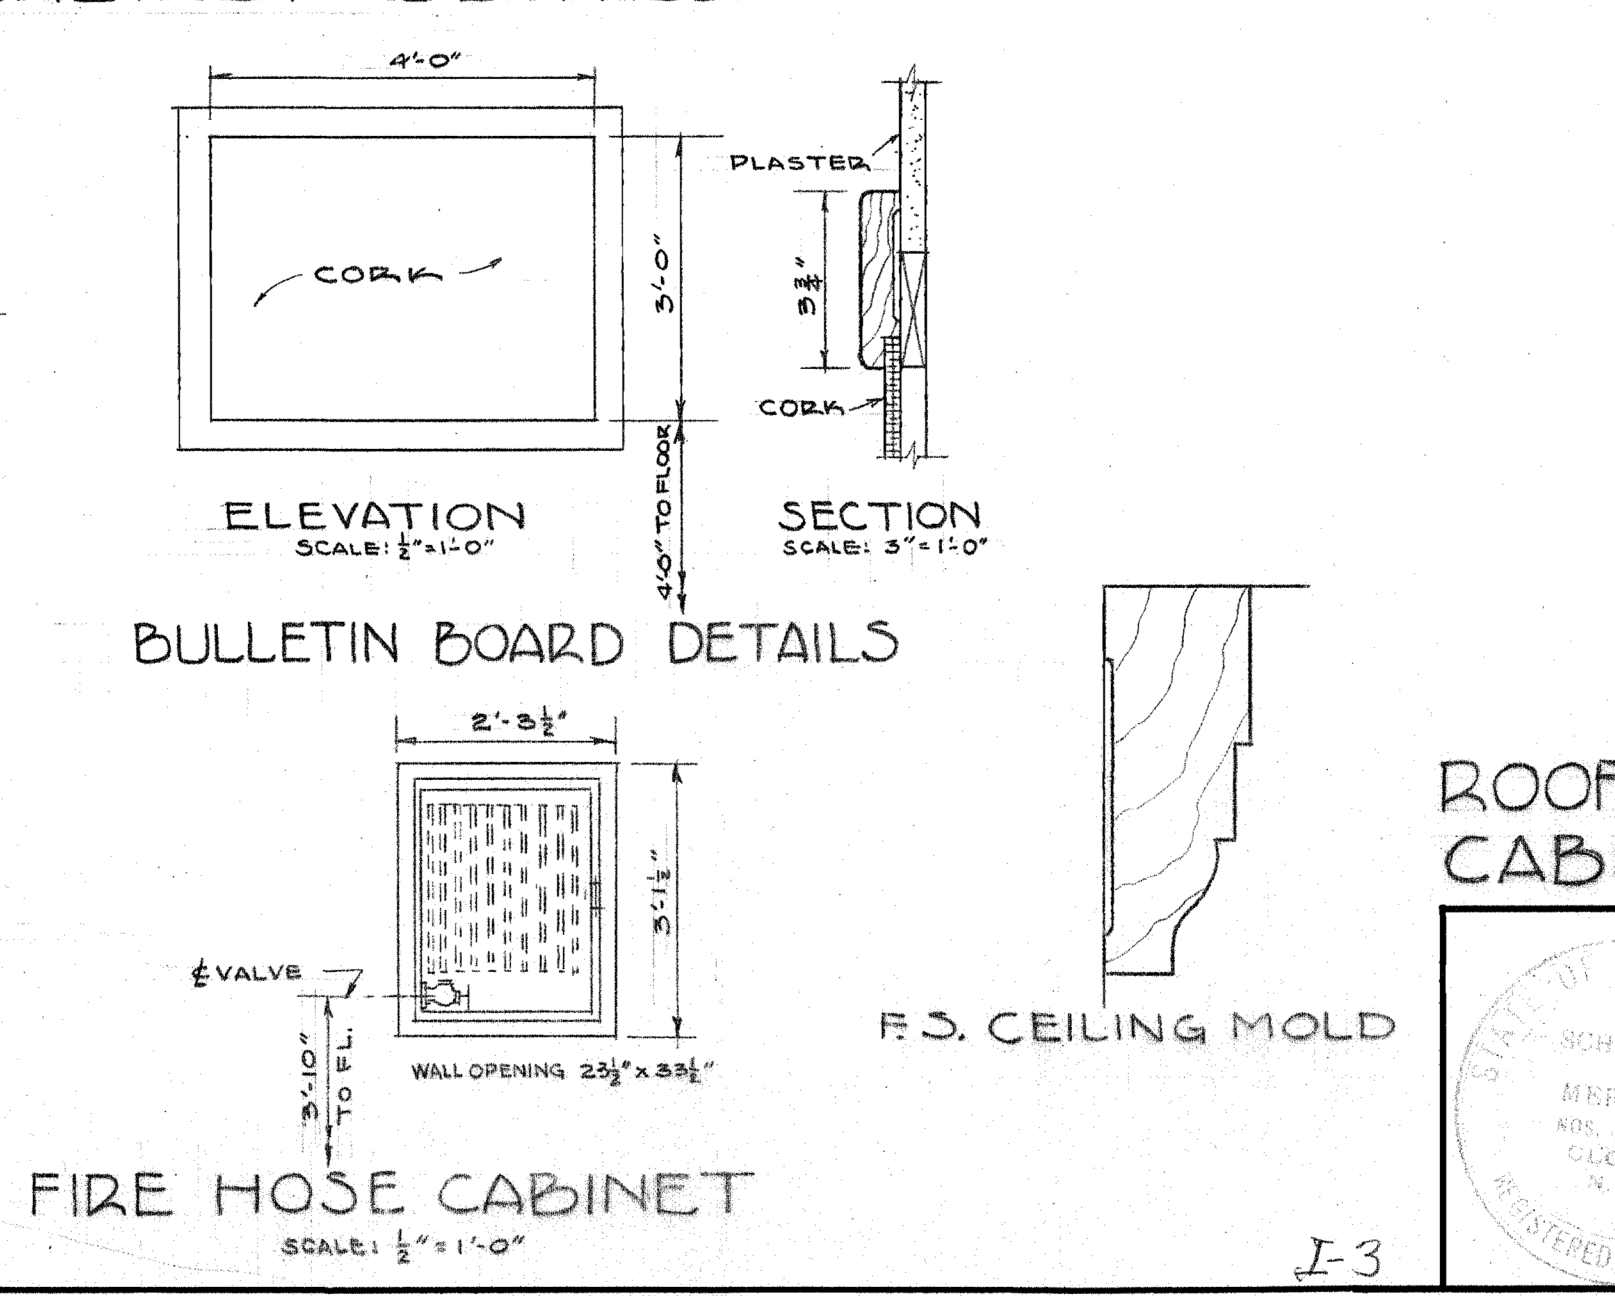
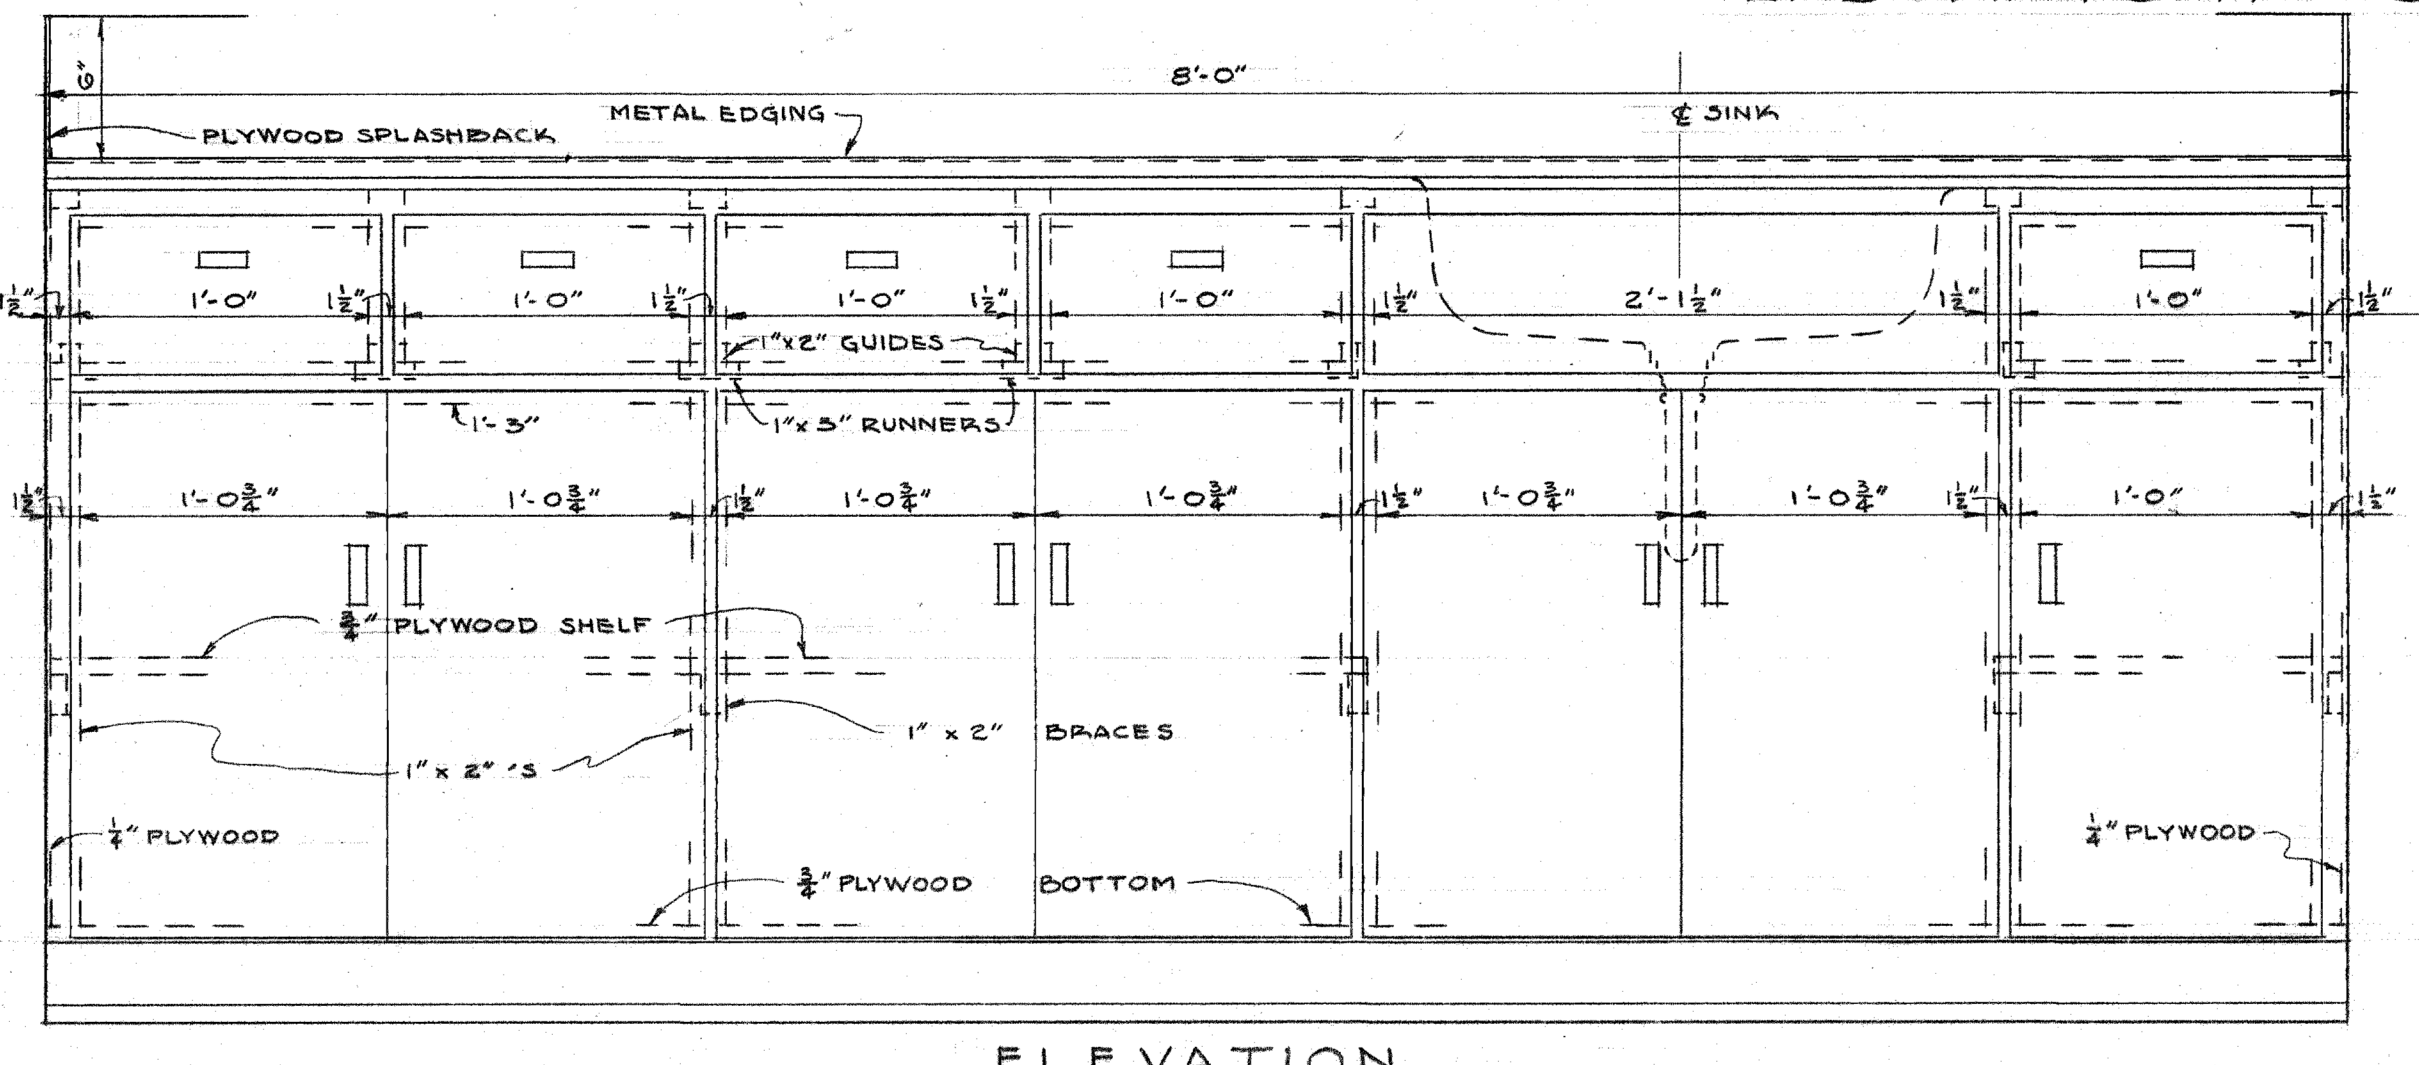
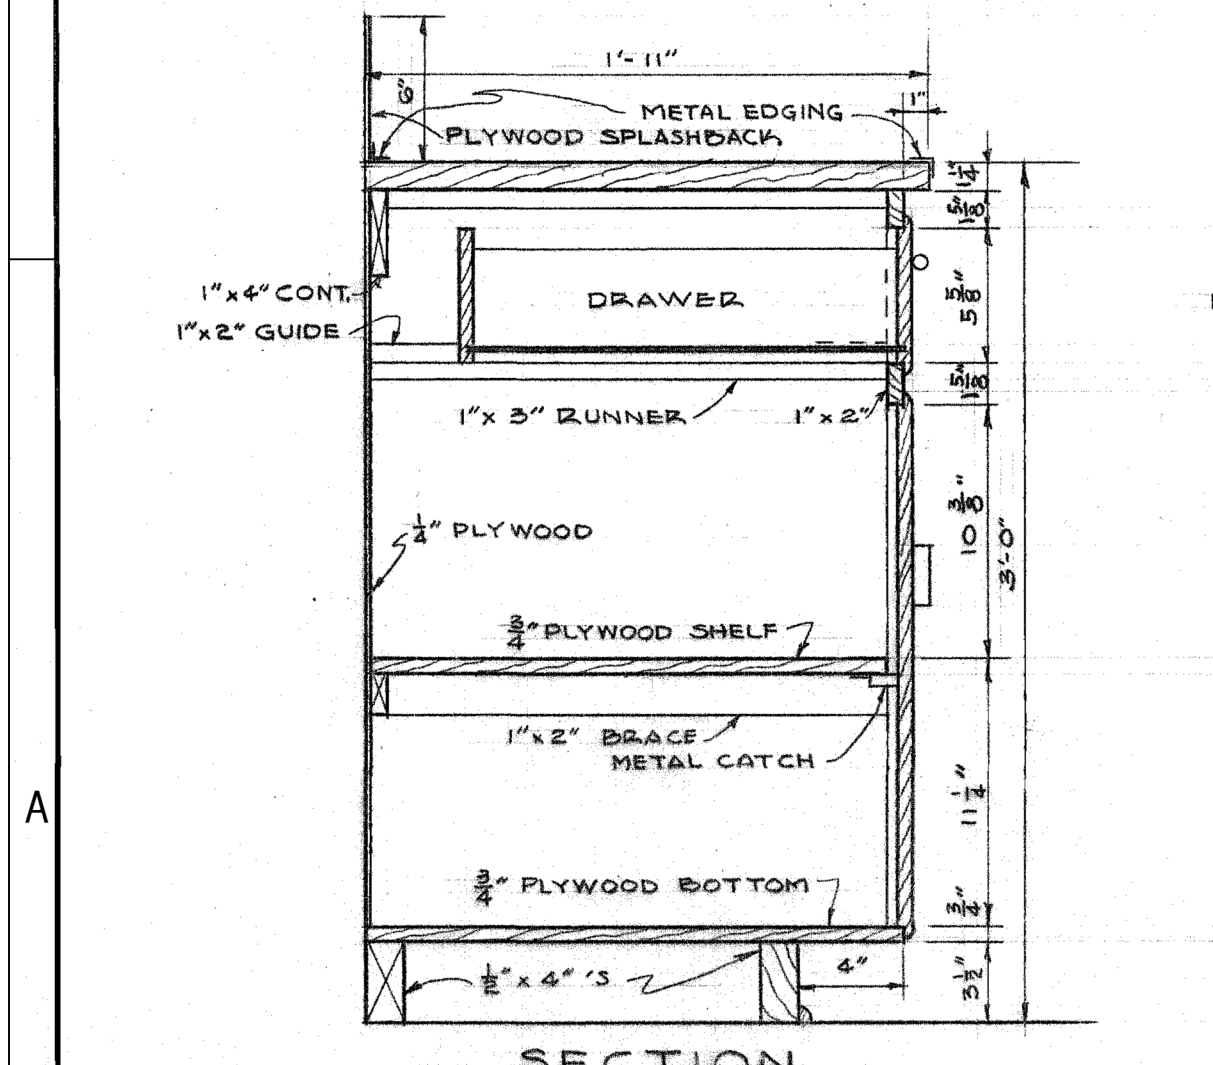
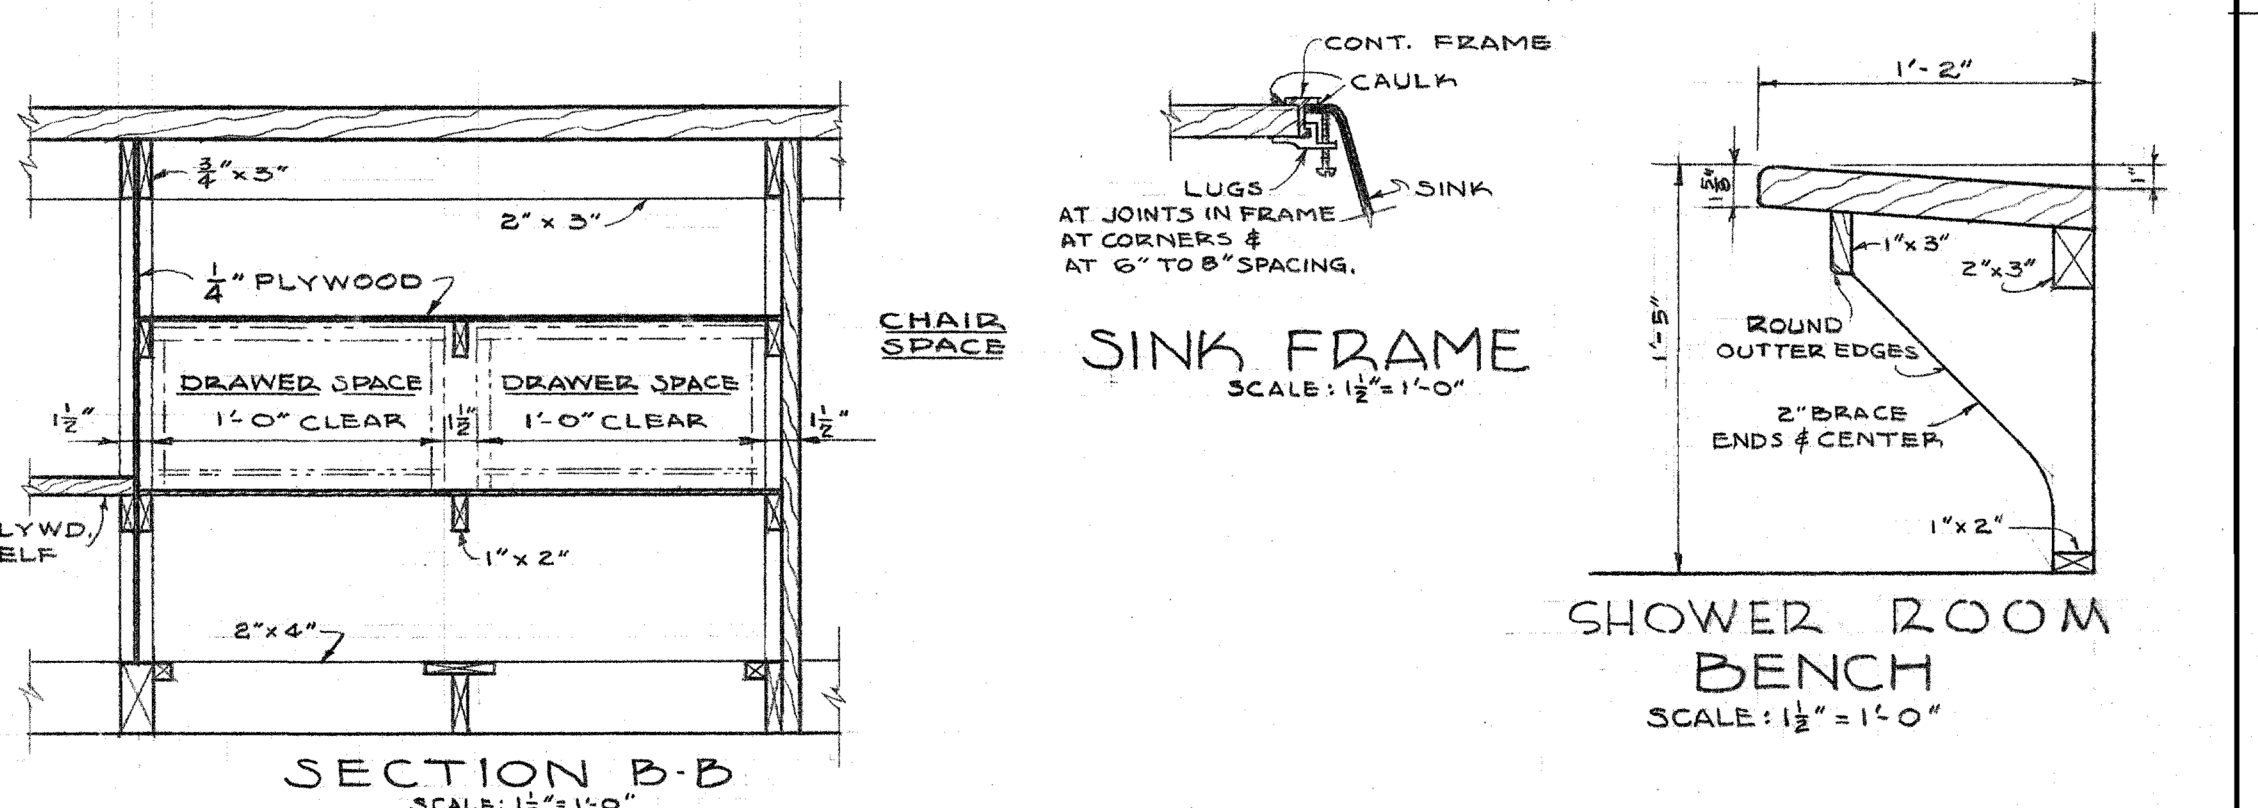
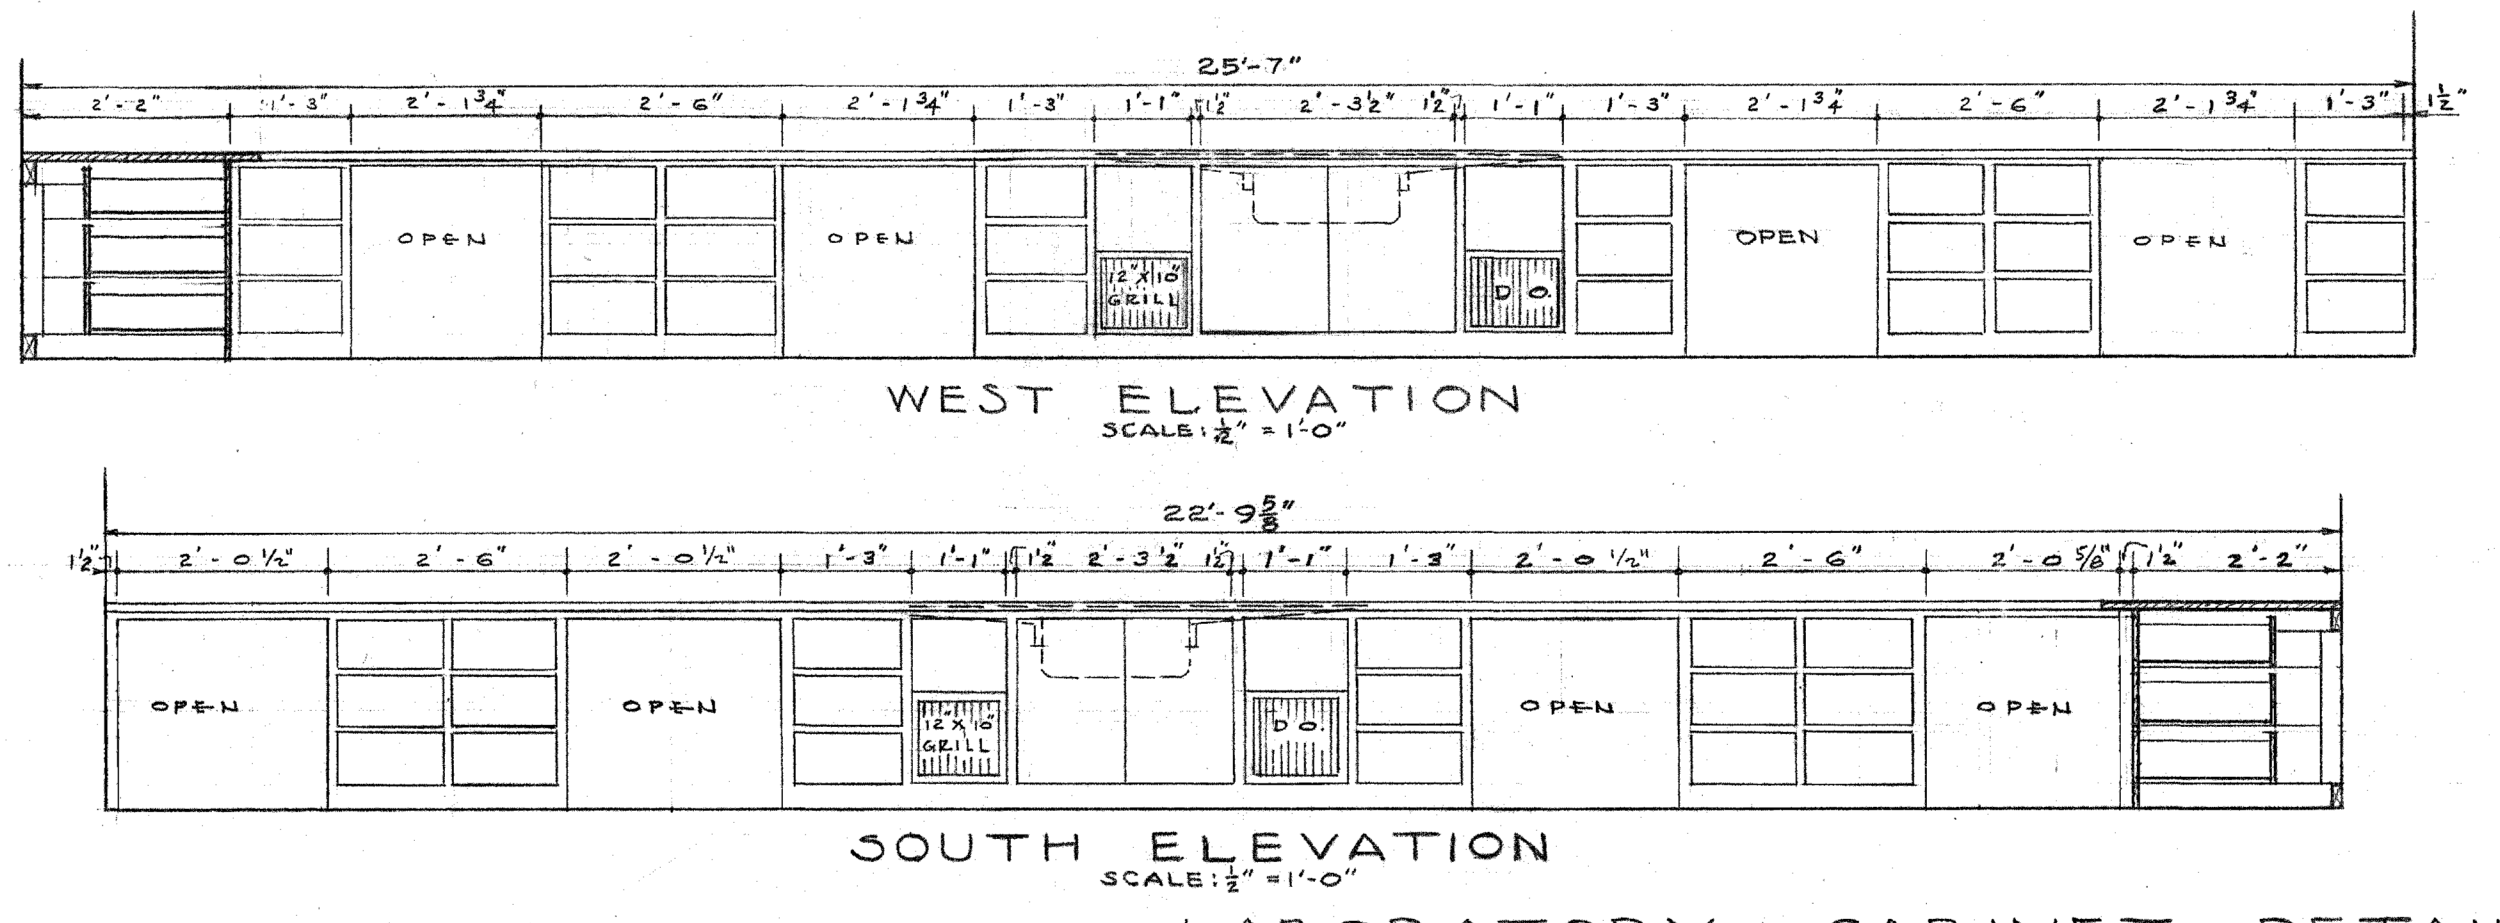
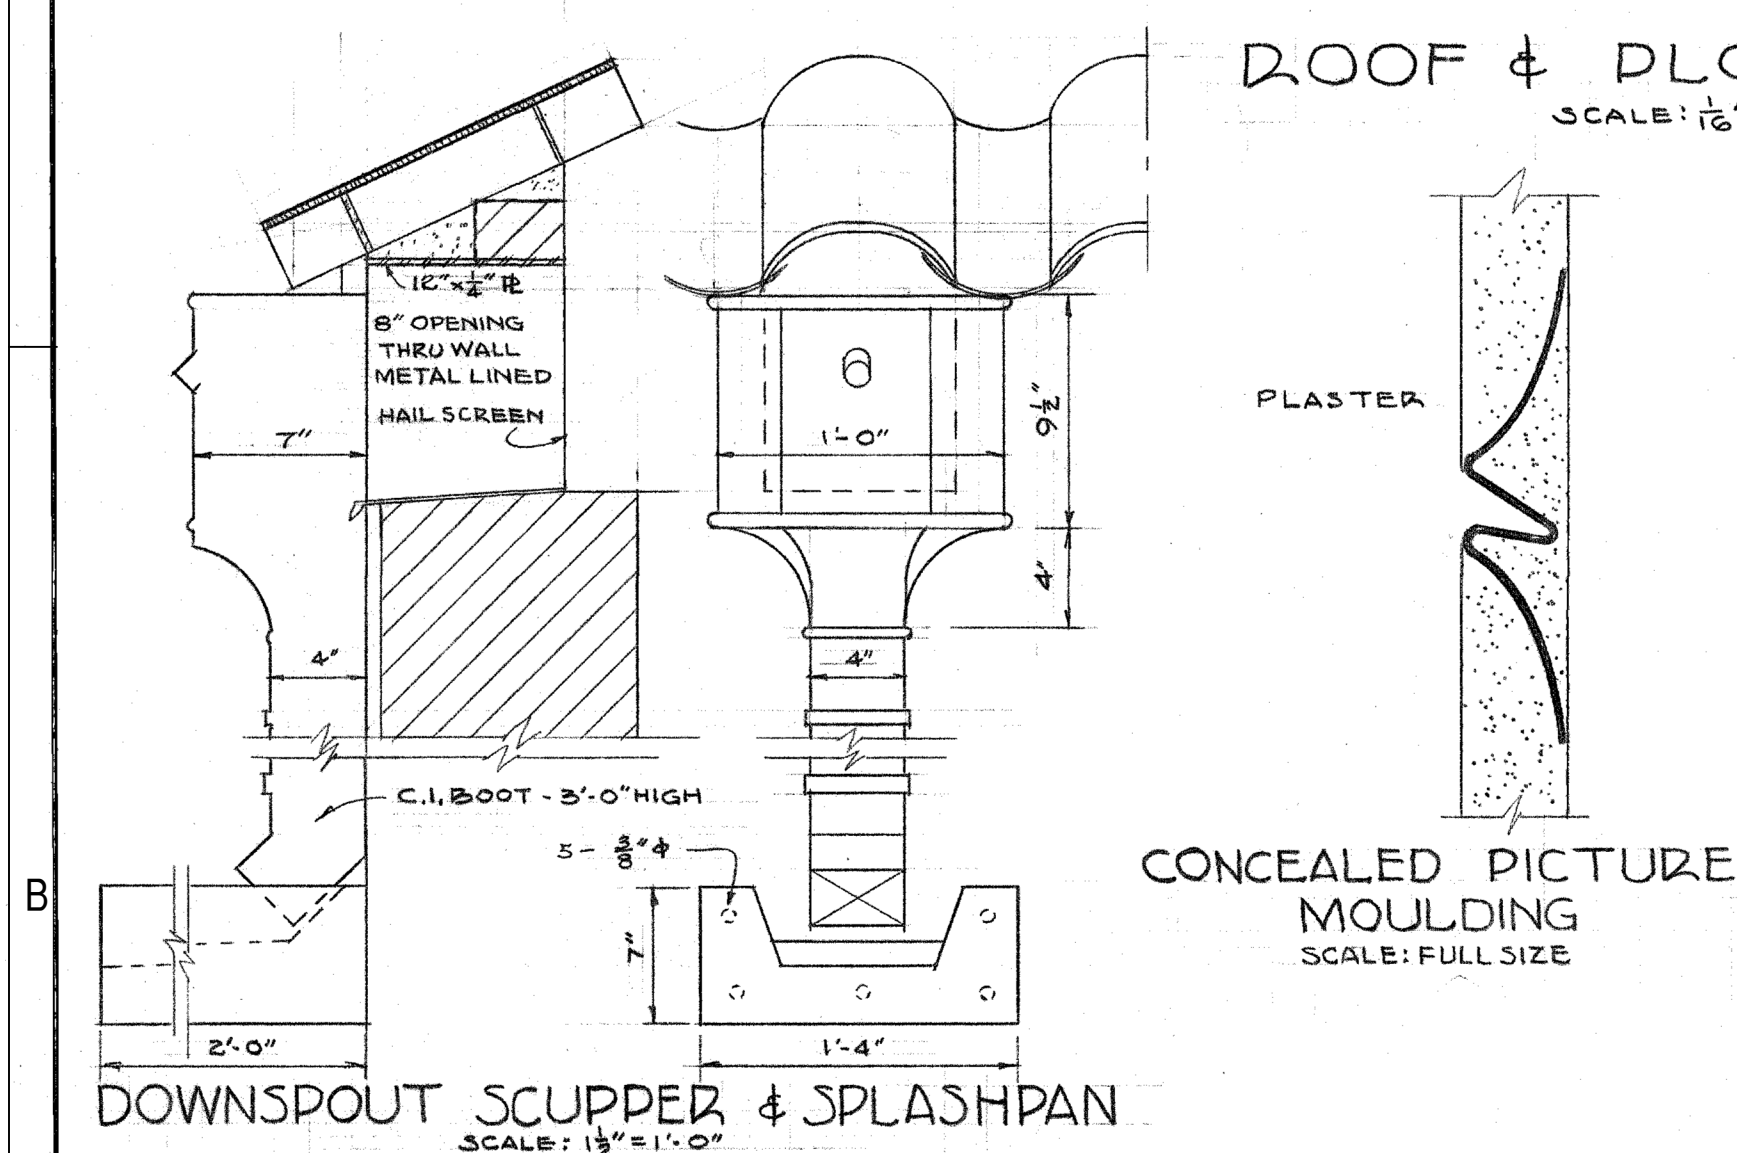
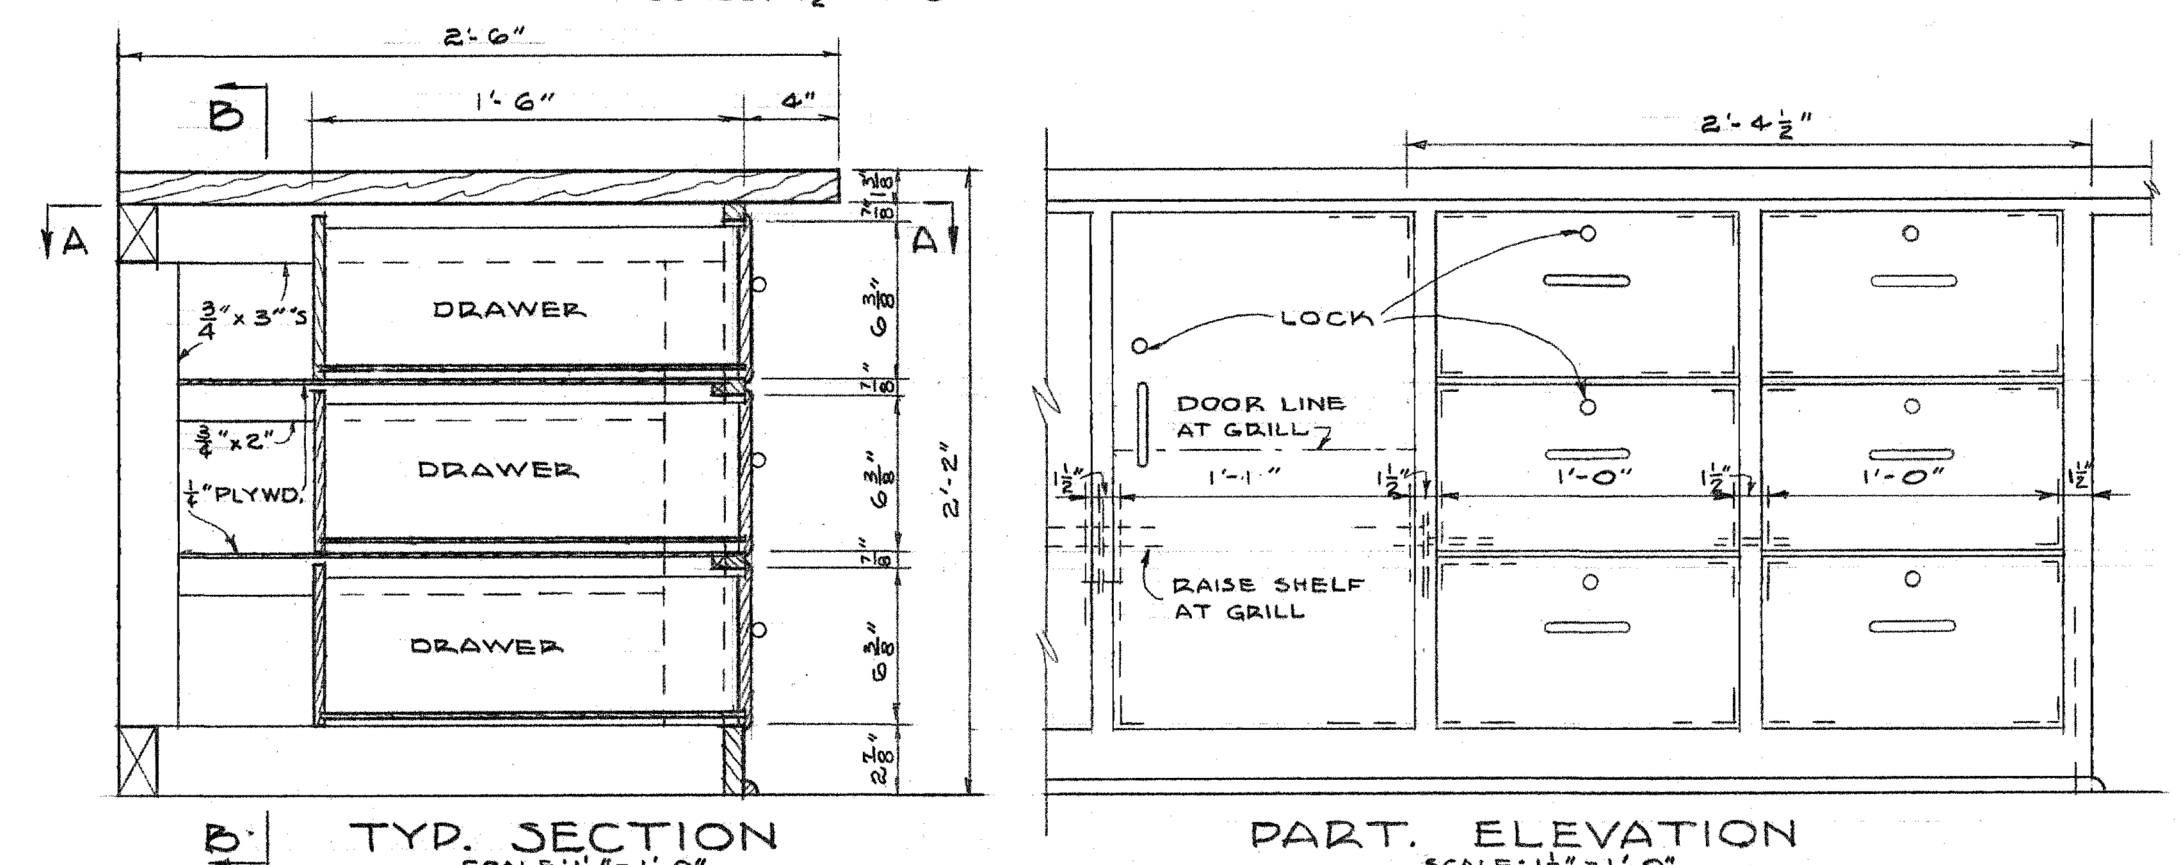
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 Albuquerque, NM 87110  
 Phone: 505.883.4111



- KEY TO MATERIALS**
- [Symbol] EARTH
  - [Symbol] CONCRETE
  - [Symbol] MASONRY BLOCK
  - [Symbol] STONE
  - [Symbol] BRICK
  - [Symbol] TILE
  - [Symbol] CORK
  - [Symbol] GYPSUM BLOCK
  - [Symbol] WOOD FINISH
  - [Symbol] WOOD ROUGH
  - [Symbol] WOOD BLOCK
  - [Symbol] MARBLE
  - [Symbol] BAT INSULATION
  - [Symbol] RIGID INSULATION
  - [Symbol] METAL
  - [Symbol] METAL
  - [Symbol] PLASTER
  - [Symbol] FIBRE BOARD

- ABBREVIATIONS**
- |  |                       |
|--|-----------------------|
| GI GALVANIZED IRON                               | COL CENTER LINE       |
| PLAS PLASTER                                     | CEM CEMENT            |
| CLG CEILING                                      | CONC CONCRETE         |
| P & H PLUMBING & HEATING                         | PL PLATE              |
| ASB CEM ASBESTOS CEMENT                          | NO. NUMBER            |
| B/U BUILT-UP TAR & GRAVEL ROOF                   | GR GRADE              |
| M T P METAL TOILET PARTITION                     | M O MASONRY OPENING   |
| M T METAL THRESHOLD                              | CO COURSE             |
| MAR T MARBLE THRESHOLD                           | F L FLOOR LINE        |
| SPEC SPECIFICATIONS                              | EL ELEVATION          |
| WP WATERPROOFING                                 | SECT SECTION          |
| WI WROUGHT IRON                                  | DET DETAIL            |
| CI CAST IRON                                     | FIN FINISH            |
| H M HOLLOW METAL                                 | WD WOOD               |
| SB SPLASHBLOCK                                   | CAP CAPACITY          |
| SS SERVICE SINK                                  | DN DOWN               |
| TEL TELEPHONE                                    | FD FLOOR DRAIN        |
| RAD RADIATOR                                     | DS DOWNSPOUT          |
| WC WATER CLOSET                                  | DB FIRE HOSE CABINET  |
| UR URINAL  | P B PHONE BOOTH       |
| LAV LAVATORY                                     | M C MEDICINE CABINET  |
| S R STUDENT ROOM                                 | ELEV ELEVATOR         |
| N I C NOT IN CONTRACT                            | D F DRINKING FOUNTAIN |
| BR BRICK   | PR PRESENT            |
| BLDG BUILDING                                    |                       |
| C G S FT CLEAR GLAZED STRUCTURAL FACING TILE     |                       |
| U G S FT UNGLAZED STRUCTURAL FACING TILE         |                       |
| S G S FT SALT GLAZED STRUCTURAL FACING TILE      |                       |
| CER G S FT CERAMIC GLAZED STRUCTURAL FACING TILE |                       |

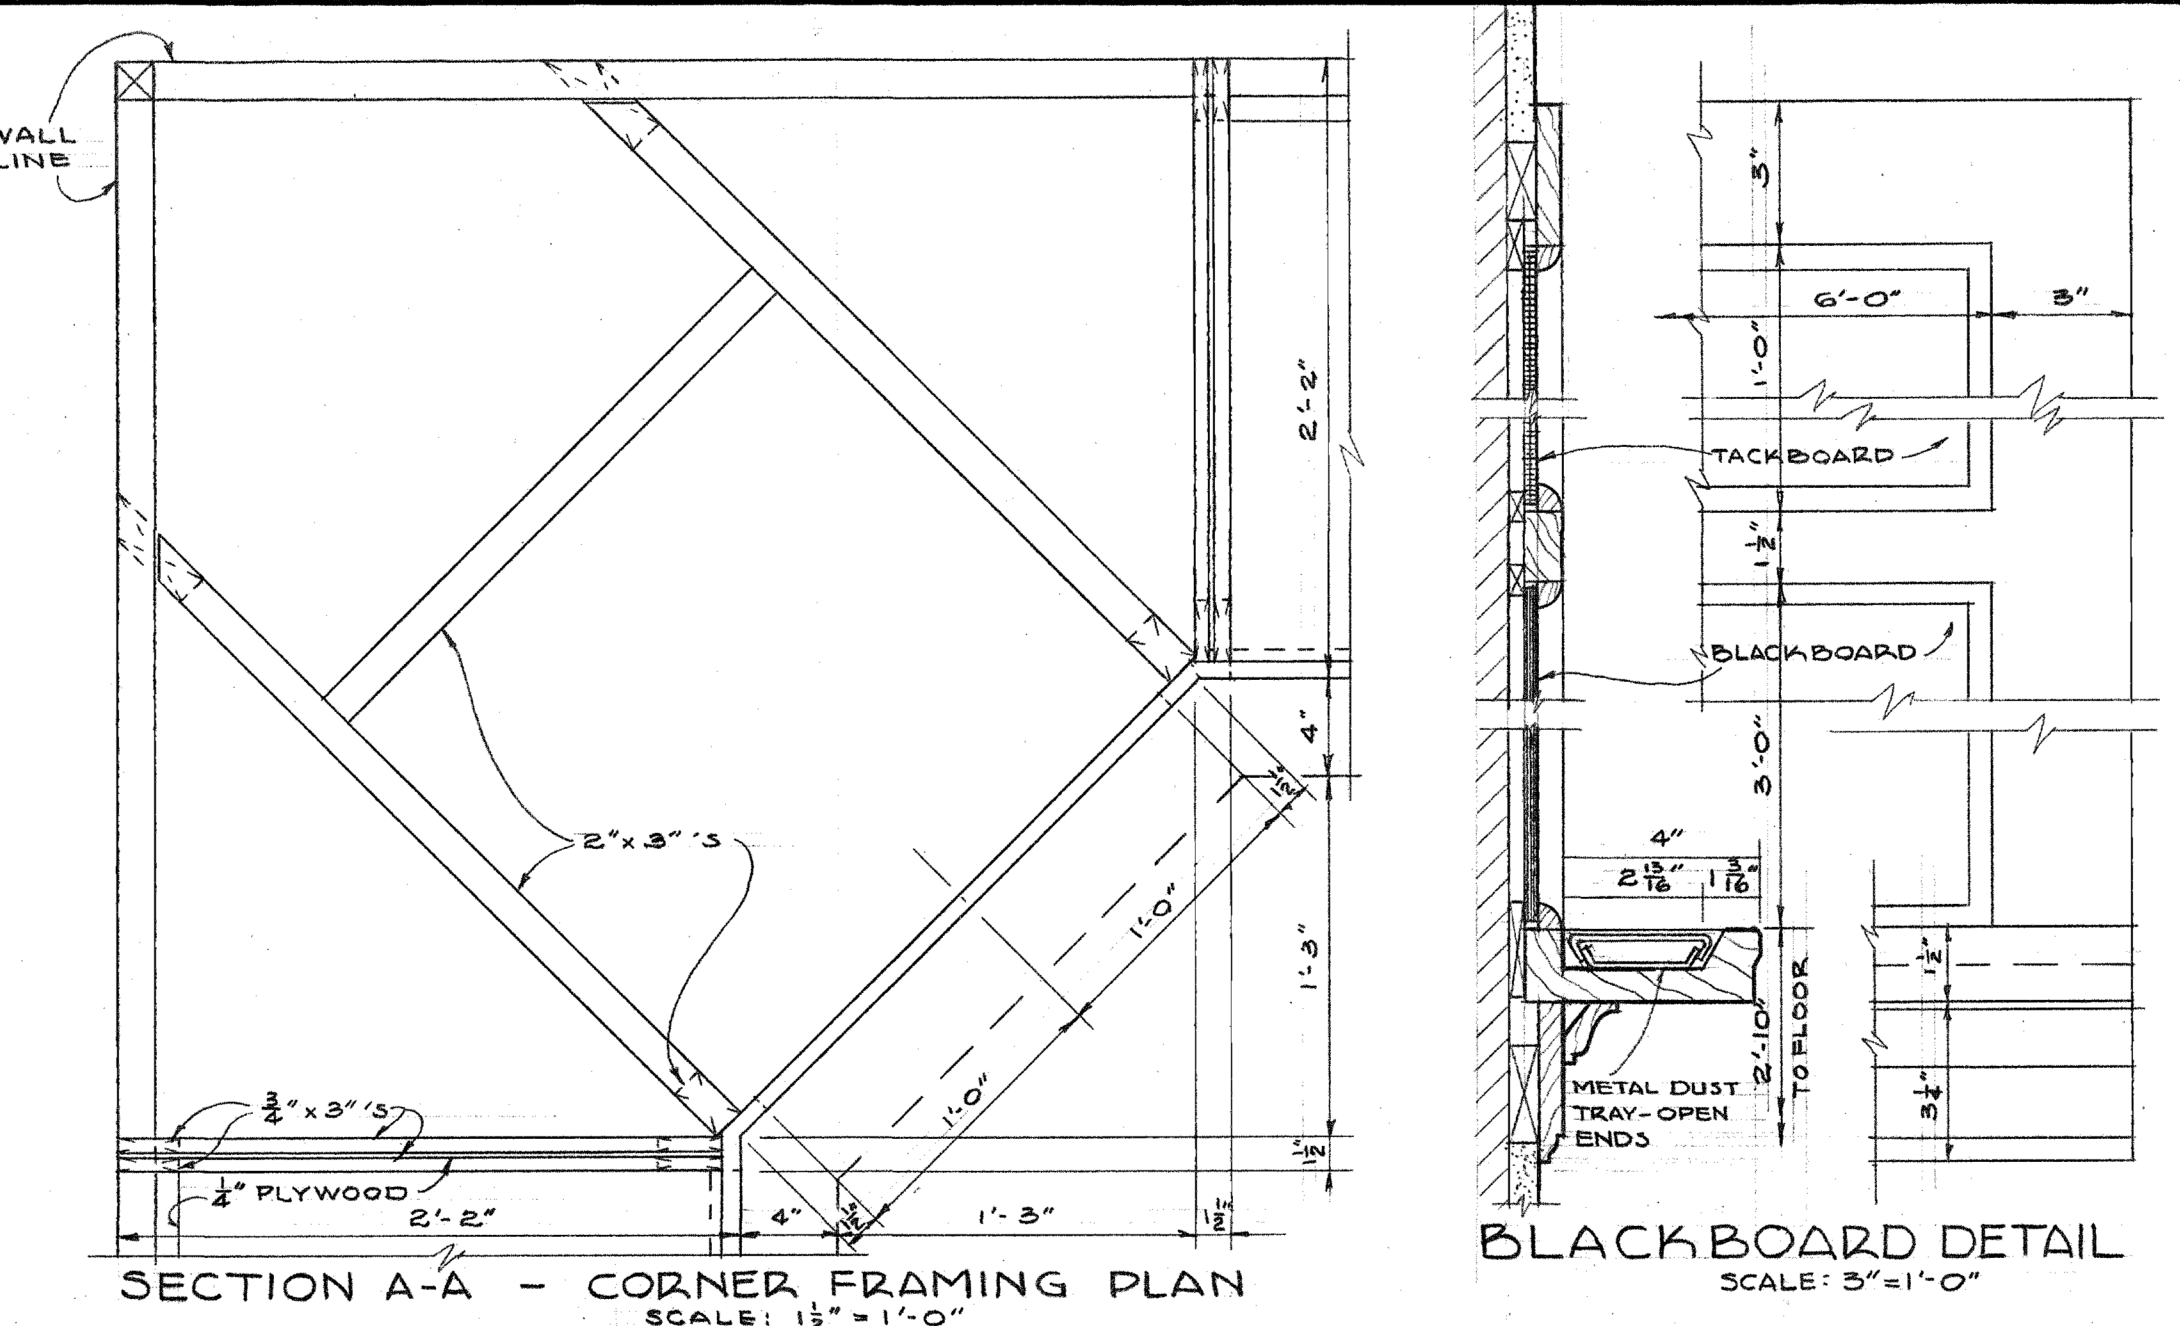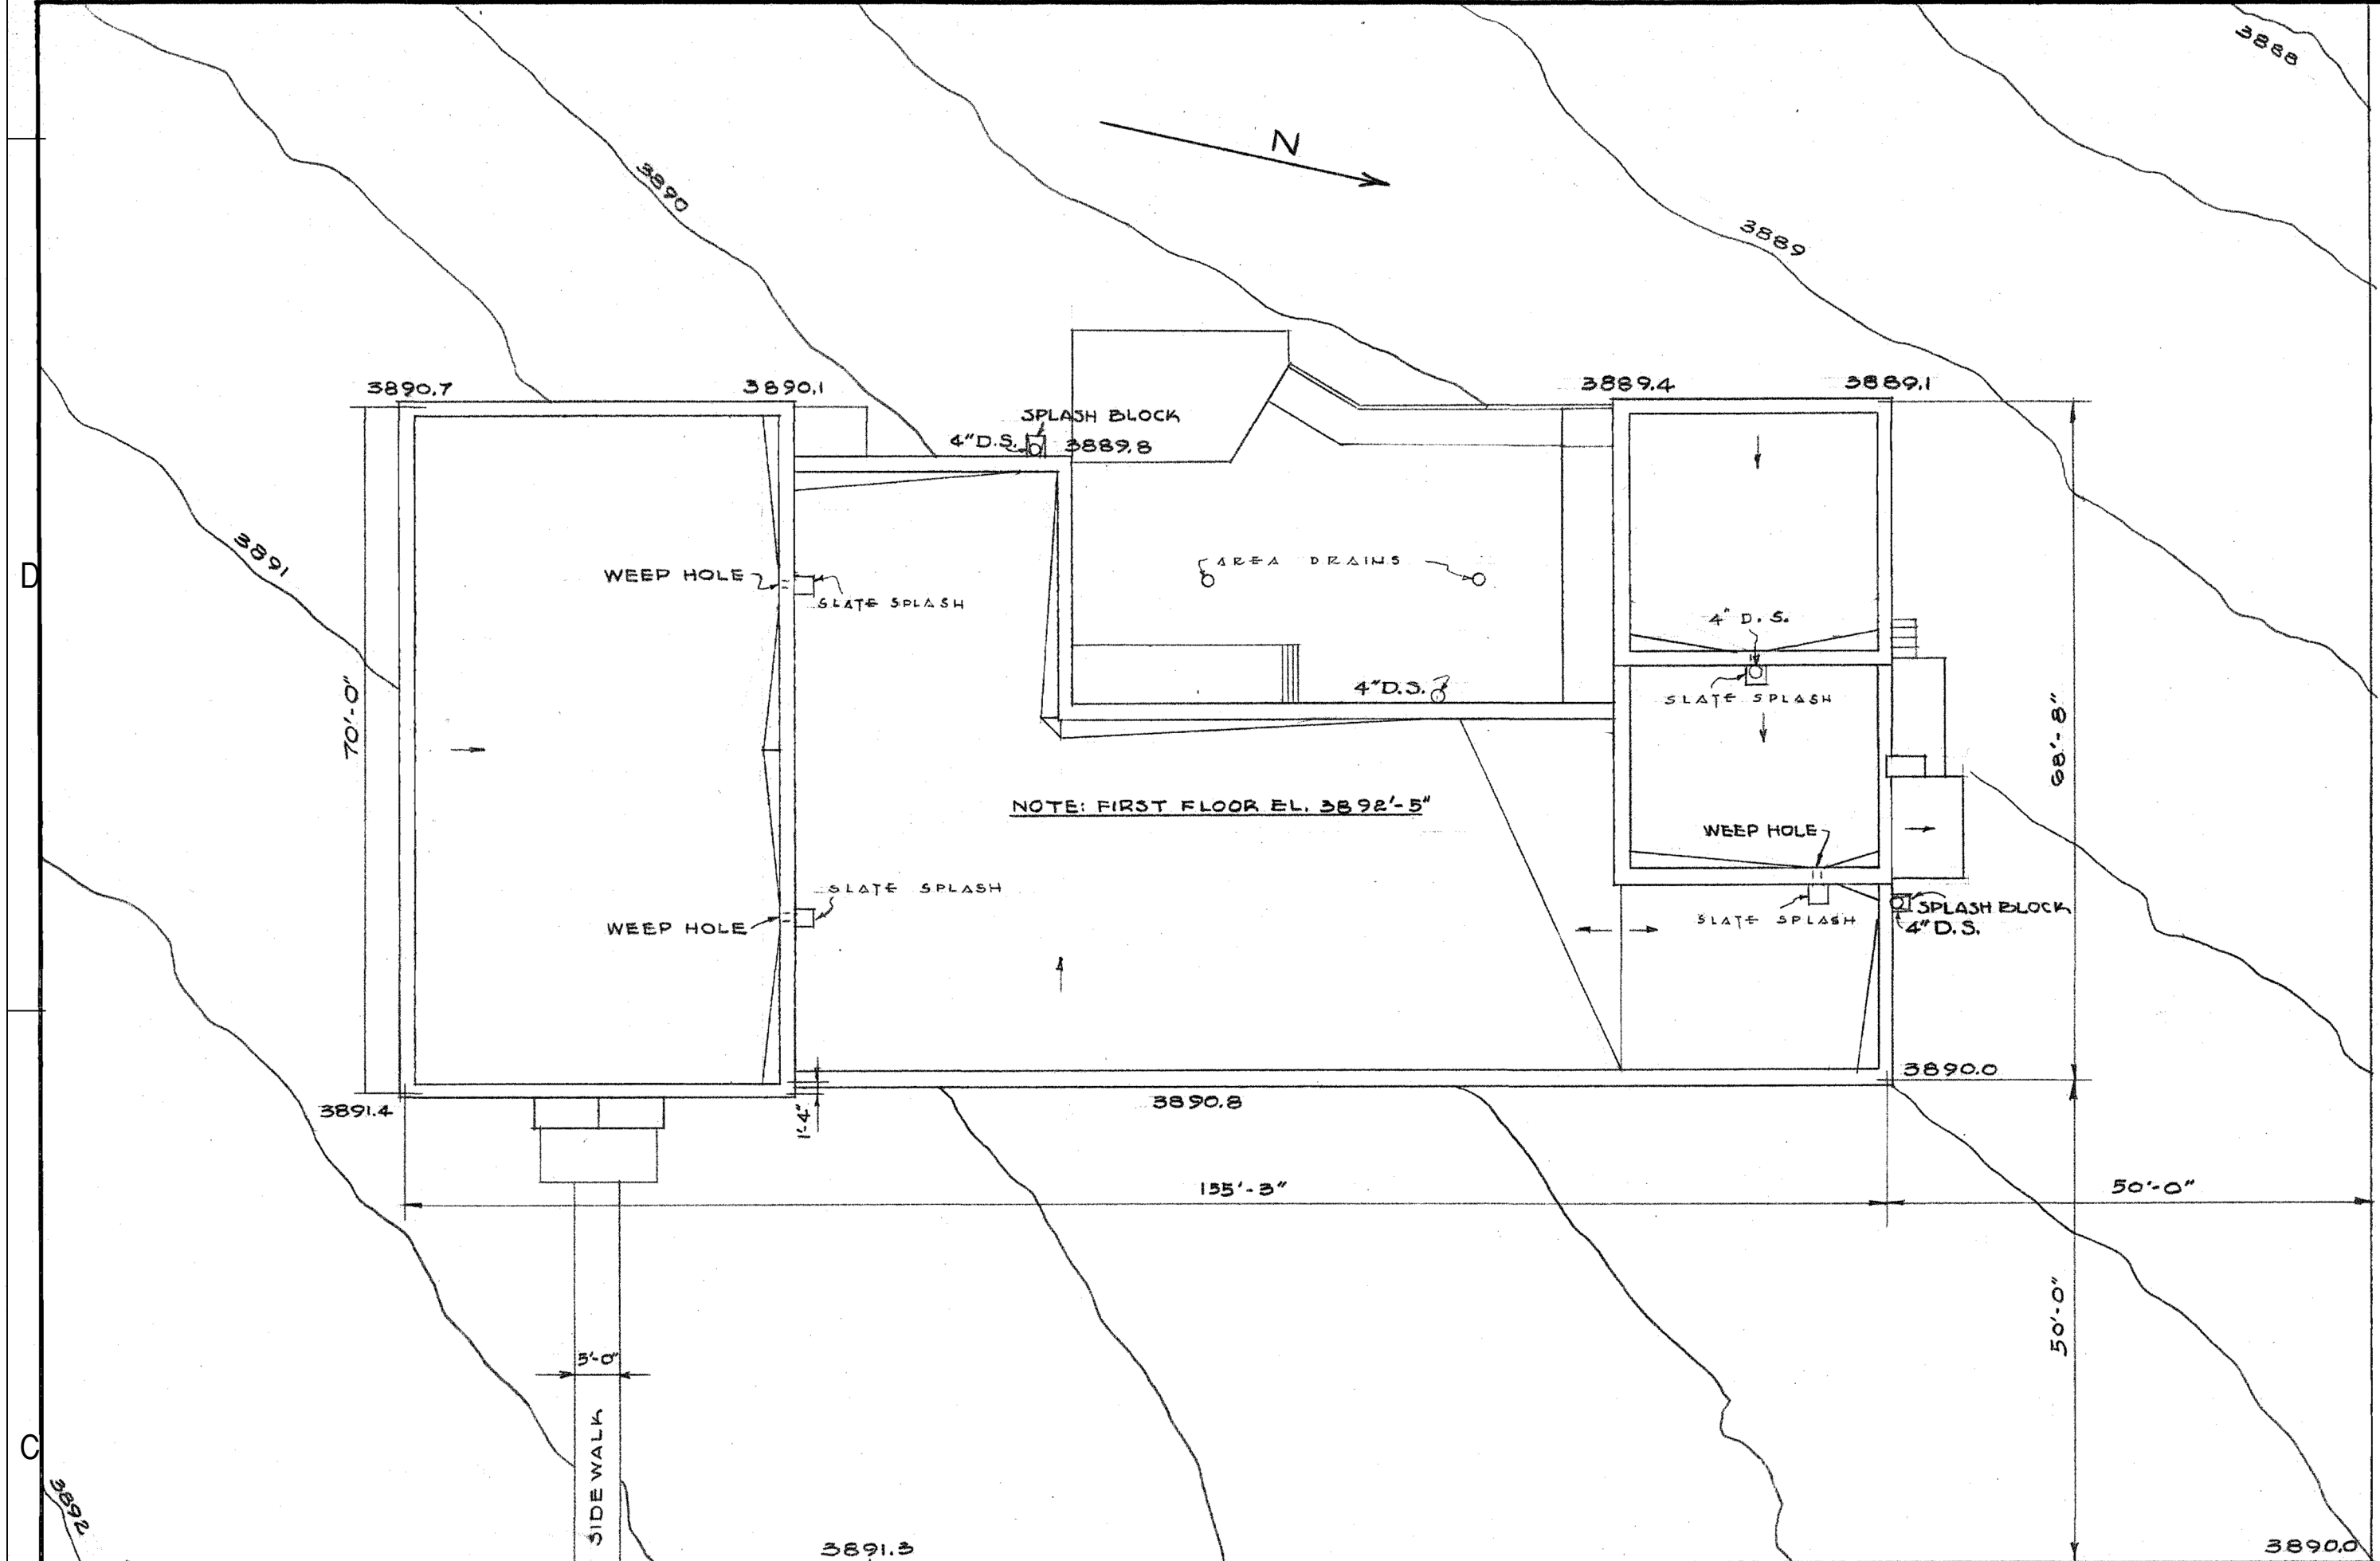**ROOF & PLOT PLAN**  
 SCALE: 1/8" = 1'-0"



**INDEX OF DRAWINGS**

| SHEET NO. | DESCRIPTION                            |
|-----------|--|
| 1         | PLOT PLAN                              |
| 2         | FOUNDATION PLAN                        |
| 3         | FRAMING PLAN                           |
| 4         | STRUCTURAL DETAILS                     |
| 5         | FLOOR PLAN                             |
| 6         | ELEVATIONS                             |
| 7         | SECTION THRU BUILDING                  |
| 8         | WINDOW & DOOR DETAILS                  |
| 9         | ENTRANCE & REFRIGERATOR                |
| M1        | PLUMBING                               |
| M2        | HEATING & AIR CONDITIONING             |
| M3        | HEATING & AIR CONDITIONING             |
| M4        | HEATING & AIR CONDITIONING - ALTERNATE |
| E1        | ELECTRICAL                             |

**ROOF & PLOT PLAN CABINET WORK**

AGRICULTURAL SCIENCE BUILDING  
 FOR NEW MEXICO COLLEGE OF AGRICULTURE & MECHANIC ARTS  
 STATE COLLEGE, NEW MEXICO

**SCHAEFER & MERRELL**  
 ARCHITECTS  
 CLOVIS, NEW MEXICO

JOB NO. 277  
 DATE DEC. 19, 1950  
 REVISIONS

STATE OF NEW MEXICO  
 SCHAEFER & MERRELL  
 ARCHITECTS  
 CLOVIS, N.M.

DRN WCH  
 CHECKED PLL  
 SHEET NO. 1 OF 9

ARCHITECT



**AG MOD PHASE 3: NEALE HALL DEMO**

**95% CONSTRUCTION DOCUMENTS**

3198 S. Espina St  
 Las Cruces, NM 88001

MARCH 12, 2024

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 CHECKED BY: Checker

SHEET TITLE  
 EXISTING PLANS


**AE-101**

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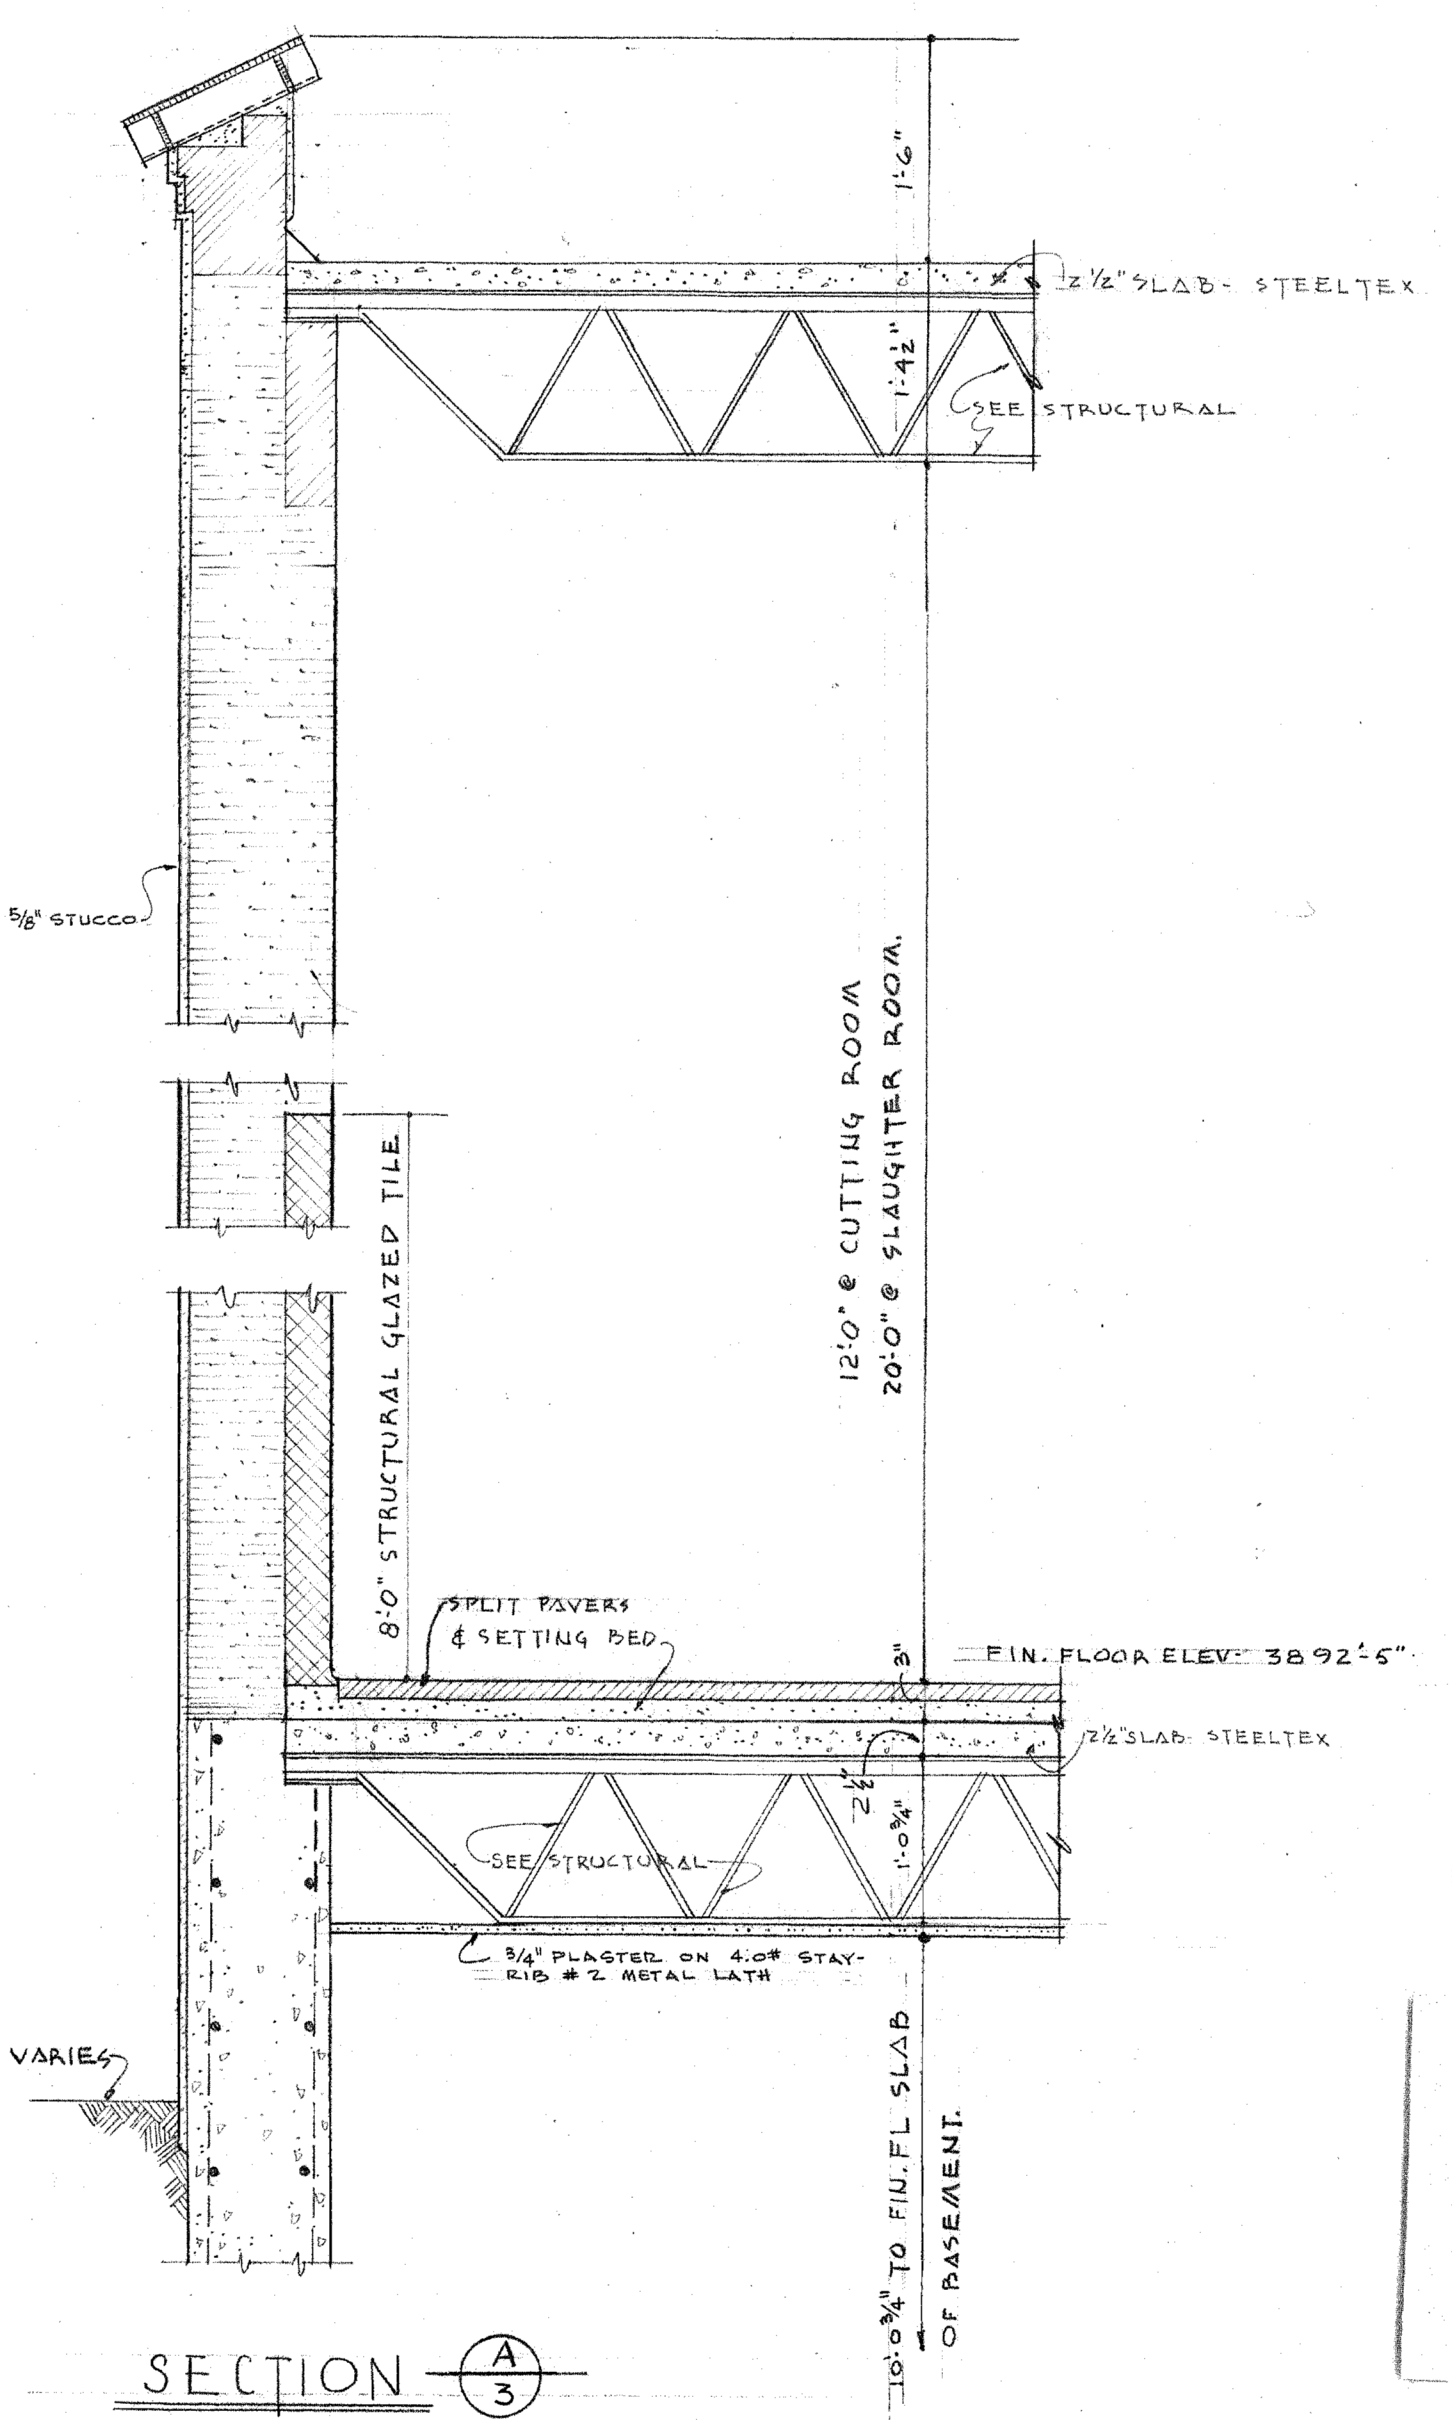


**ROOF FRAMING PLAN**

SCALE: 1/8" = 1'-0"


REFERENCE IDENTIFICATION PLANS

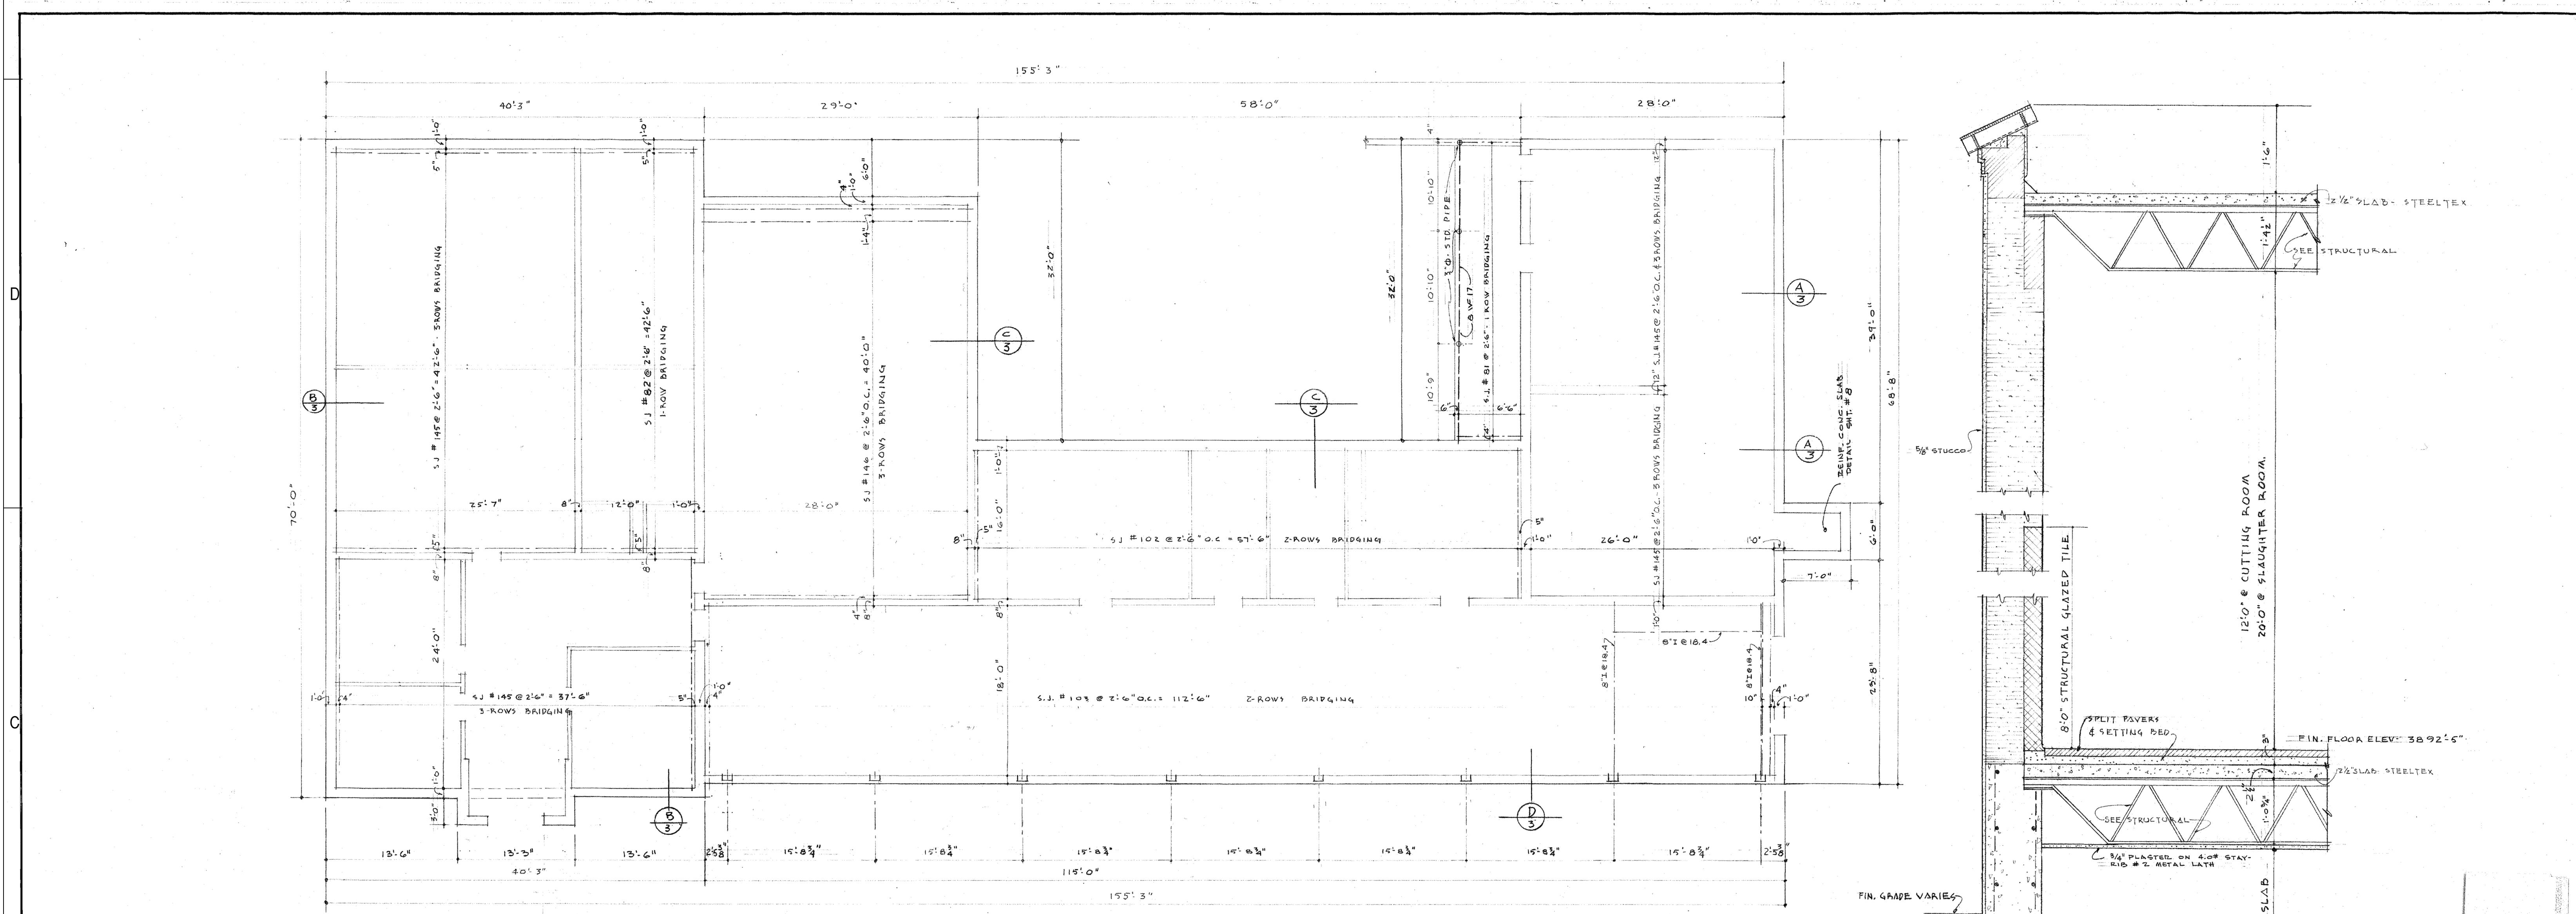8'-6" 4'-2" 0  
1/8" = 1'-0"



**SECTION A-3**

SCALE: 3/4" = 1'-0"

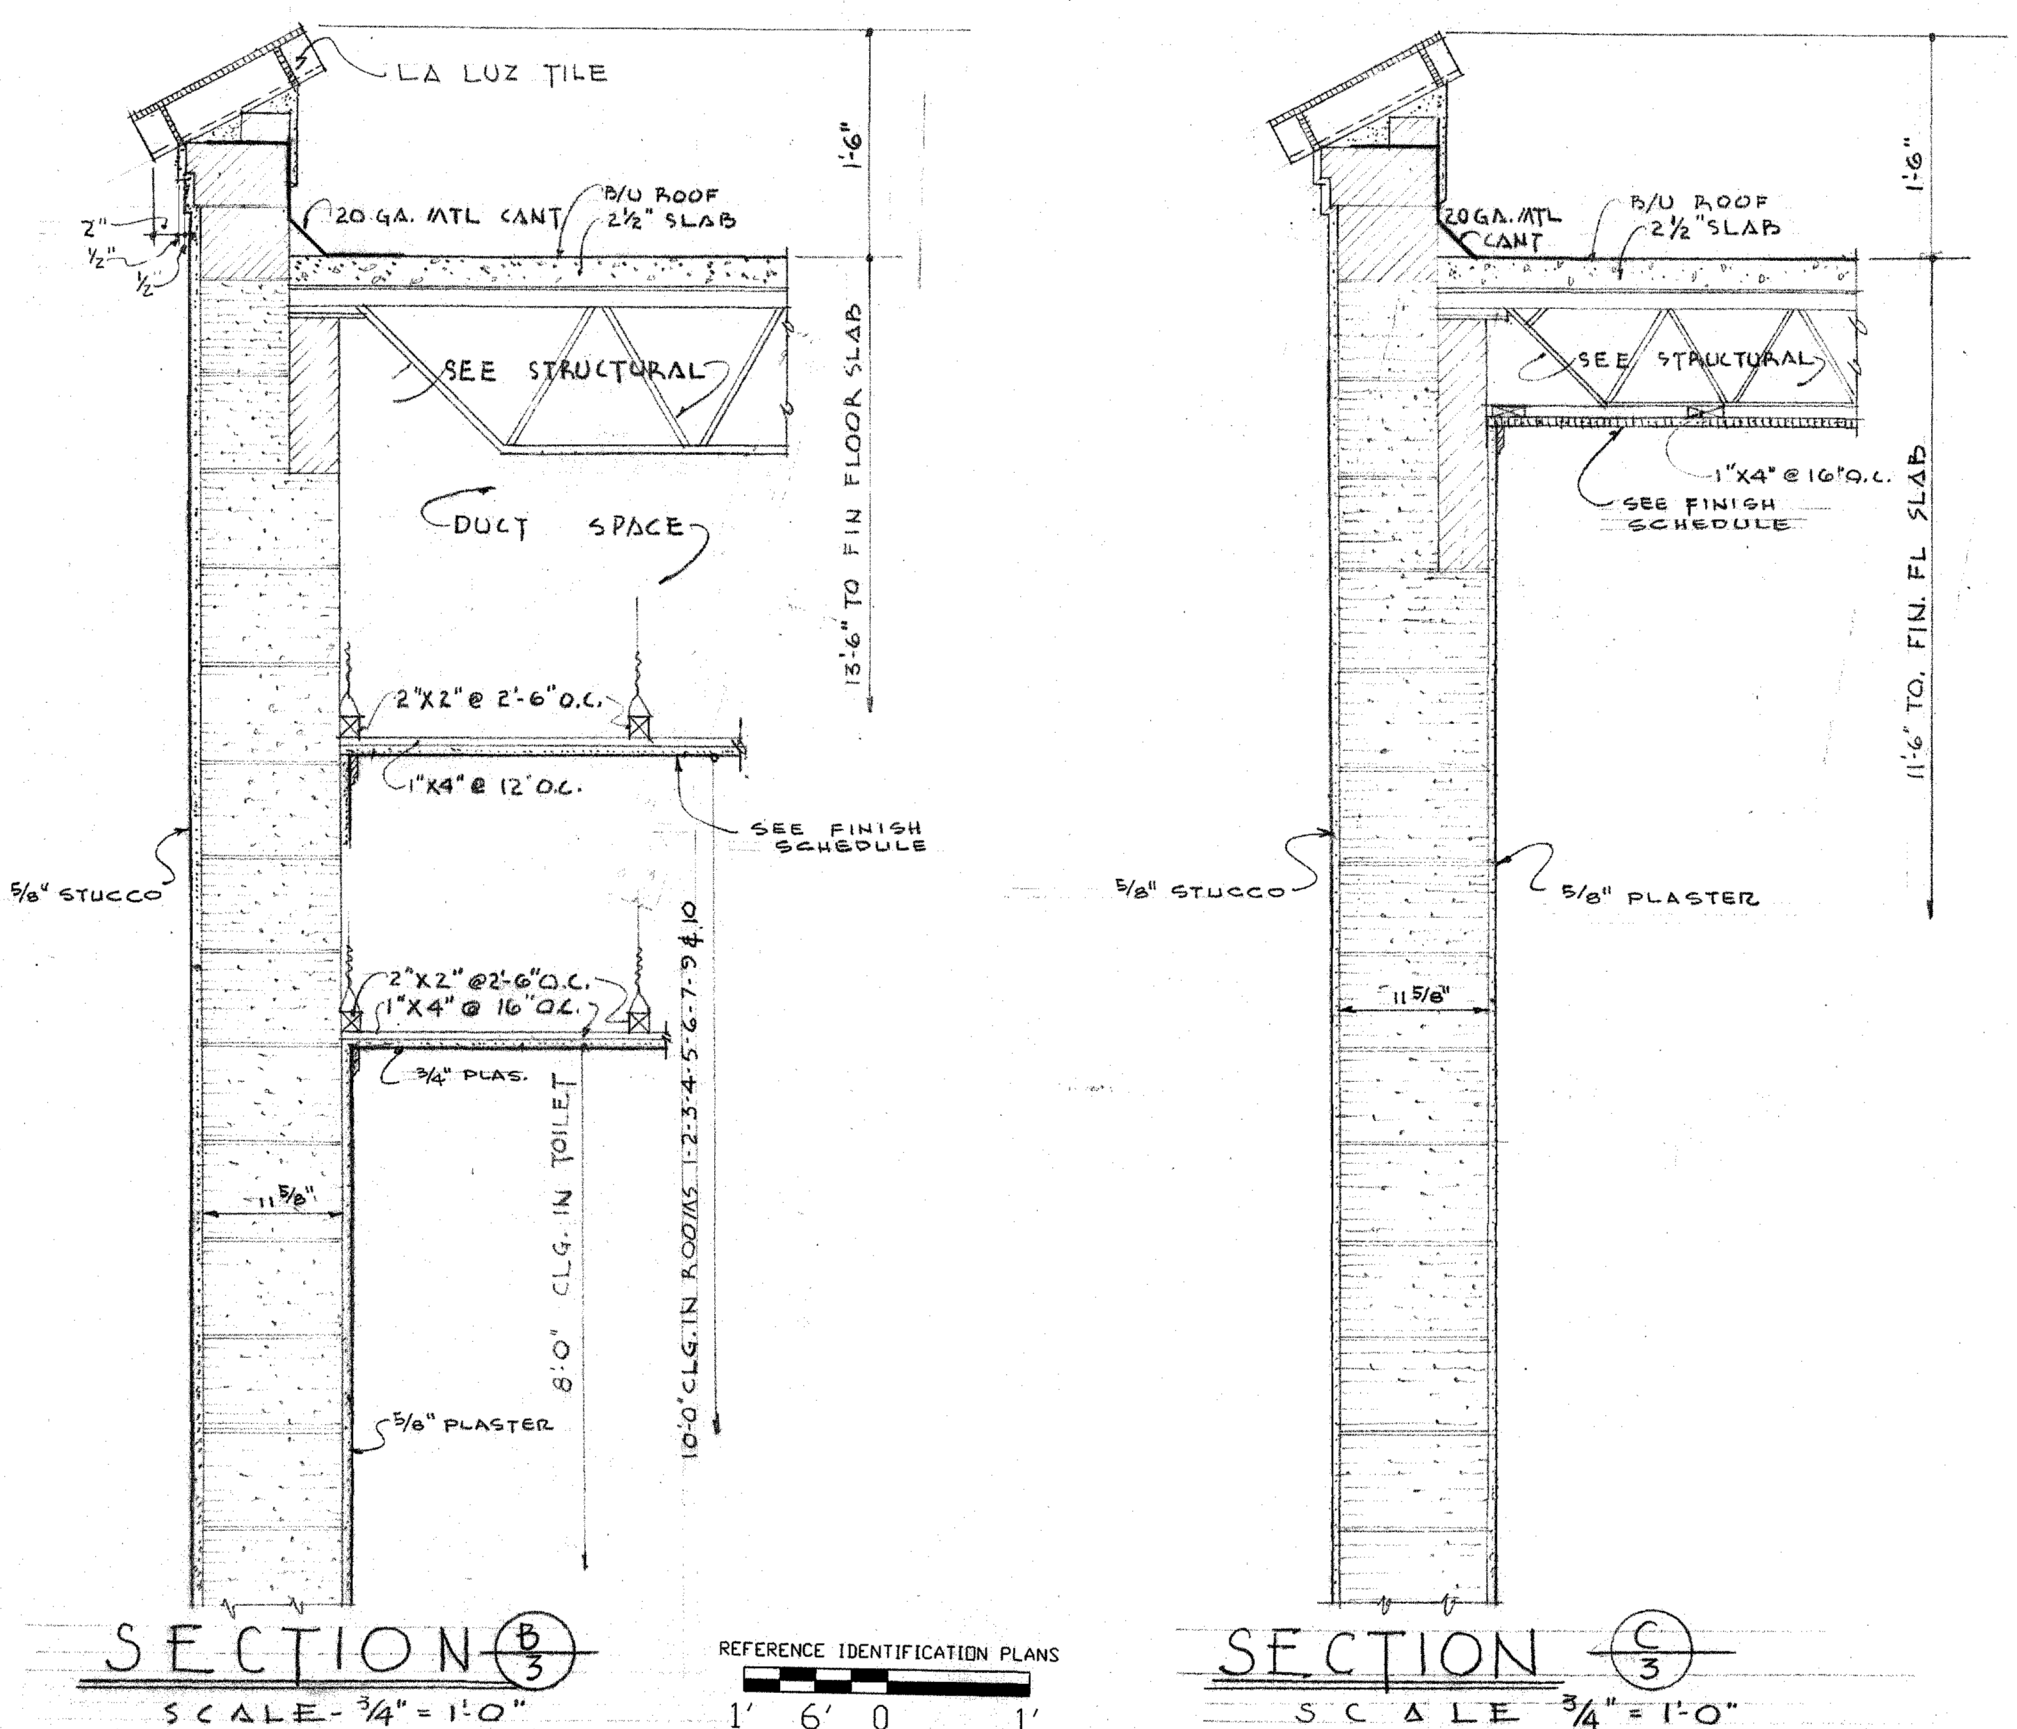

**SECTION B-3**


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REFERENCE IDENTIFICATION PLANS

1'-6" 0  
3/4" = 1'-0"

**SECTION C-3**


SCALE: 3/4" = 1'-0"

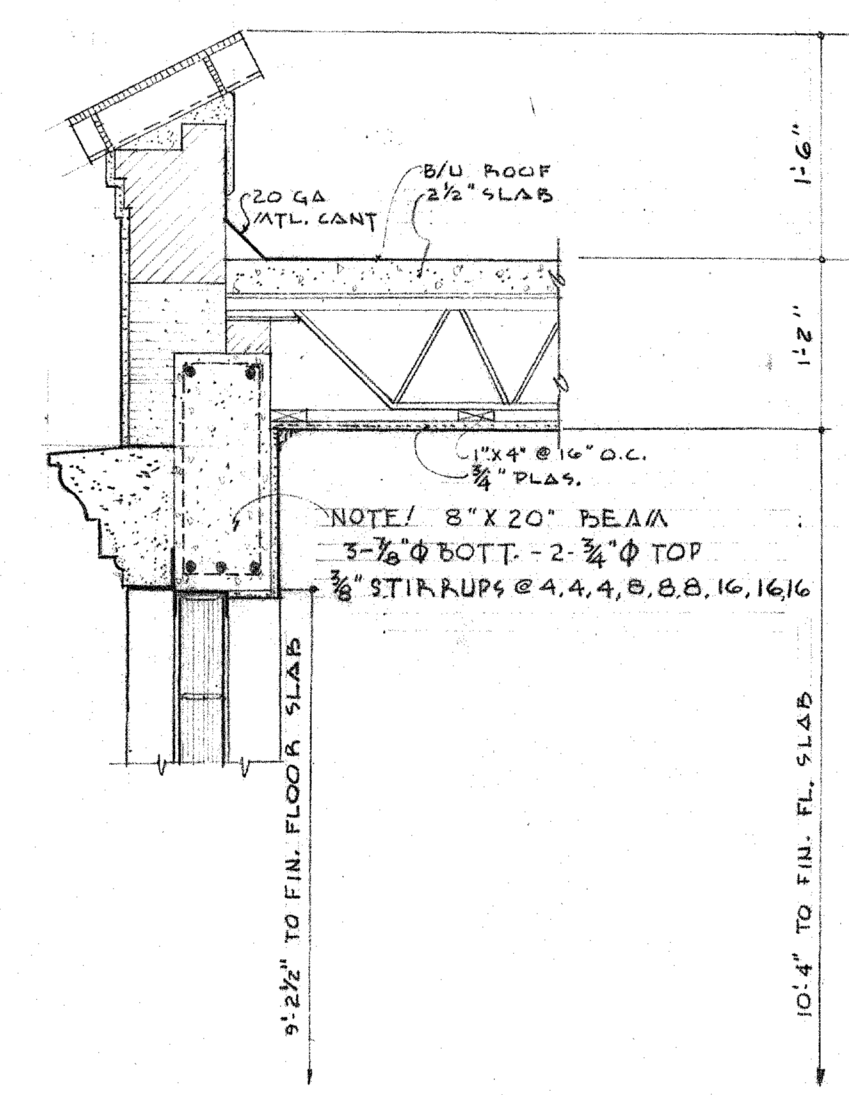

**SECTION D-3**

| LINTEL SCHEDULE |                      |
|-----------------|----------------------|
| 1               | 3-3/2 X 3 1/2 X 1/4  |
| 2               | 1-12 W 27 X 11 X 1/4 |
| 3               | 1-14 W 30 X 11 X 1/4 |
| 4               | 1-8 W 17 X 11 X 1/4  |
| 5               | 1-8 W 17 X 11 X 1/4  |
| 6               | 1-8 W 17 X 11 X 1/4  |
| 7               | 3-5/2 X 3 1/2 X 1/4  |
| 8               | 1-0 W 21 X 11 X 1/4  |

**SECTION D-3**

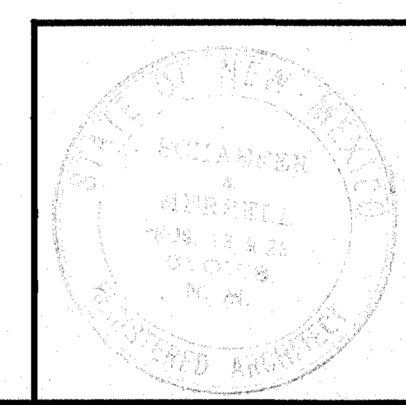

AGRICULTURAL SCIENCE BUILDING  
FOR NEW MEXICO COLLEGE OF  
AGRICULTURE & MECHANIC ARTS  
STATE COLLEGE, NEW MEXICO

**SCHAEFER & MERRELL**  
ARCHITECTS  
CLOVIS NEW MEXICO

JOB NO. 277  
DATE DEC 19 1990  
REVISIONS

DRAWN BY: HJW  
CHECKED BY: PLL  
SHEET NO. 3  
OF 9

ISSUE:  
DATE:  
PROJECT NO: 773B  
DRAWN BY: Author  
CHECKED BY: Checker


SHEET TITLE  
EXISTING PLANS

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 Phone: 505.883.4111



**AG MOD PHASE 3: NEALE HALL DEMO**

**95% CONSTRUCTION DOCUMENTS**

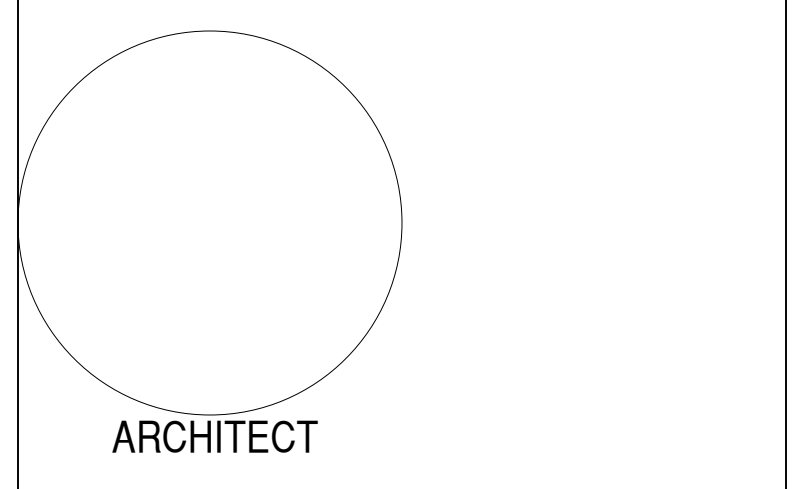3198 S. Espina St  
 Las Cruces, NM 88001


MARCH 12, 2024

| MARK | DATE | DESCRIPTION |
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 DATE:  
 PROJECT NO: 773B  
 DRAWN BY: Author  
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SHEET TITLE  
 EXISTING PLANS

**AE-103**






AGRICULTURAL SCIENCE BUILDING  
 FOR NEW MEXICO COLLEGE OF  
 AGRICULTURE & MECHANIC ARTS  
 STATE COLLEGE, NEW MEXICO

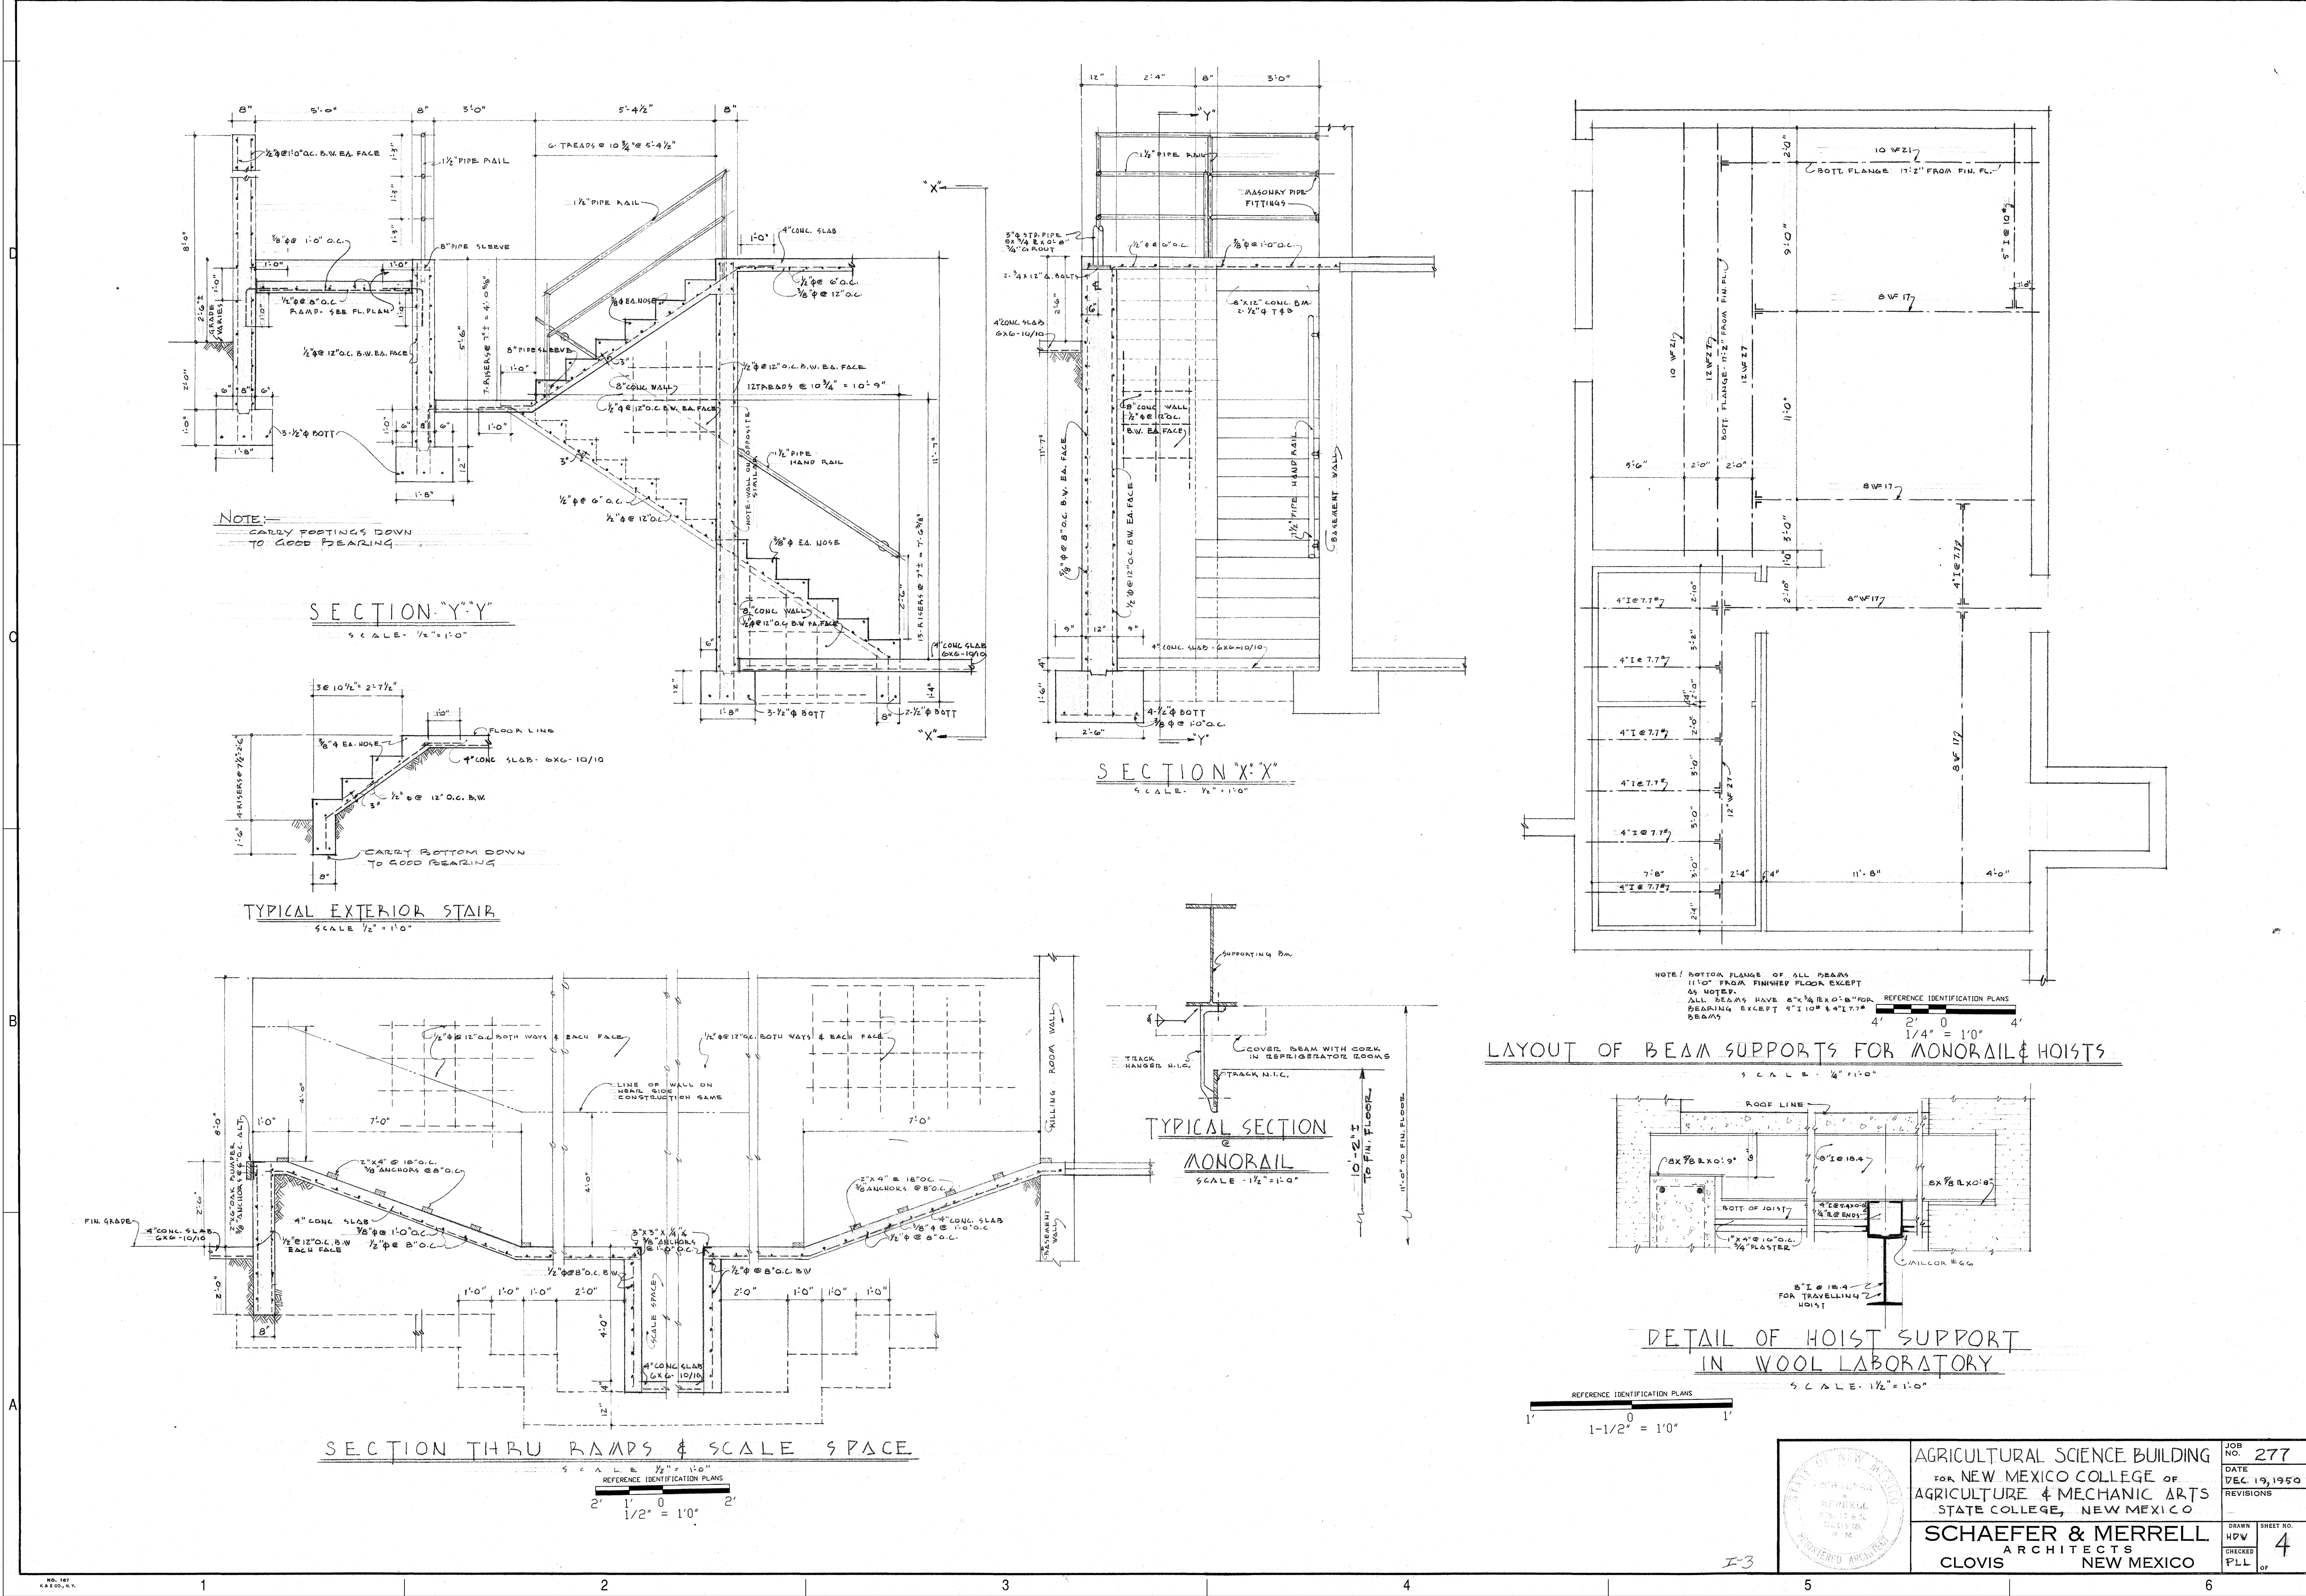**SCHAEFER & MERRELL**  
 ARCHITECTS  
 CLOVIS NEW MEXICO




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 DATE DEC 19, 1950  
 REVISIONS

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 CHECKED: PLL  
 SHEET NO. 4

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| ROOM  | NAME                 | FLOOR        | BASE                   | WAINSCOT               | WALL            | FINISH  | PIC. MOLD       | CEILING        | FINISH | MOLD | REMARKS             |
|-------|----------------------|--------------|------------------------|------------------------|-----------------|---------|-----------------|----------------|--------|------|---------------------|
| 1     | ENTRY                | QUARRY TILE  | QUARRY TILE            | -                      | PLASTER         | PAINT   | -               | COMPO. BRICK   | -      | WOOD |                     |
| 2     | CORRIDOR             | ASPHALT TILE | ASPHALT TILE           | -                      | DO              | DO      | -               | DO             | -      | DO   |                     |
| 3,4,5 | OFFICES              | DO           | DO                     | -                      | DO              | DO      | CONCEALED METAL | DO             | -      | DO   |                     |
| 6,7,8 | LABORATORIES         | DO           | DO                     | -                      | DO              | DO      | DO              | DO             | -      | DO   |                     |
| 9     | RECEIVING            | DO           | DO                     | -                      | DO              | DO      | -               | PLASTER        | PAINT  | DO   |                     |
| 10    | STORAGE              | DO           | DO                     | -                      | DO              | DO      | -               | DO             | DO     | DO   |                     |
| 11,12 | TOILETS              | DO           | DO                     | -                      | CEMENT          | PLASTER | DO              | -              | DO     | DO   |                     |
| 13    | WOOL LAB.            | CEMENT       | STUCCO GLAZ. TILE COVE | STUCCO GLAZ. TILE COVE | PLASTER         | DO      | -               | DO             | DO     | DO   |                     |
| 14    | WOOL STOR.           | DO           | CEMENT                 | -                      | DO              | DO      | -               | DO             | DO     | DO   |                     |
| 15    | HUMIDITY             | DO           | DO                     | -                      | DO              | DO      | -               | DO             | DO     | DO   |                     |
| 16    | DARK ROOM            | DO           | DO                     | -                      | DO              | DO      | -               | DO             | DO     | DO   |                     |
| 17    | SHOWER & TOILET      | CERAMIC TILE | STUCCO GLAZ. TILE COVE | STUCCO GLAZ. TILE COVE | CEMENT PLASTER  | DO      | -               | CEMENT PLASTER | DO     | DO   |                     |
| 18    | SLAUGHTER RM.        | SPLIT PAVING | DO                     | STUCCO GLAZ. TILE COVE | EXPOSED MASONRY | DO      | -               | EXPOSED        | DO     | -    |                     |
| 19    | CUTTING ROOM         | DO           | DO                     | -                      | DO              | DO      | -               | DO             | DO     | DO   |                     |
| 20,21 | CHILL & HOLD REFRIG. | CEMENT       | CEMENT                 | -                      | CEMENT PLASTER  | DO      | -               | CEMENT PLASTER | DO     | -    | SEE DETAILS         |
| 22    | SMOKE ROOM           | DO           | -                      | -                      | EXPOSED MASONRY | DO      | -               | EXPOSED        | DO     | -    |                     |
| 23    | JANITOR'S SLO.       | DO           | CEMENT                 | -                      | PLASTER         | DO      | -               | PLASTER        | -      | -    | SEE DETAIL SHT. # 4 |
| B-1   | BASEMENT             | CEMENT       | -                      | -                      | EXPOSED CONCR.  | -       | -               | PLASTER        | -      | -    |                     |
| B-2   | HIDE ROOM            | DO           | -                      | -                      | EXPOSED MASONRY | -       | -               | DO             | -      | -    |                     |
| B-3   | FIRE PIT             | FIRE BRICK   | -                      | -                      | FIRE BRICK      | -       | -               | -              | -      | -    | SEE DETAIL SHT. # 7 |

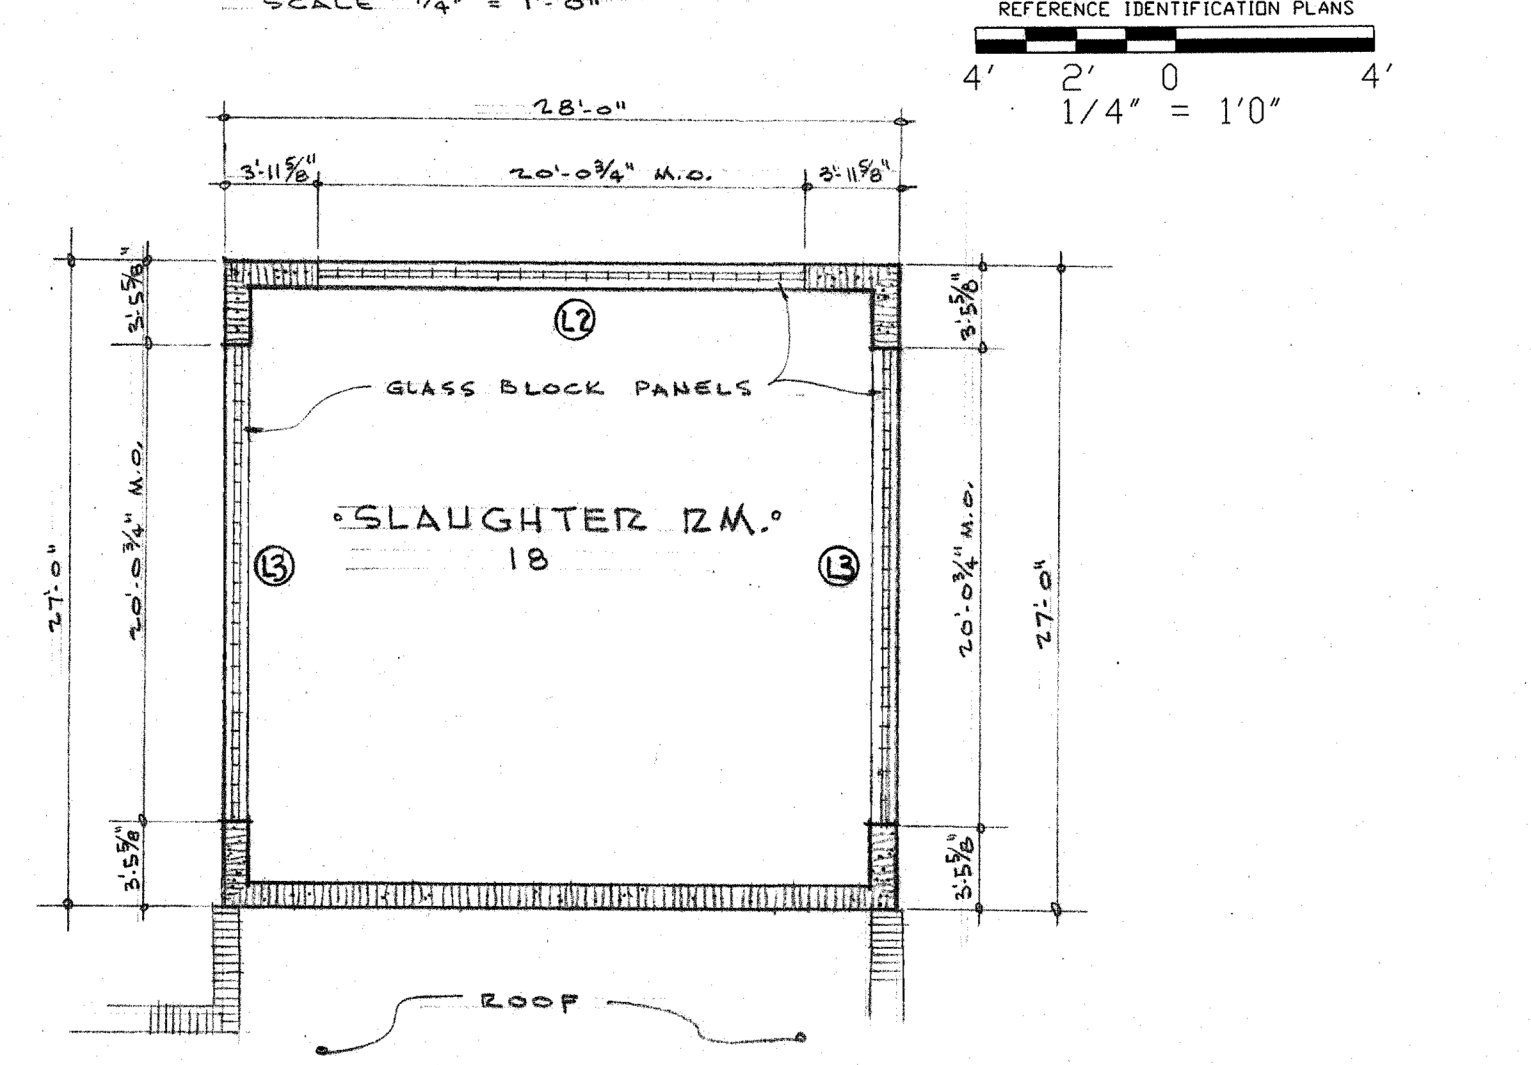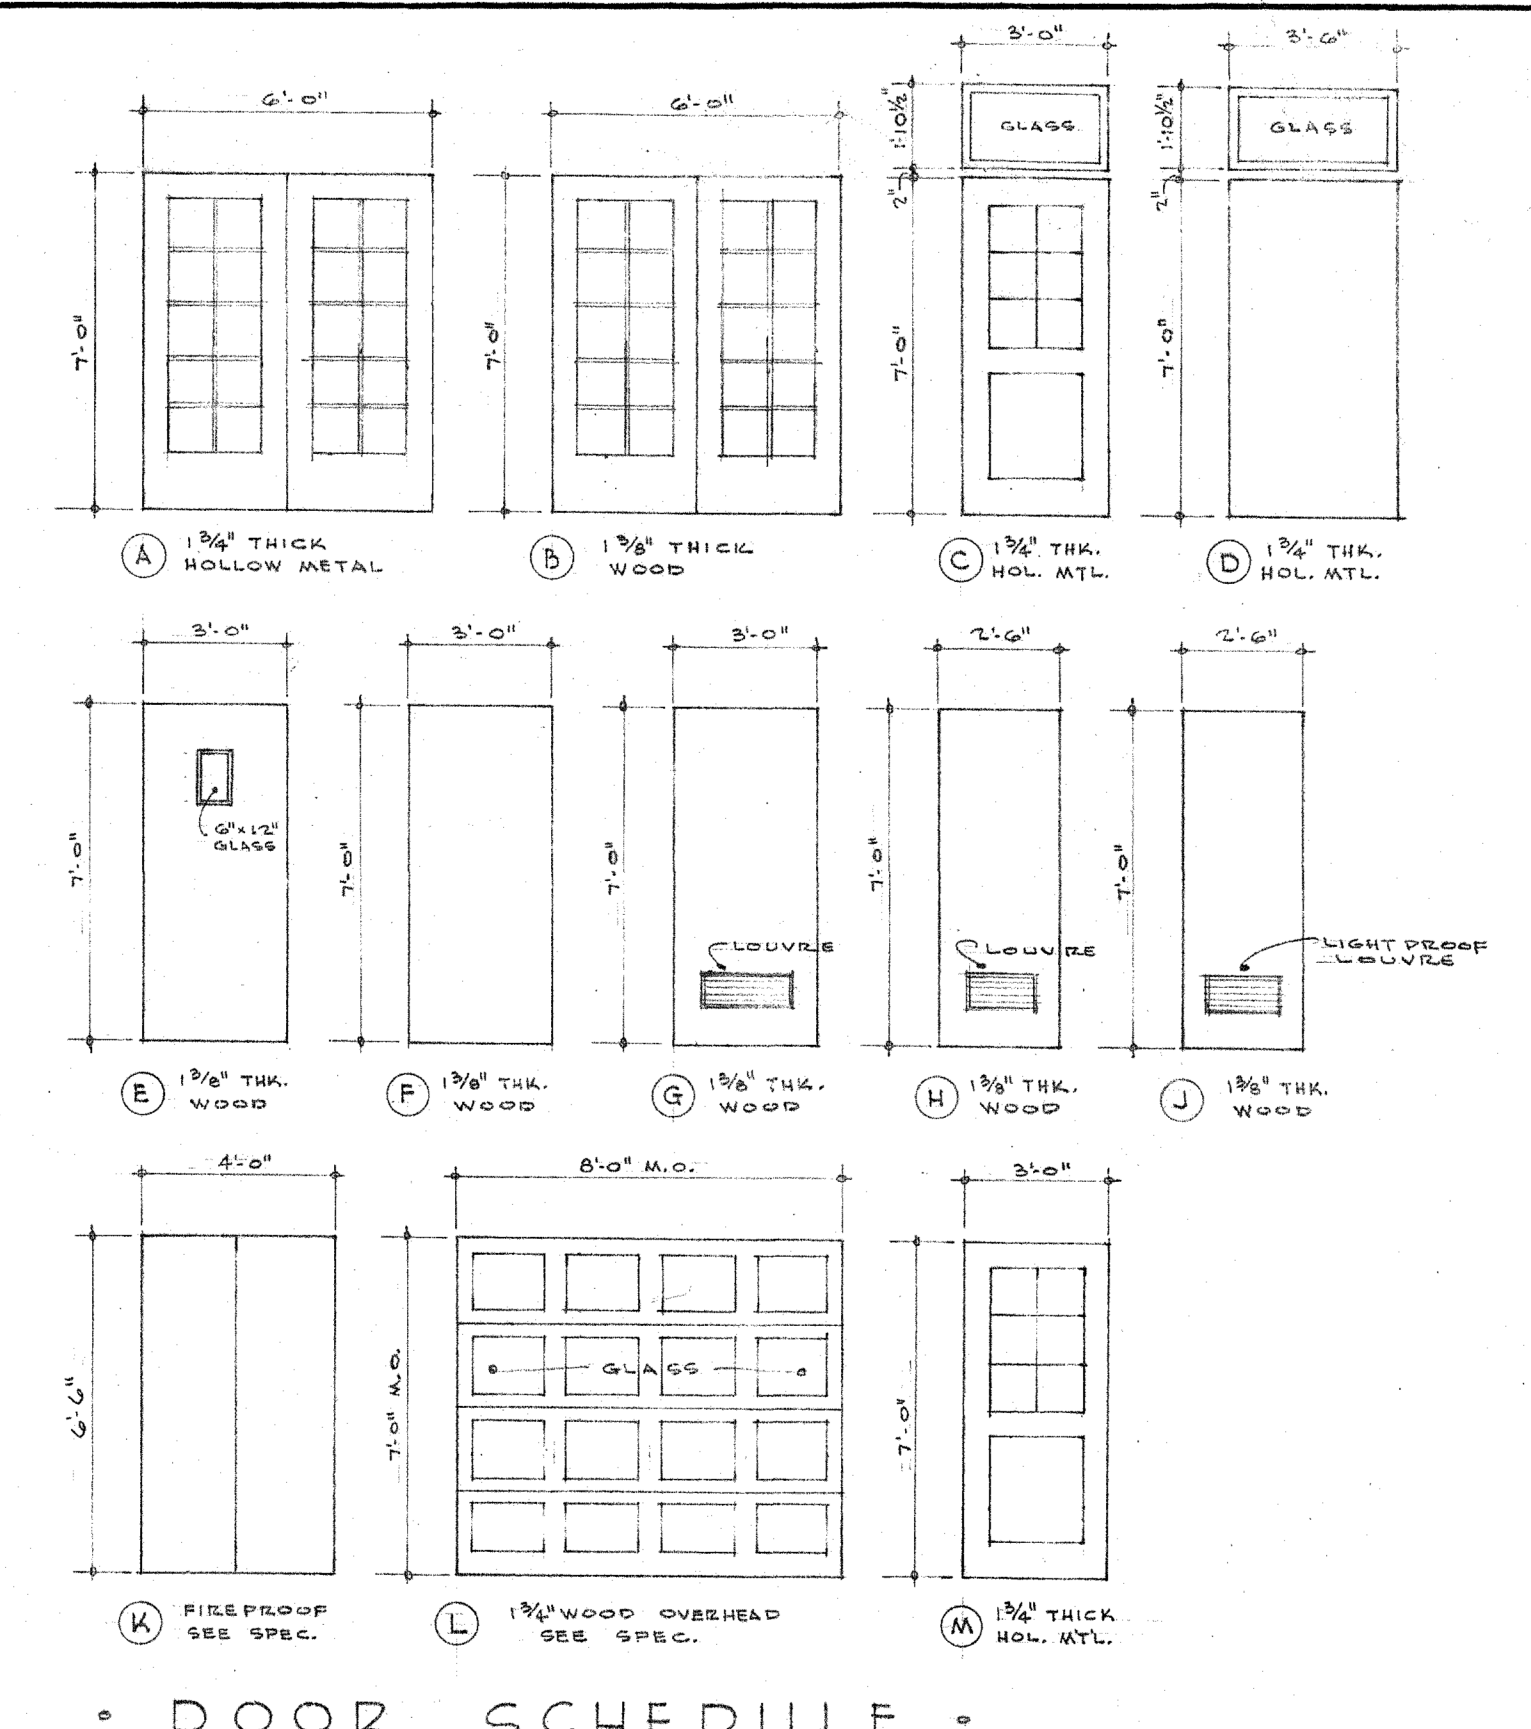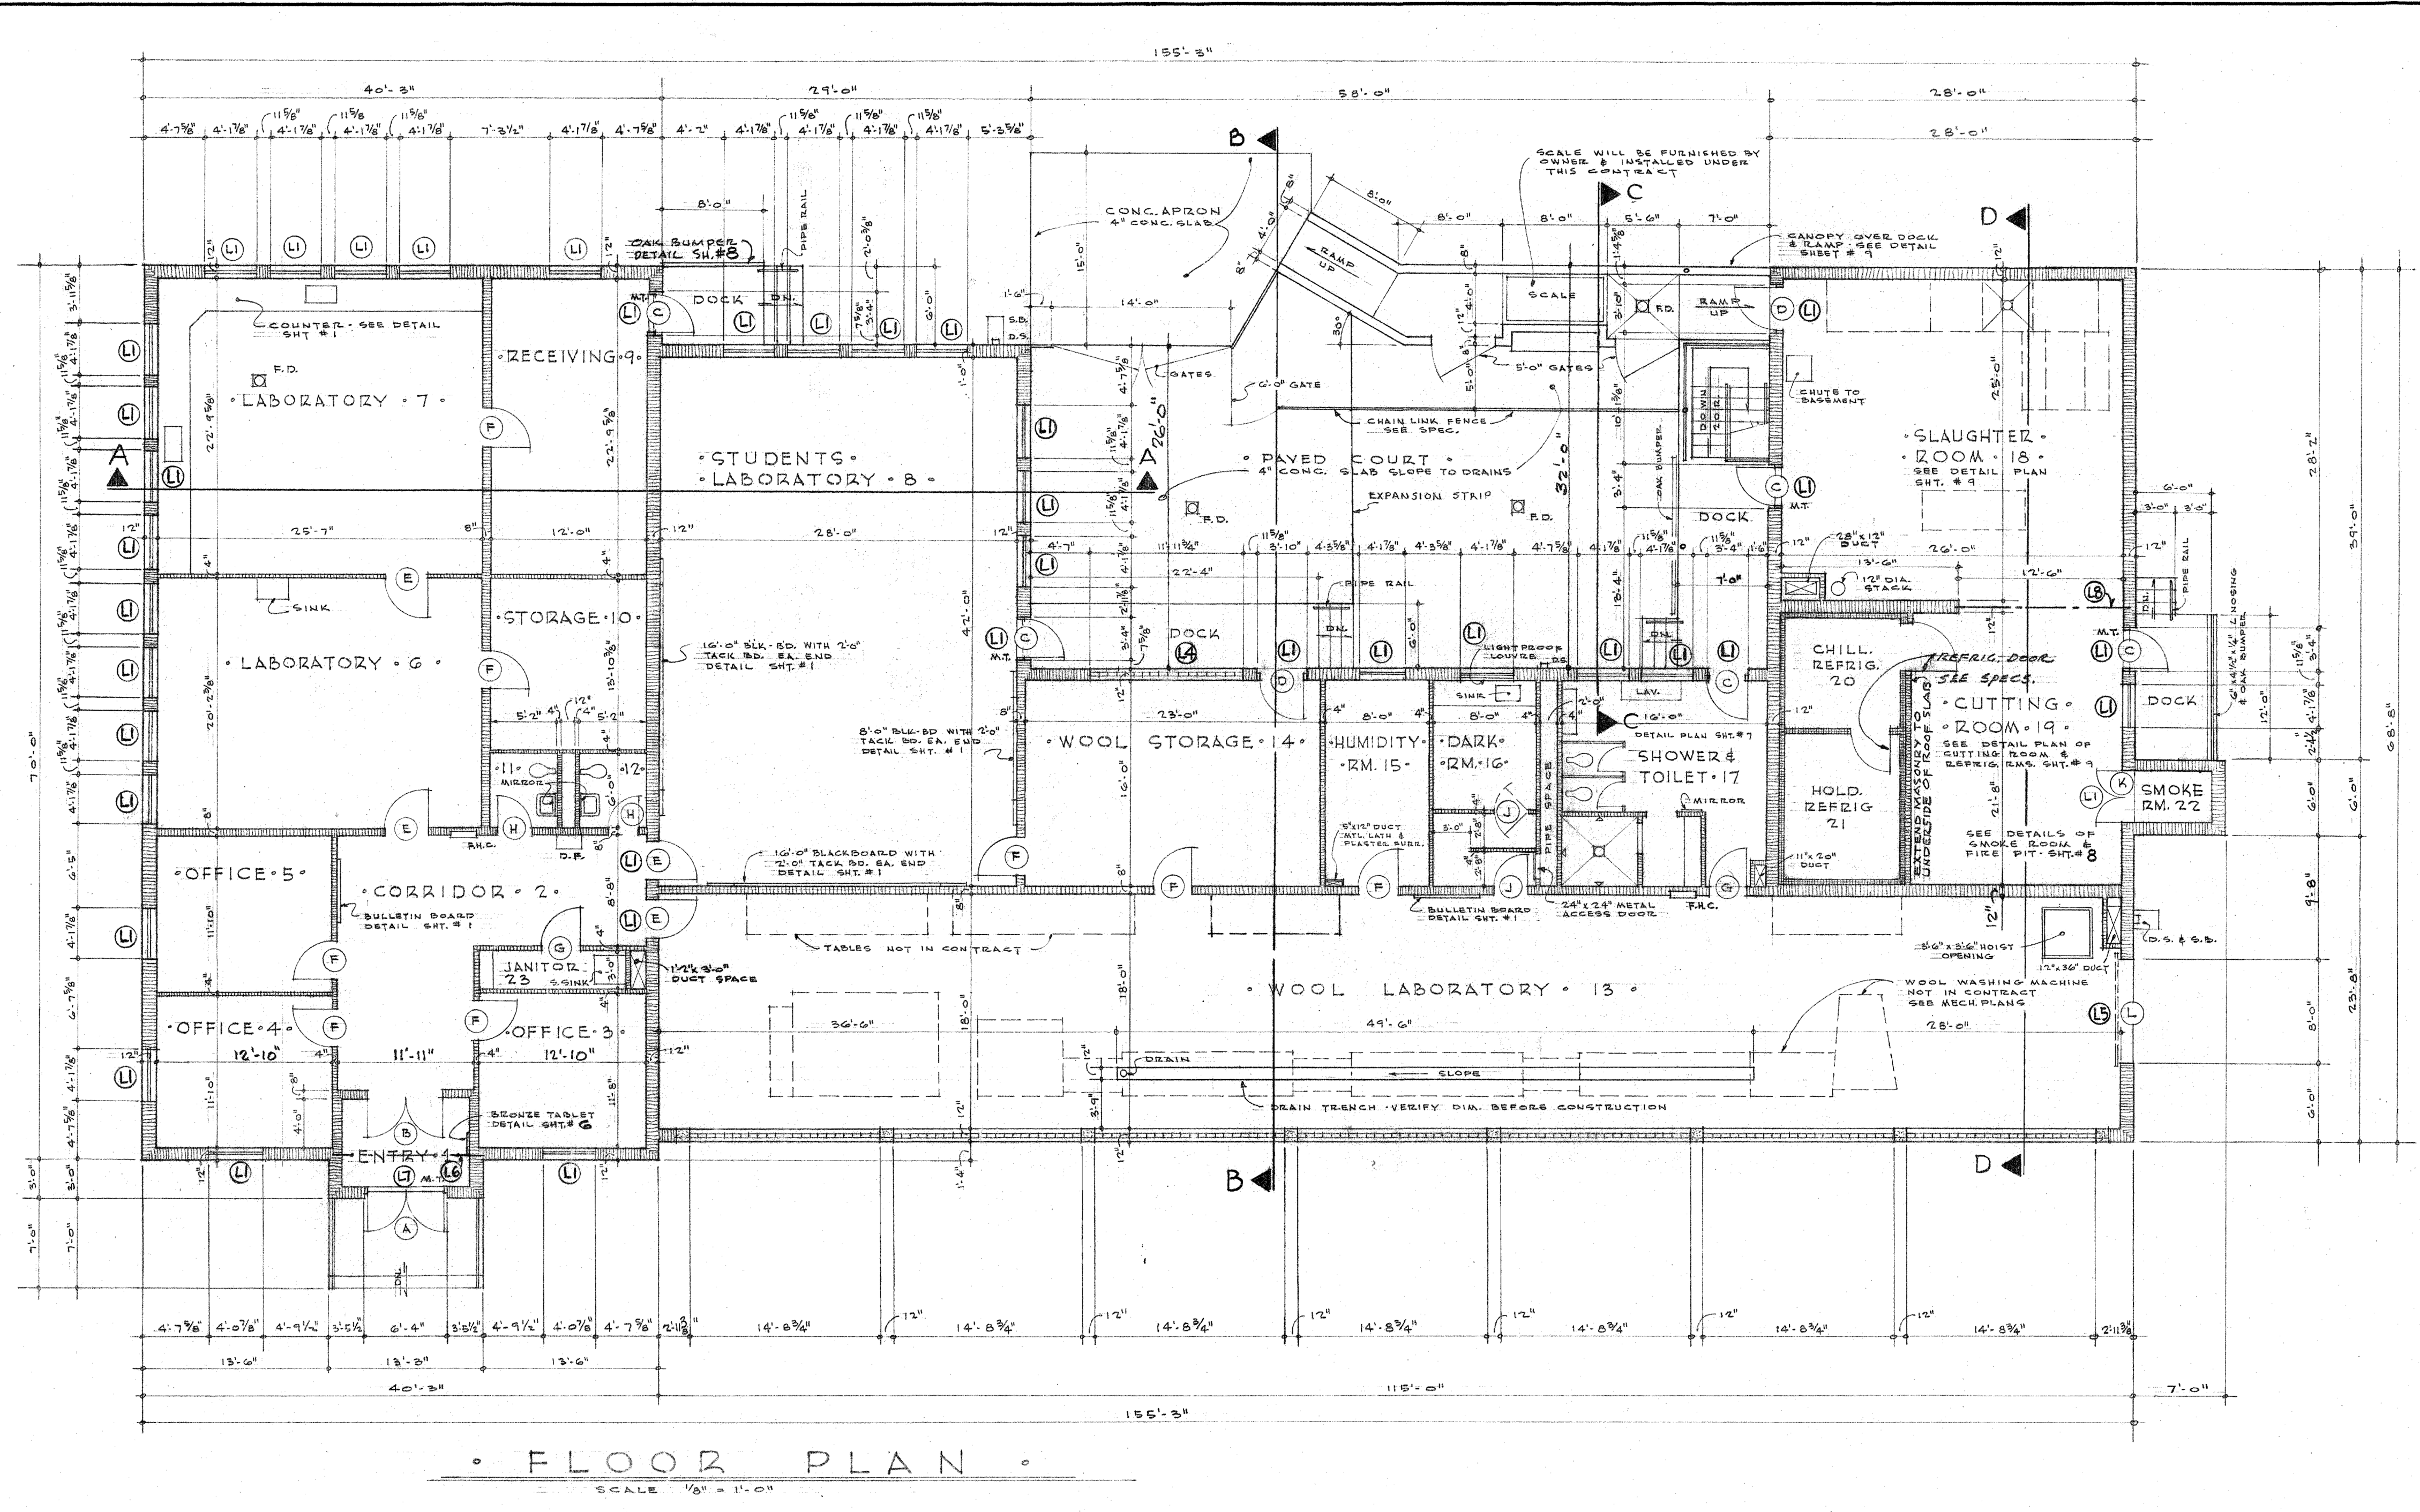

**FLOOR PLAN**

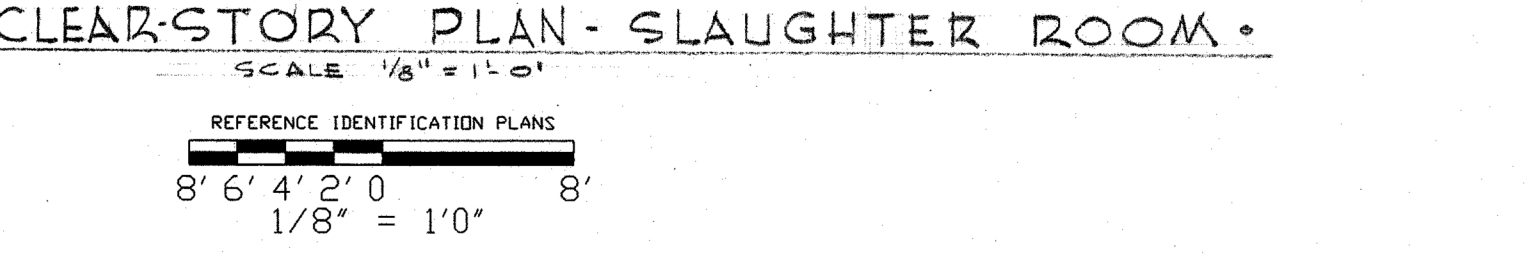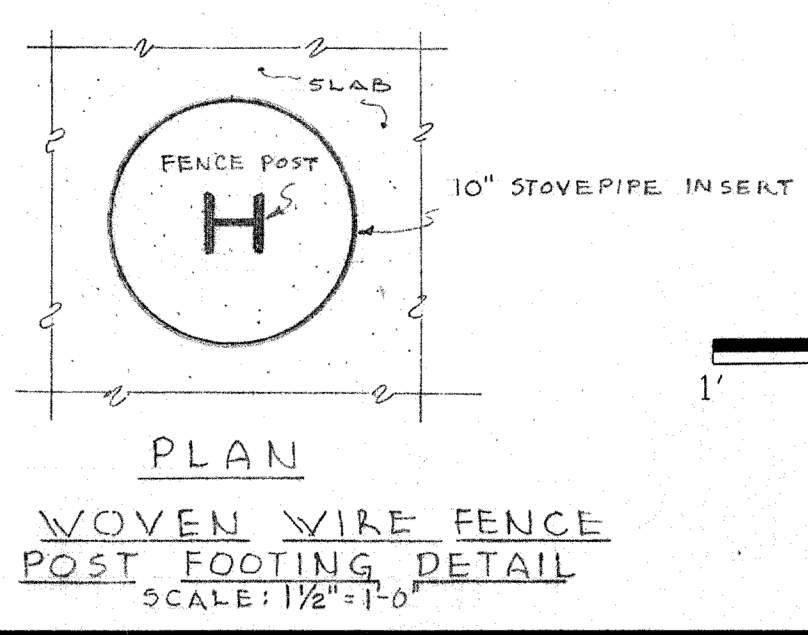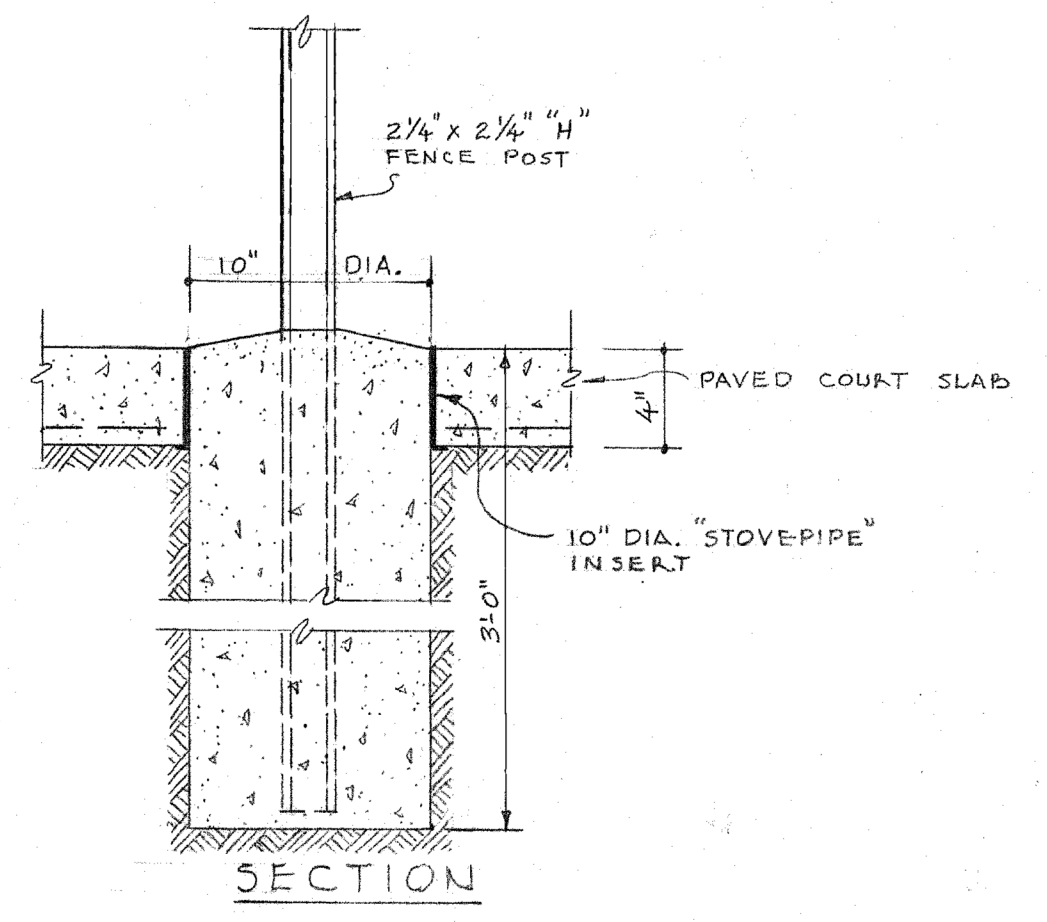STATE OF NEW MEXICO  
 SCHAEFER & MERRELL  
 ARCHITECTS  
 CLOVIS, NEW MEXICO

AGRICULTURAL SCIENCE BUILDING  
 FOR NEW MEXICO COLLEGE OF  
 AGRICULTURE & MECHANIC ARTS  
 STATE COLLEGE, NEW MEXICO

SHEET NO. 277  
 DATE DEC. 19, 1950  
 REVISIONS  
 DRAWN BY: Author  
 CHECKED BY: Checker

DATE: 3/14/2024 5:00:02 PM

**AG MOD PHASE 3: NEALE HALL DEMO**  
**95% CONSTRUCTION DOCUMENTS**  
 3198 S. Espina St  
 Las Cruces, NM 88001  
 MARCH 12, 2024

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SHEET TITLE  
 EXISTING PLANS




AE-104

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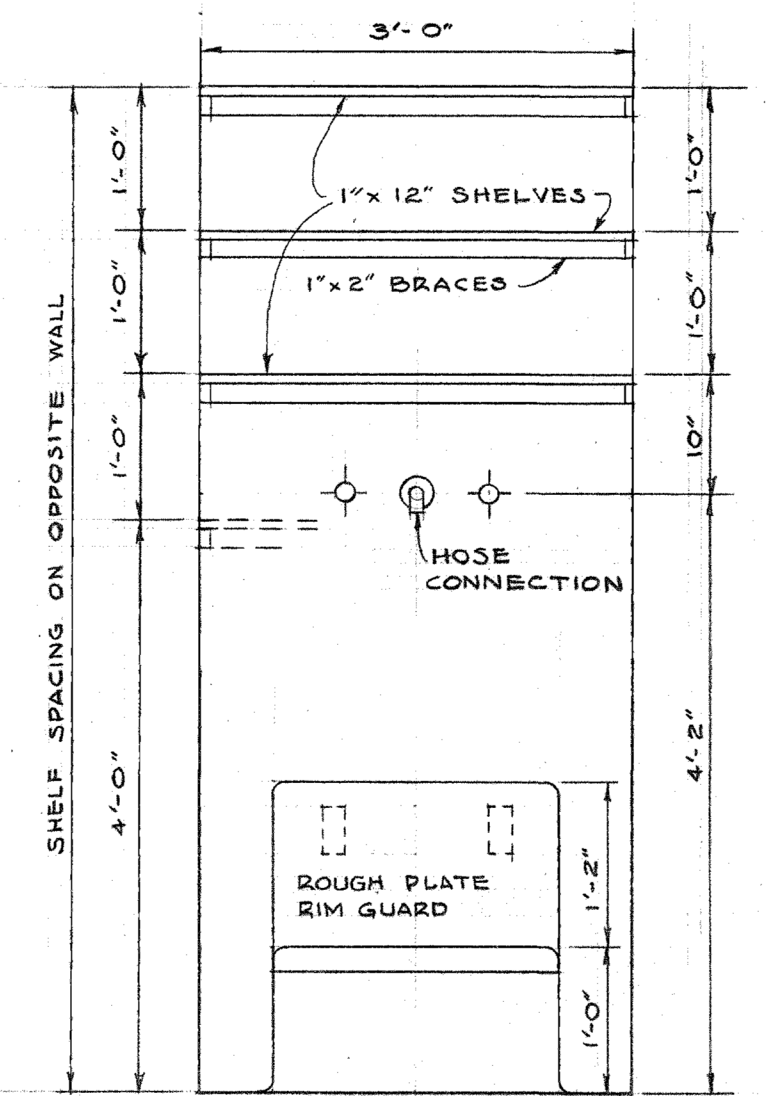
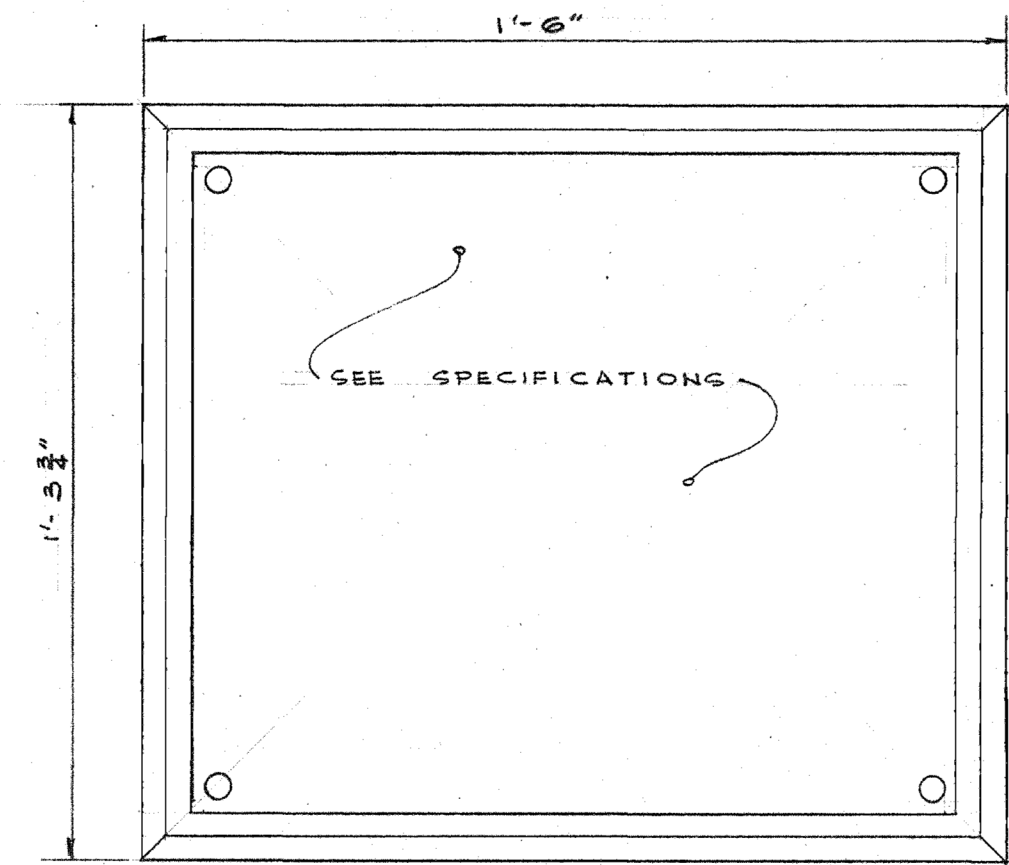
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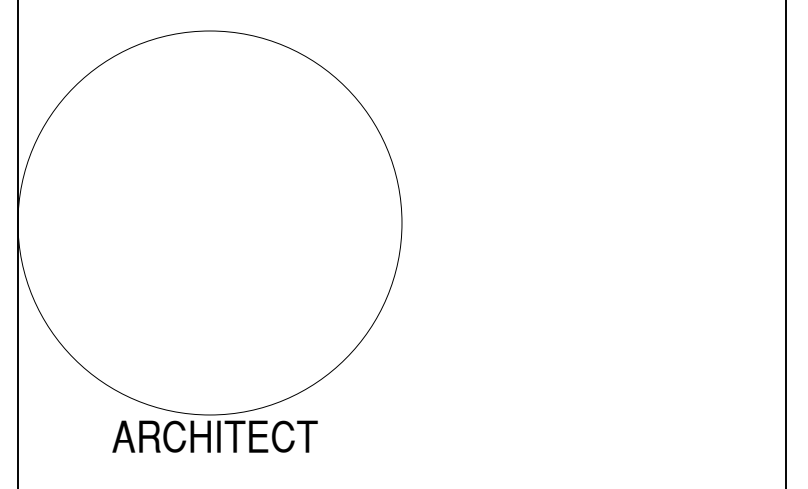
**LO BR HD PRE**

F.S. LETTER DETAILS



**ELEVATIONS & WINDOW SCHEDULE**
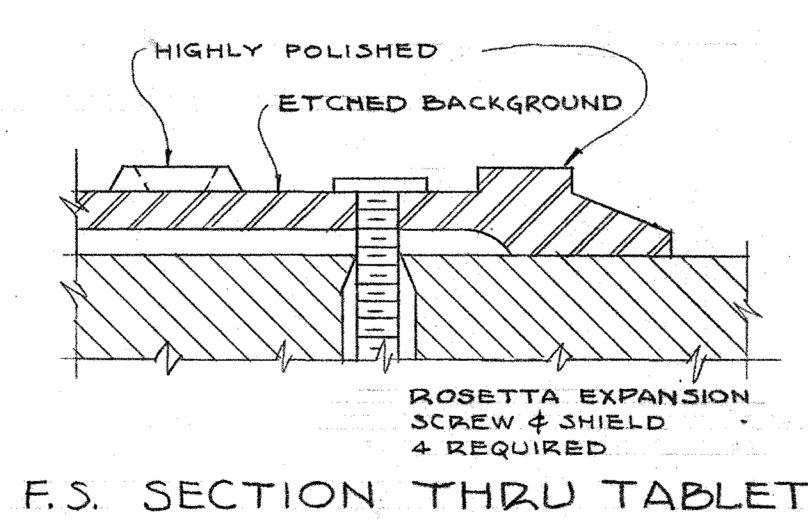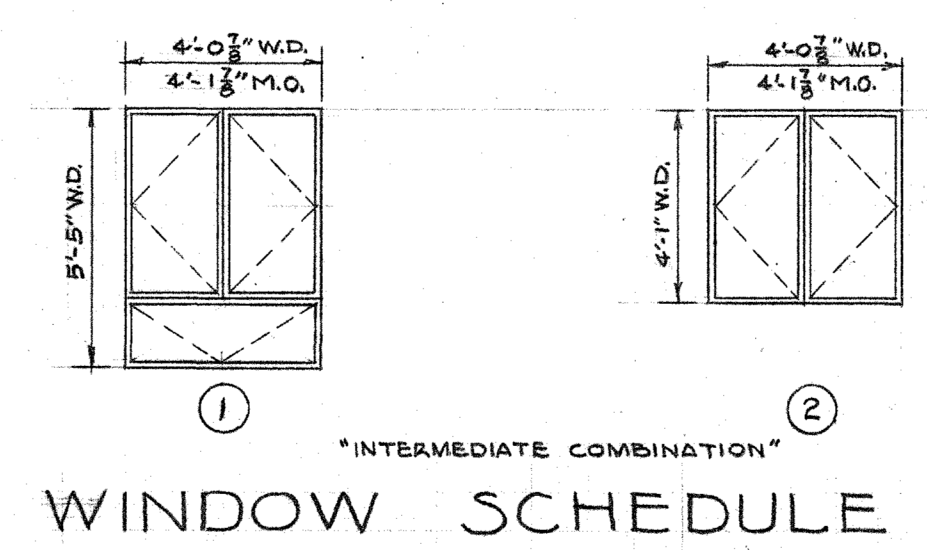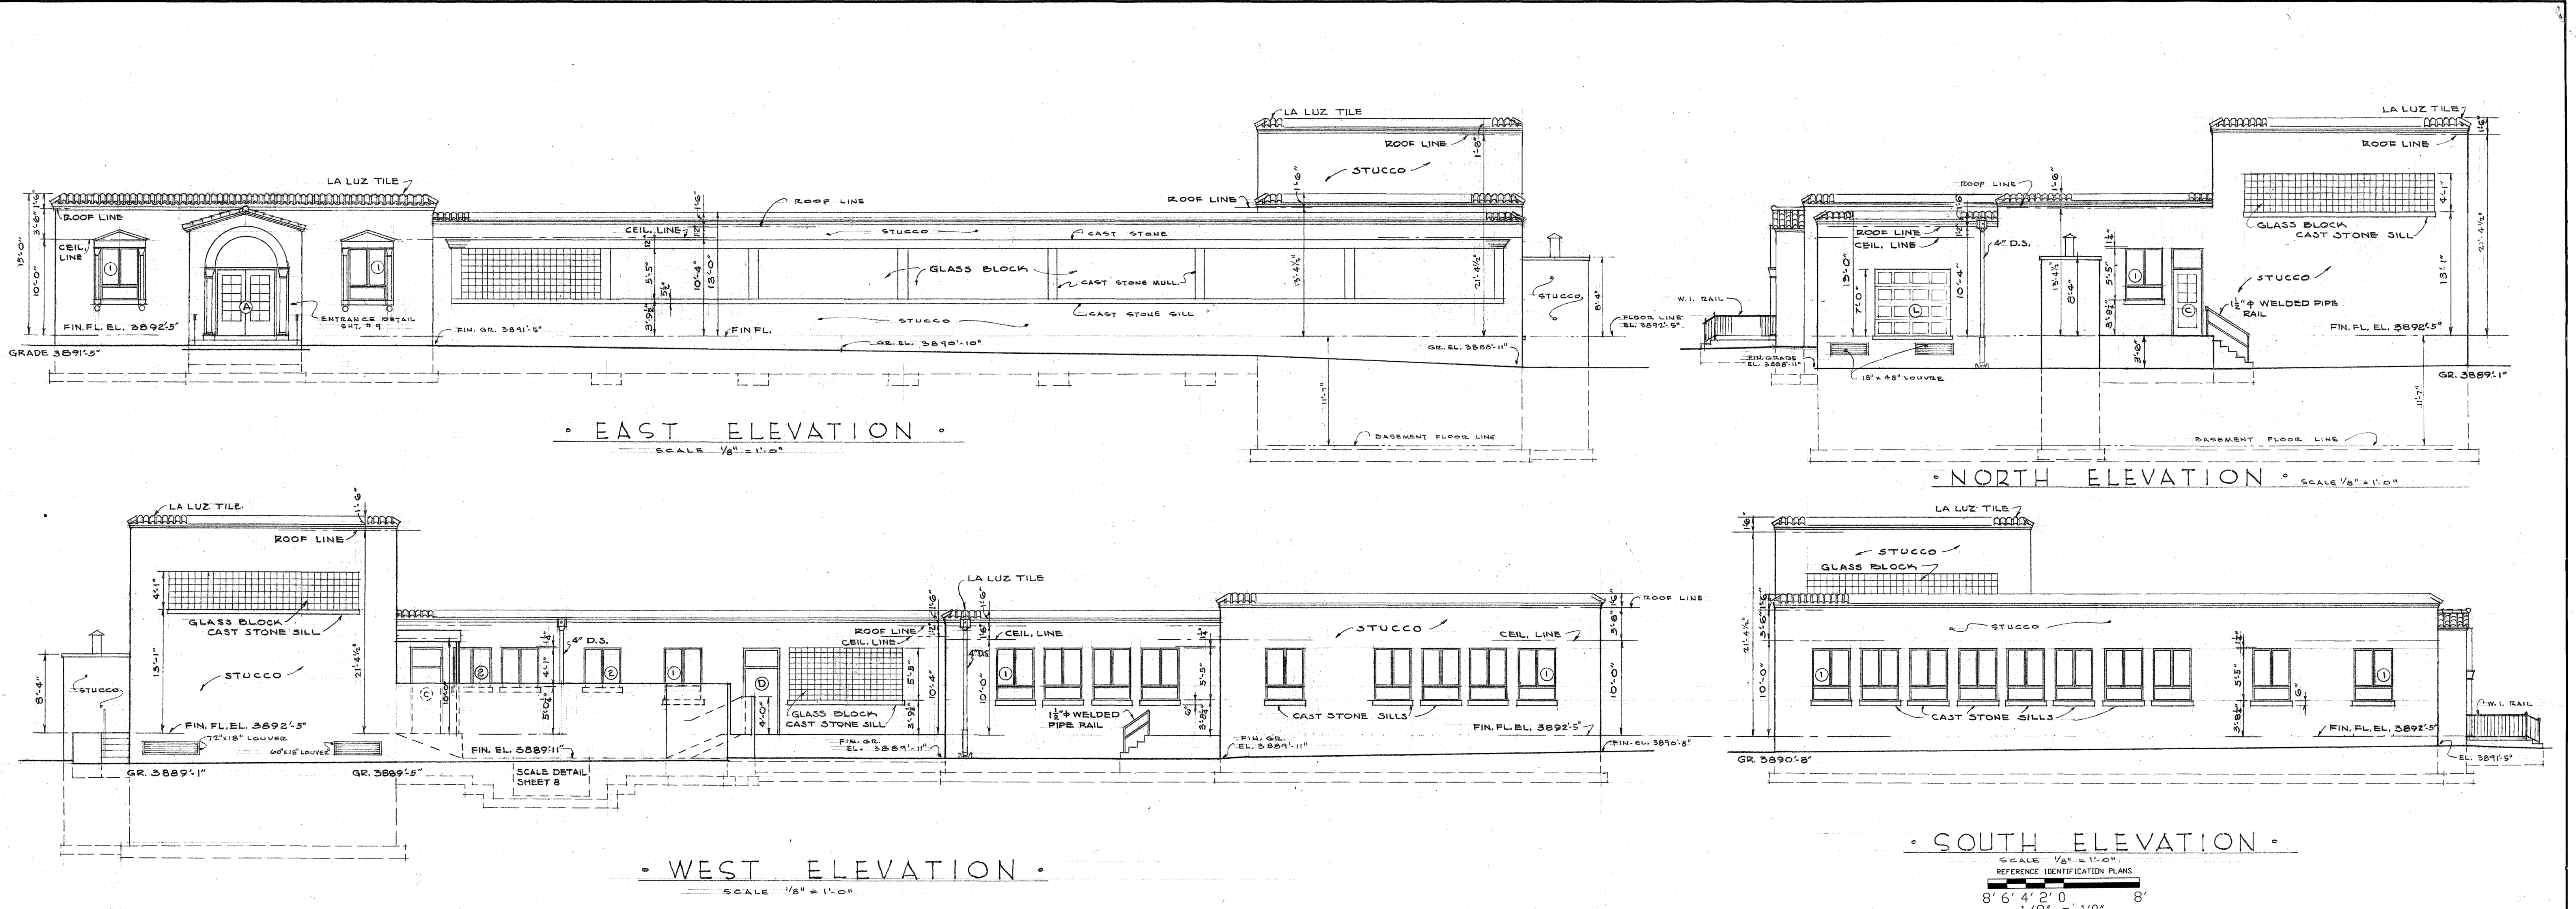
|  |   |   |
|--|---|---|
|  | AGRICULTURAL SCIENCE BUILDING   | JOB NO. 277                             |
|  | FOR NEW MEXICO COLLEGE OF AGRICULTURE & MECHANIC ARTS STATE COLLEGE, NEW MEXICO | DATE DEC. 19, 1950                      |
| <b>SCHAEFER &amp; MERRELL</b><br>ARCHITECTS<br>CLOVIS NEW MEXICO |   | REVISIONS                               |
|  |   | DRAWN BY: Author<br>CHECKED BY: Checker |
|  |   | SHEET NO. 6<br>W.C.H. 6<br>P.L.L. 9     |



**AG MOD PHASE 3: NEALE HALL DEMO**

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 Las Cruces, NM 88001

MARCH 12, 2024

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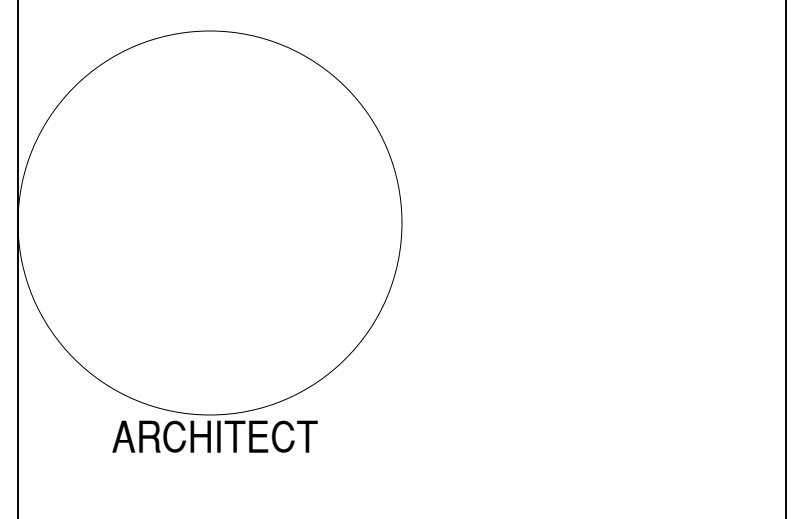
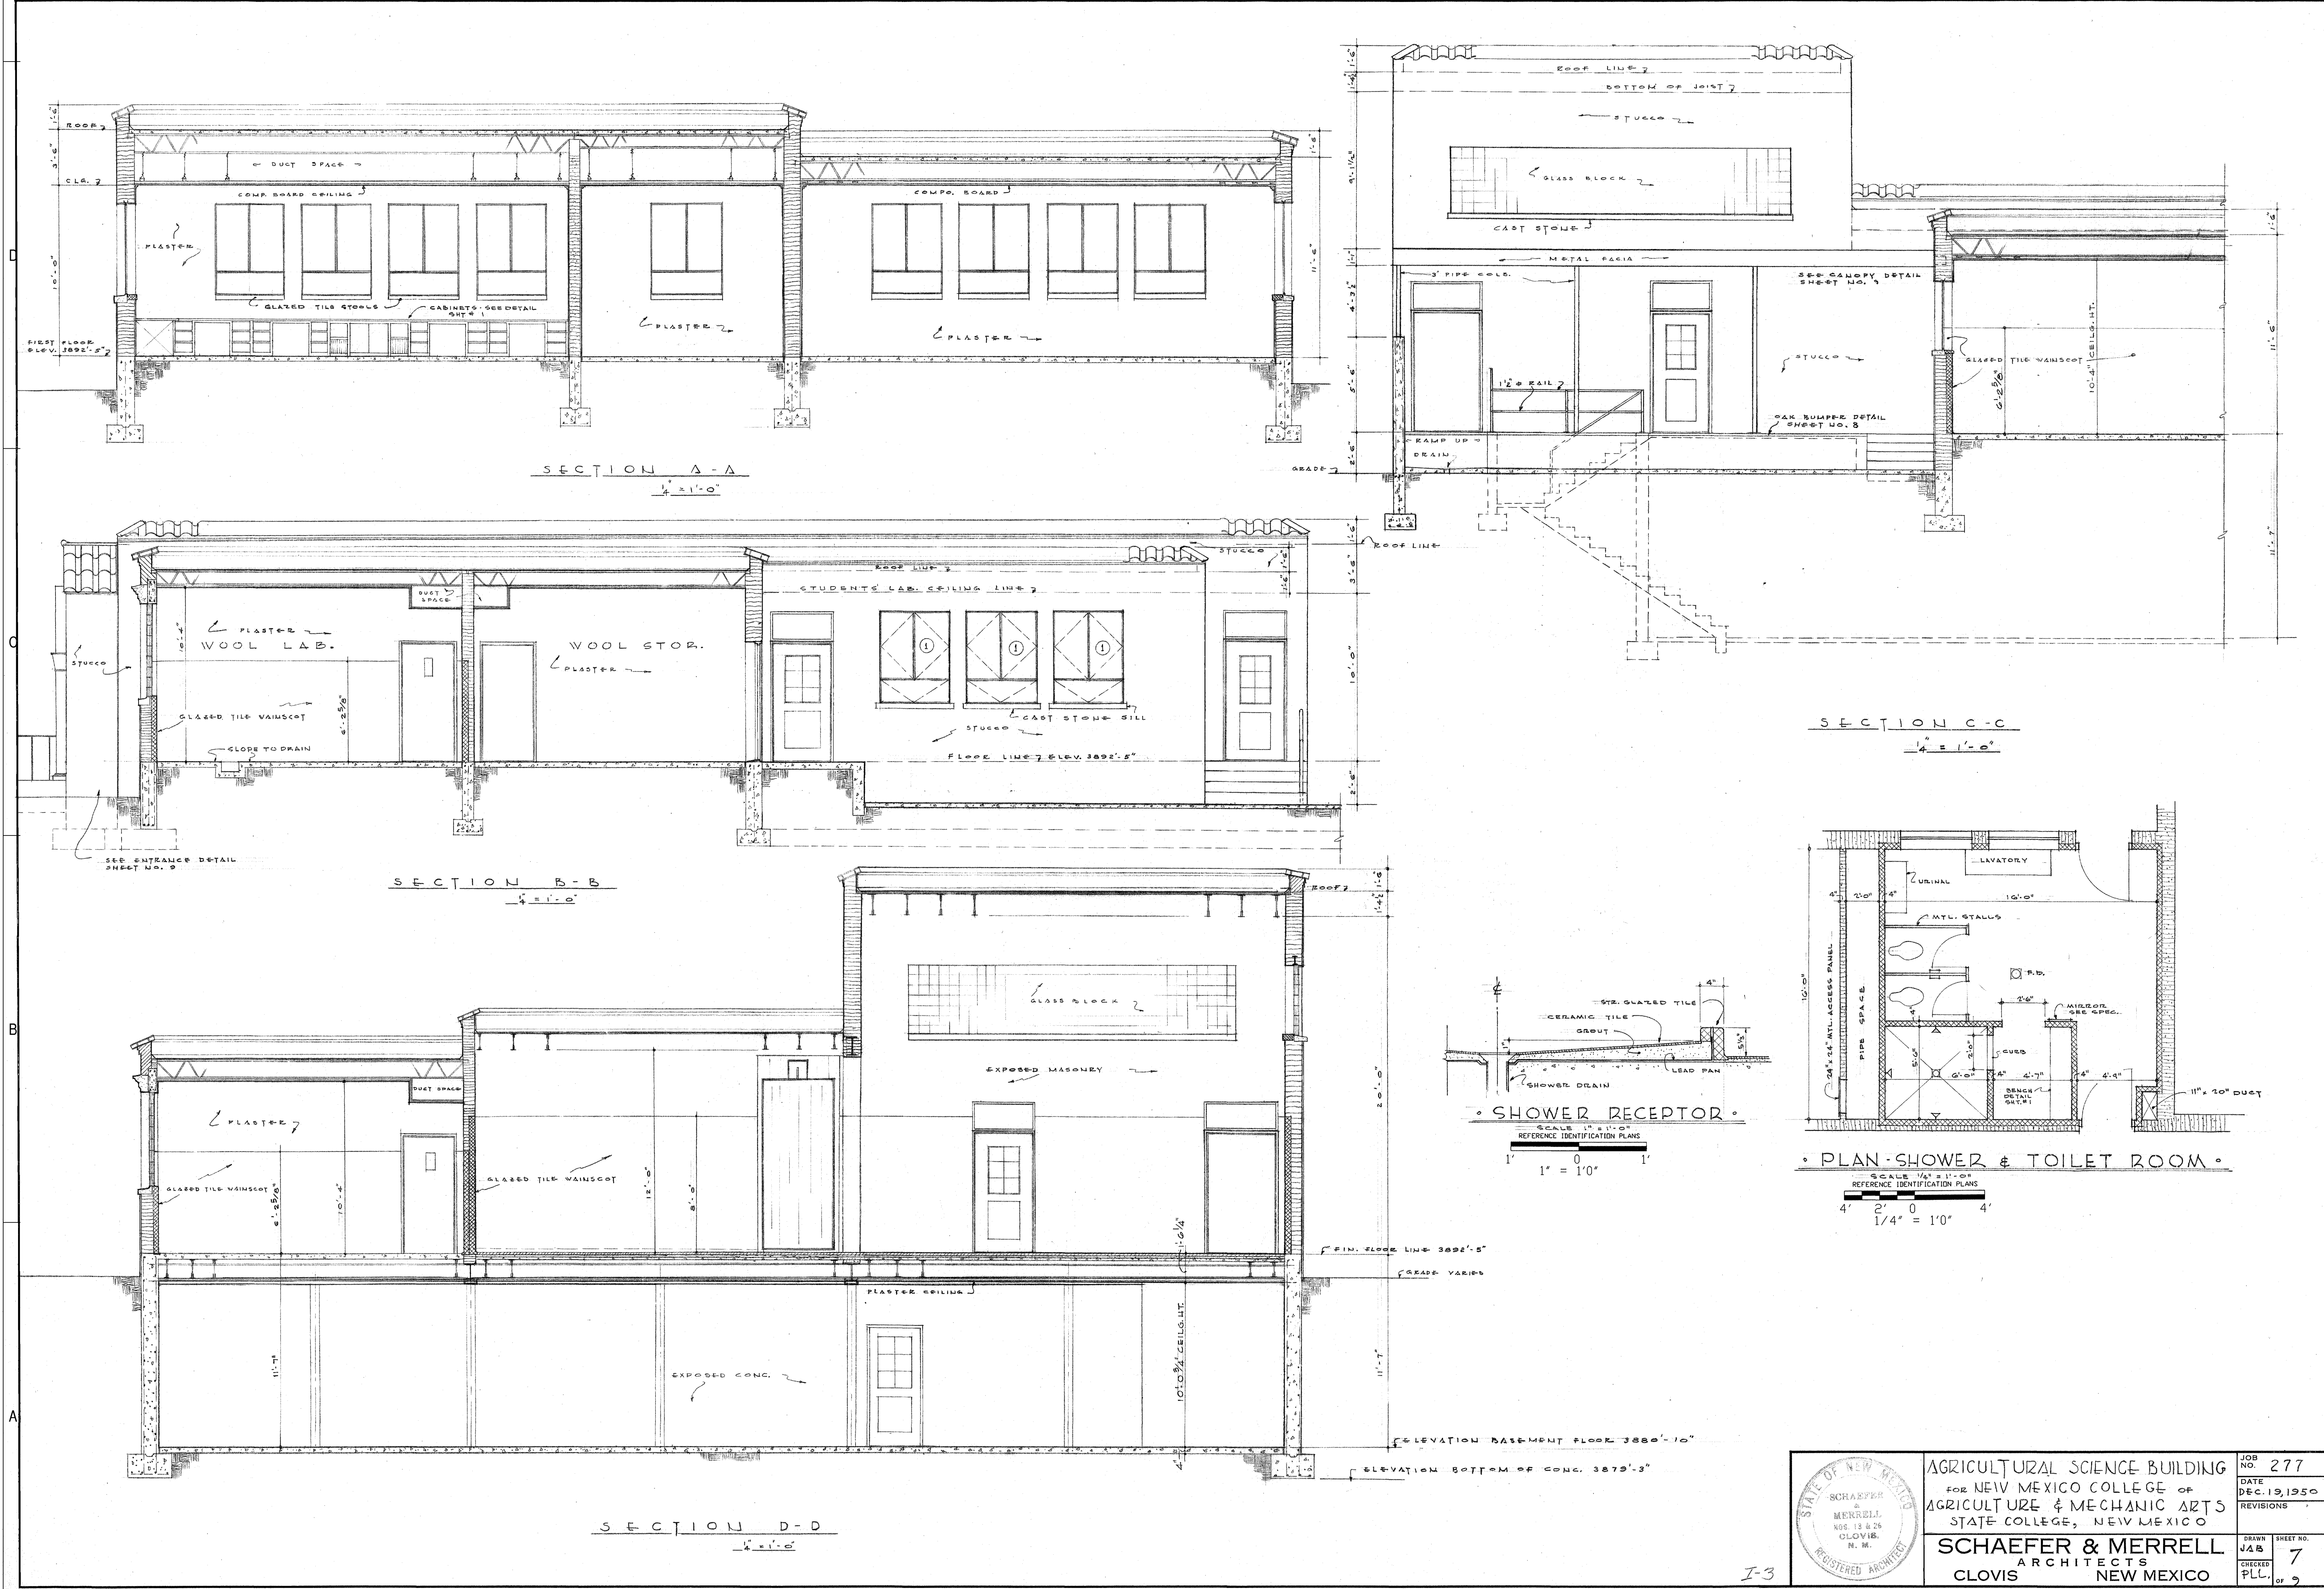
**AE-105**

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**AG MOD PHASE 3: NEALE HALL DEMO**

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STATE OF NEW MEXICO  
REGISTERED ARCHITECT

SCHAEFER & MERRELL  
ARCHITECTS  
CLOVIS, NEW MEXICO

AGRICULTURAL SCIENCE BUILDING  
FOR NEW MEXICO COLLEGE OF  
AGRICULTURE & MECHANIC ARTS  
STATE COLLEGE, NEW MEXICO

JOB NO. 277  
DATE DEC. 13, 1950  
REVISIONS

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CHECKED PLL  
SHEET NO. 7  
OF 9





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**AG MOD PHASE 3: NEALE HALL DEMO**

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 EXISTING PLANS

AGRICULTURAL SCIENCE BUILDING  
 FOR NEW MEXICO COLLEGE OF AGRICULTURE & MECHANIC ARTS  
 STATE COLLEGE, NEW MEXICO

**SCHAEFER & MERRELL**  
 ARCHITECTS  
 CLOVIS NEW MEXICO

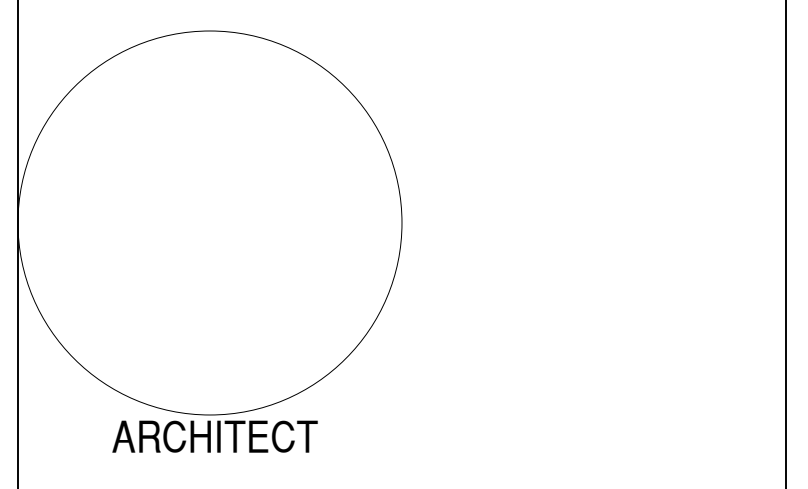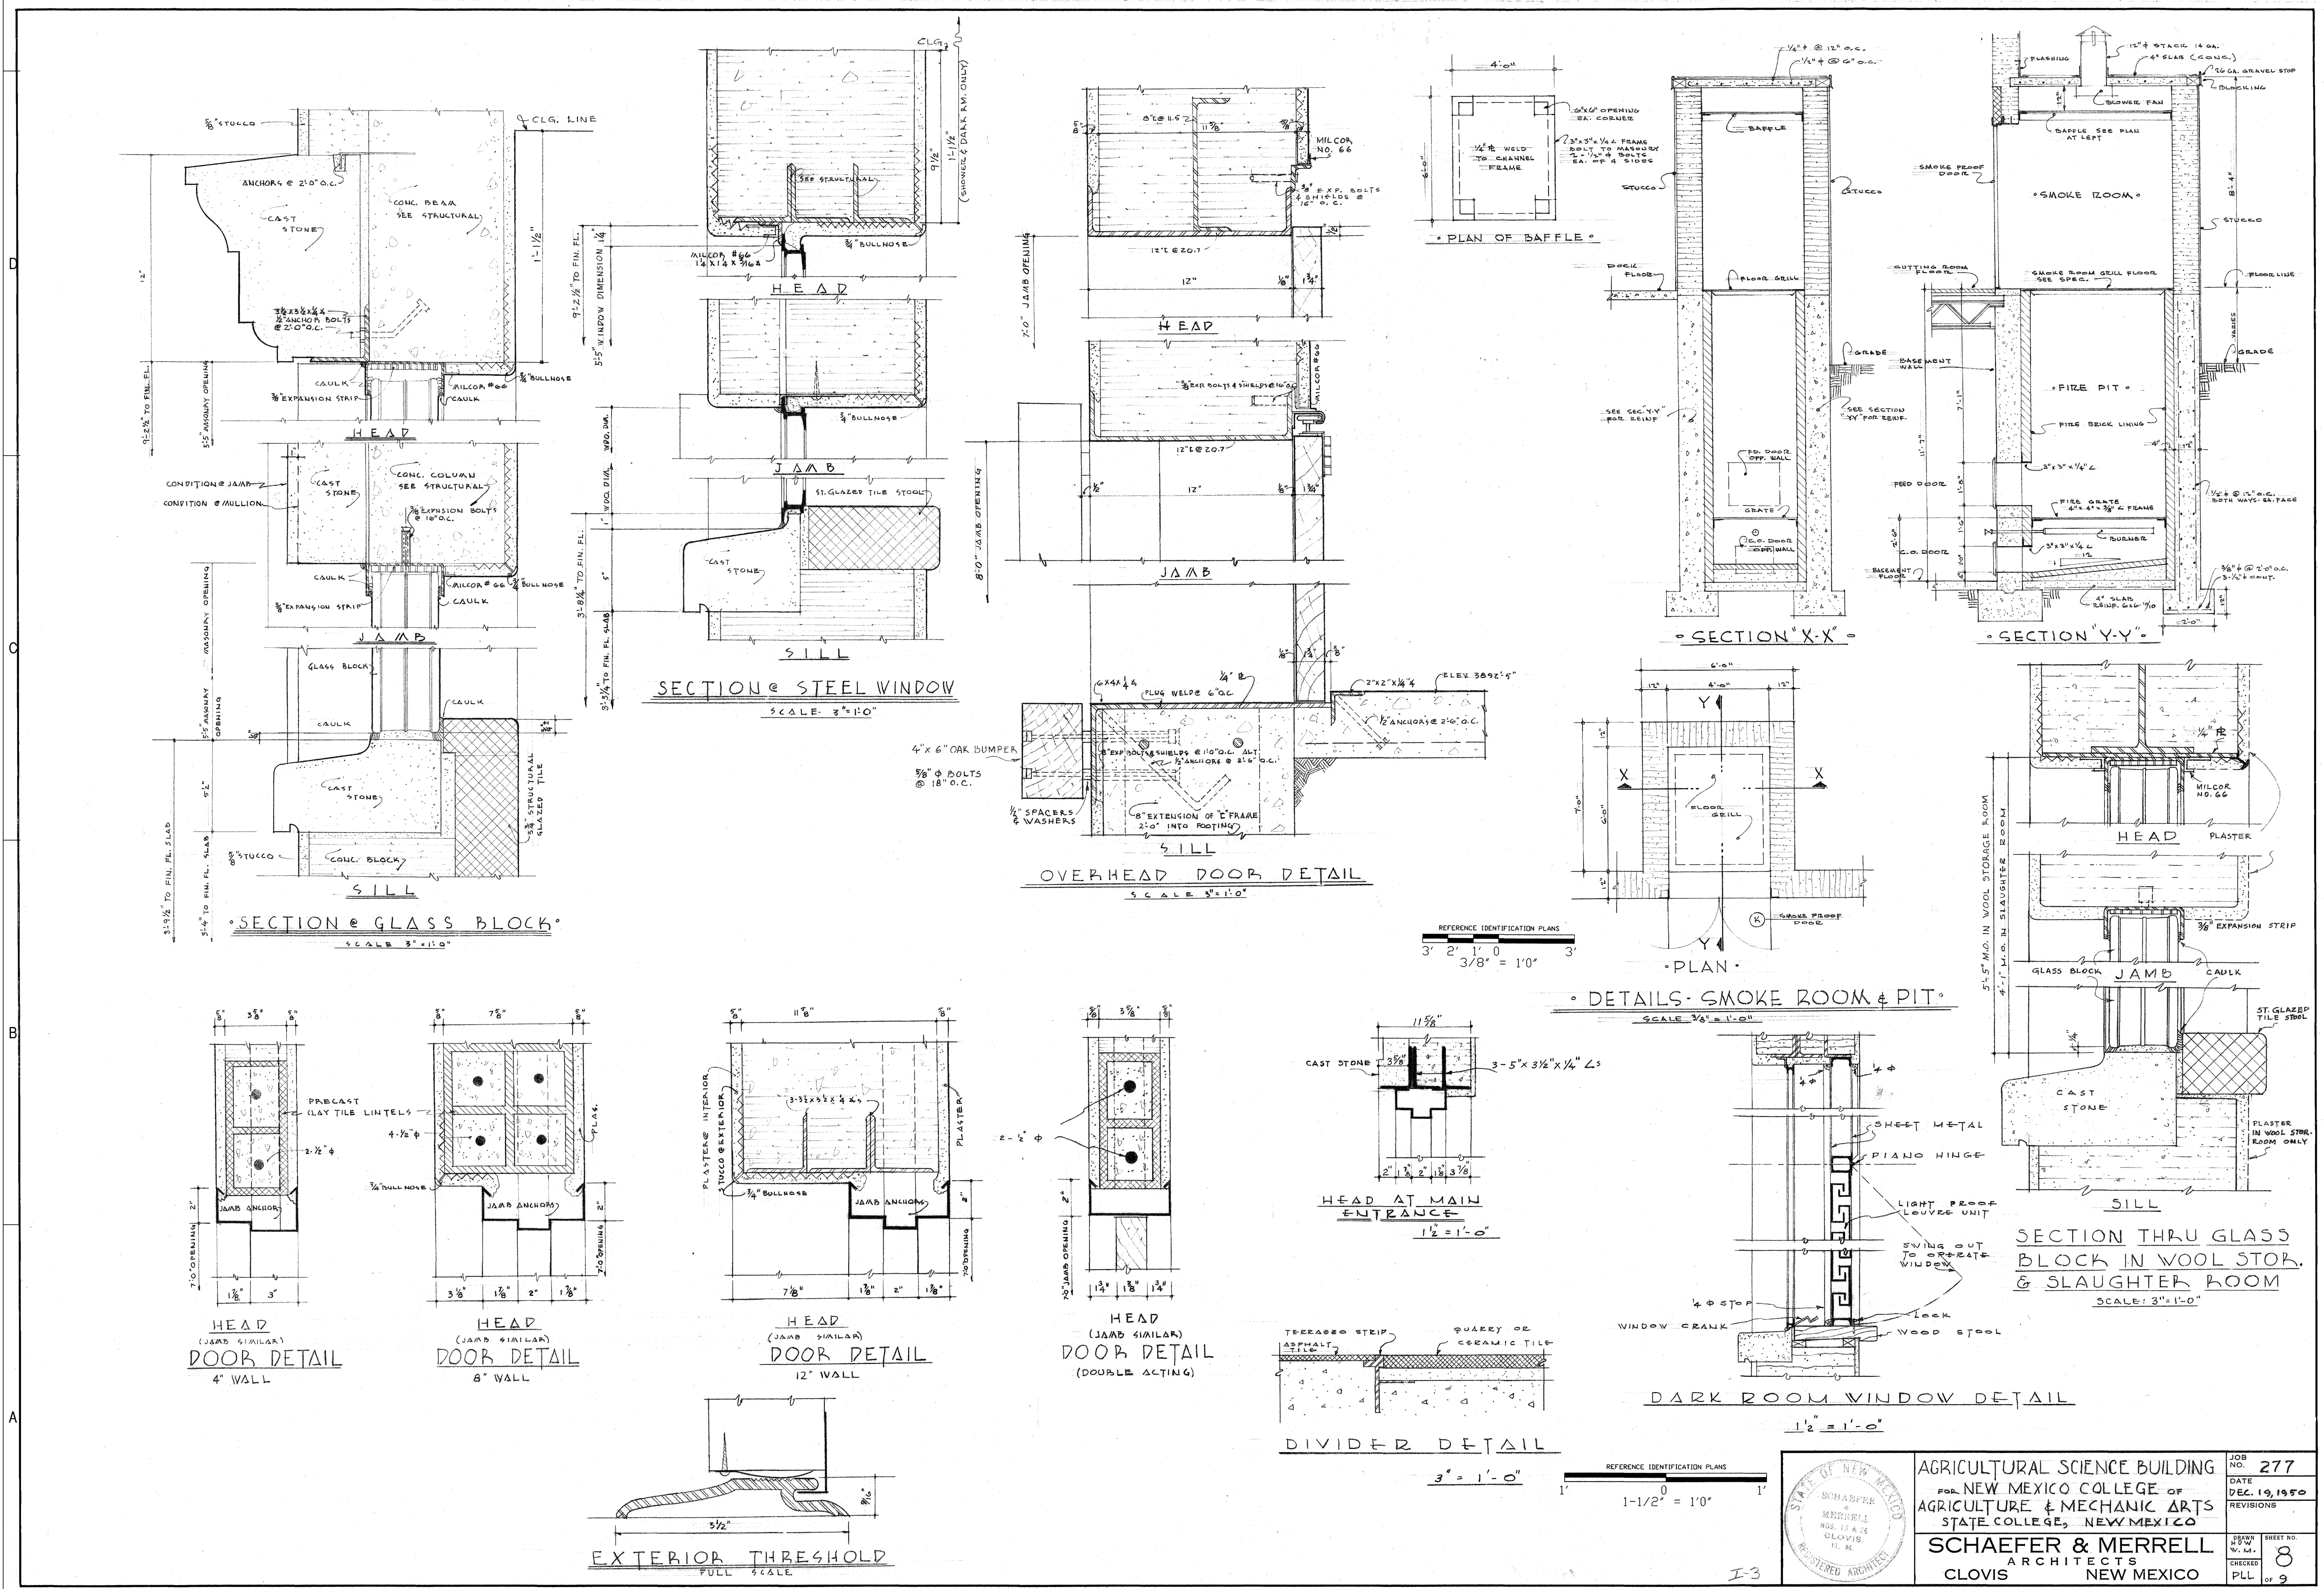JOB NO. 277  
 DATE DEC. 19, 1950  
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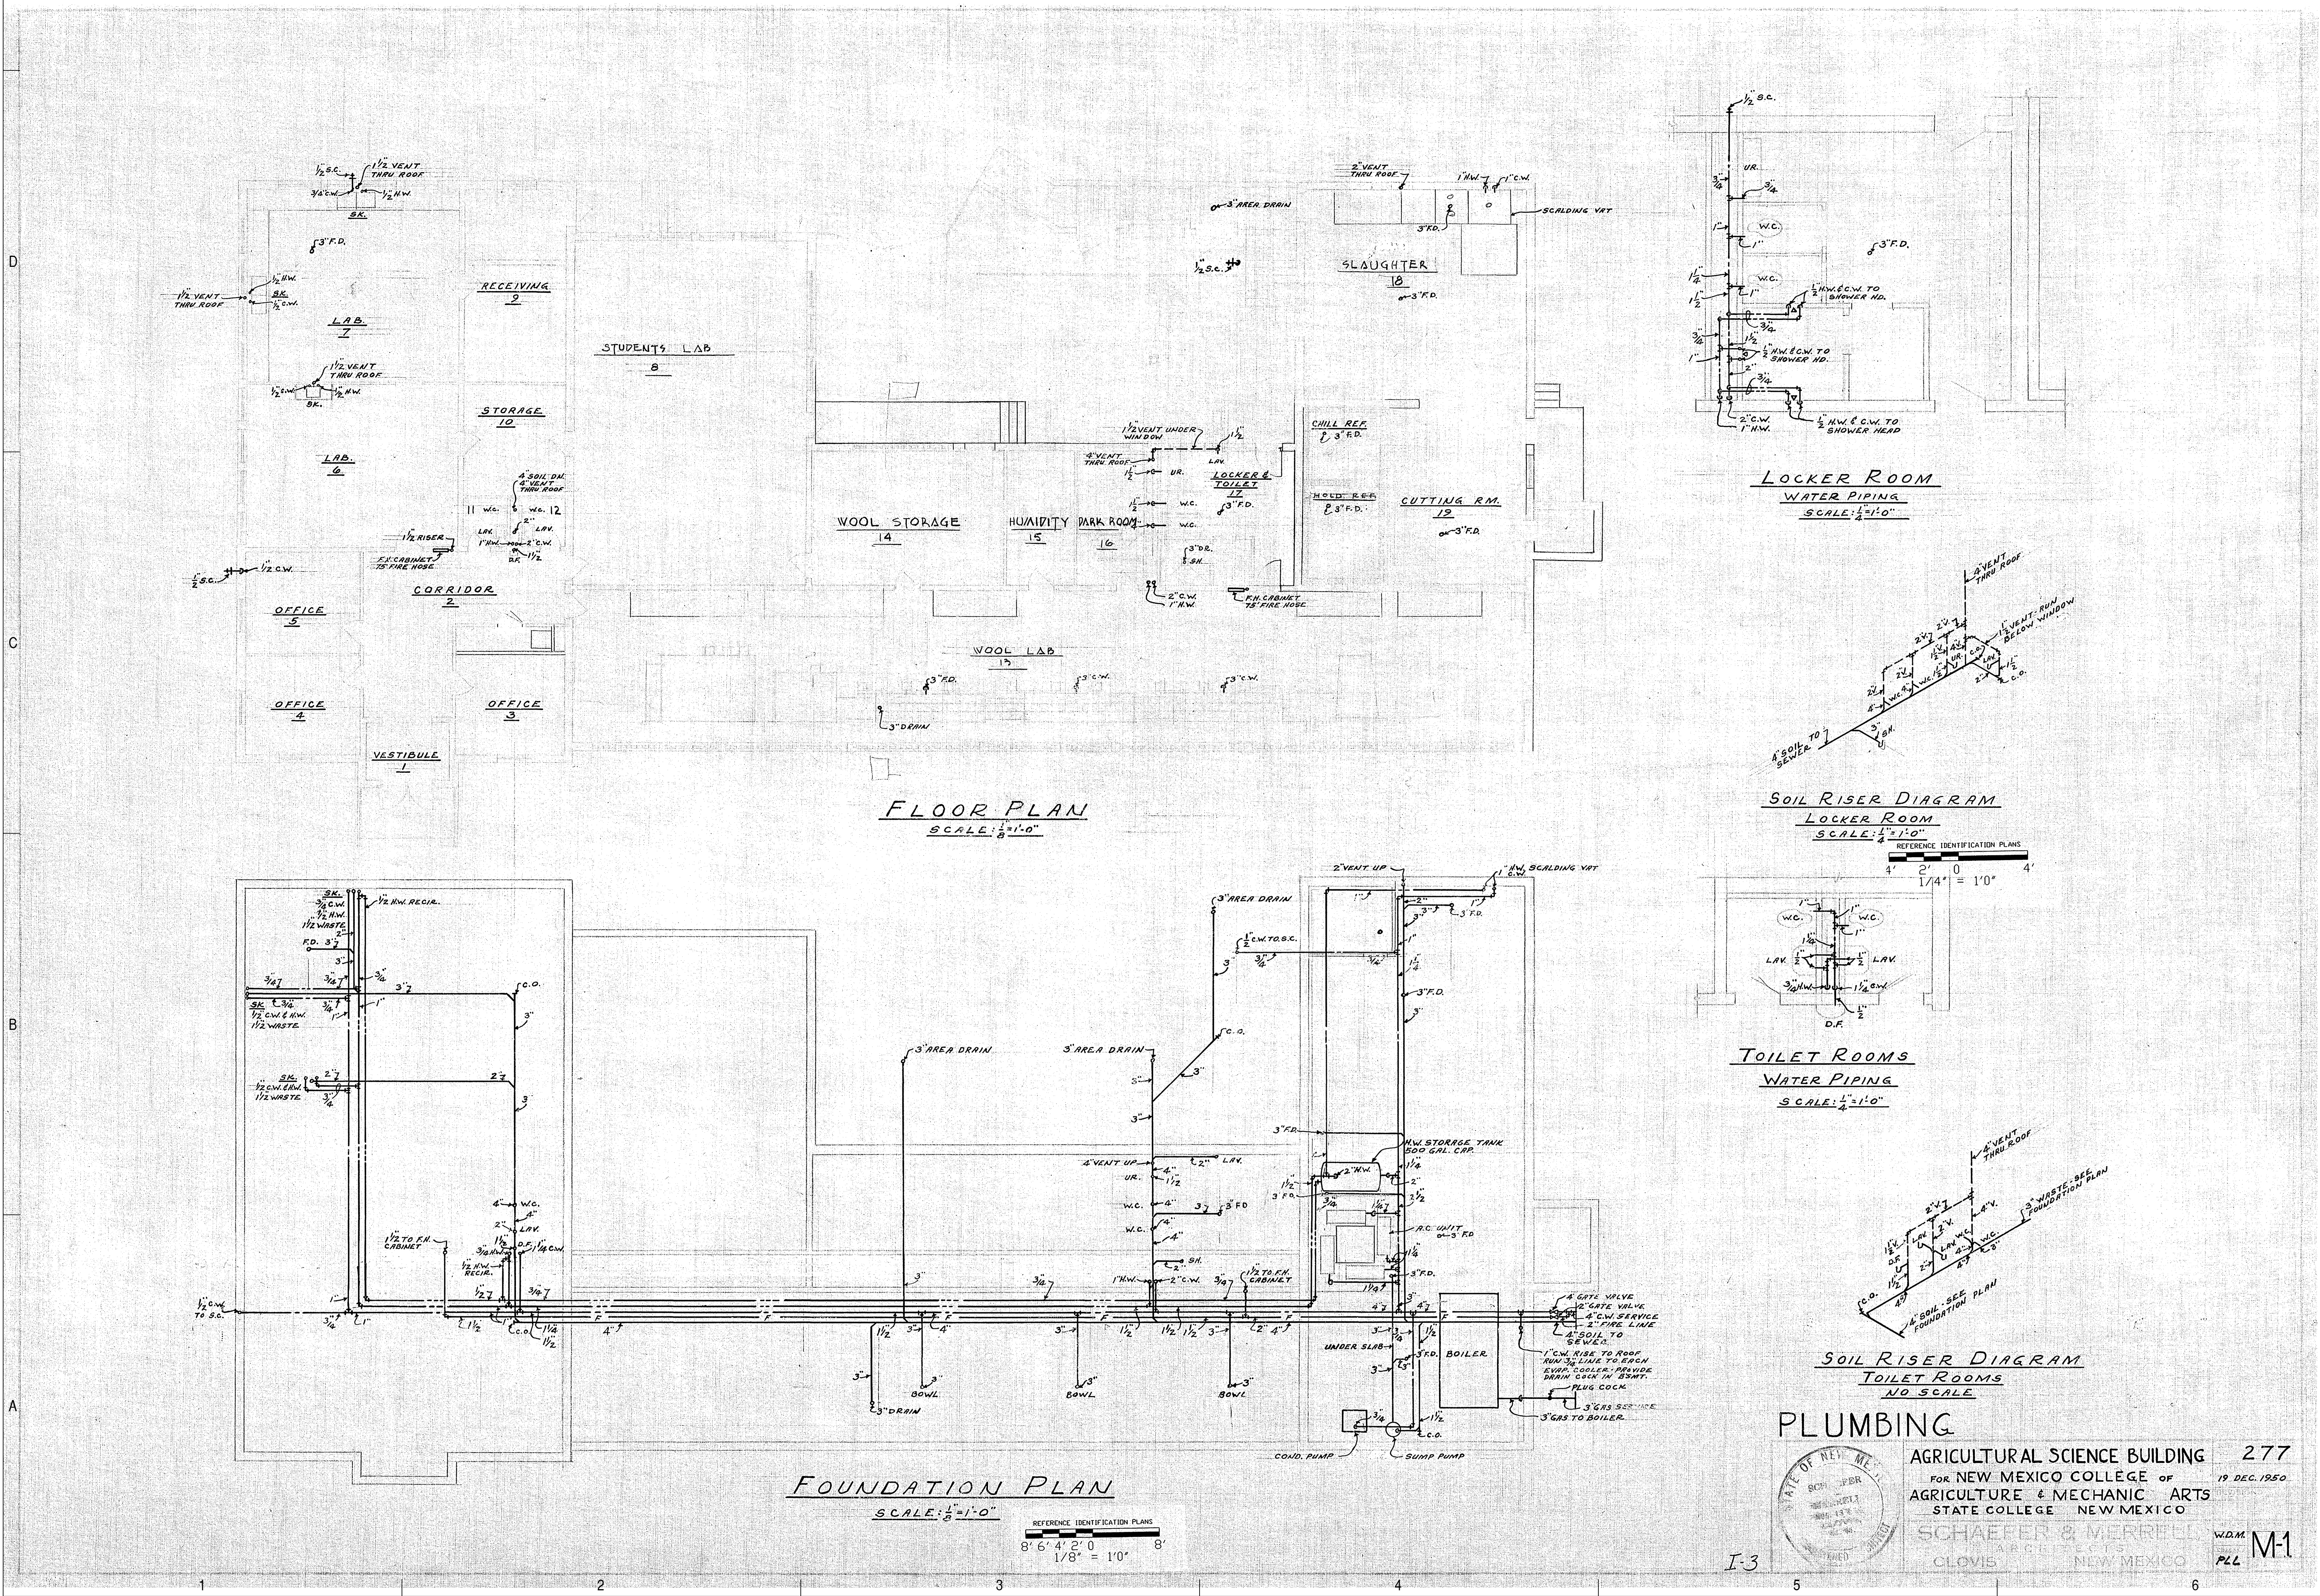
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**FLOOR PLAN**  
 SCALE: 1/8" = 1'-0"

**LOCKER ROOM**  
 WATER PIPING  
 SCALE: 1/4" = 1'-0"

**SOIL RISER DIAGRAM**  
 LOCKER ROOM  
 SCALE: 1/4" = 1'-0"

**TOILET ROOMS**  
 WATER PIPING  
 SCALE: 1/4" = 1'-0"

**SOIL RISER DIAGRAM**  
 TOILET ROOMS  
 NO SCALE



**FOUNDATION PLAN**  
 SCALE: 1/8" = 1'-0"

**PLUMBING**

AGRICULTURAL SCIENCE BUILDING 277  
 FOR NEW MEXICO COLLEGE OF AGRICULTURE & MECHANIC ARTS STATE COLLEGE NEW MEXICO  
 19 DEC 1950

SCHAFFER & MERRILL ARCHITECTS CLOVIS NEW MEXICO

W.A.M. M-1 P.L.L.

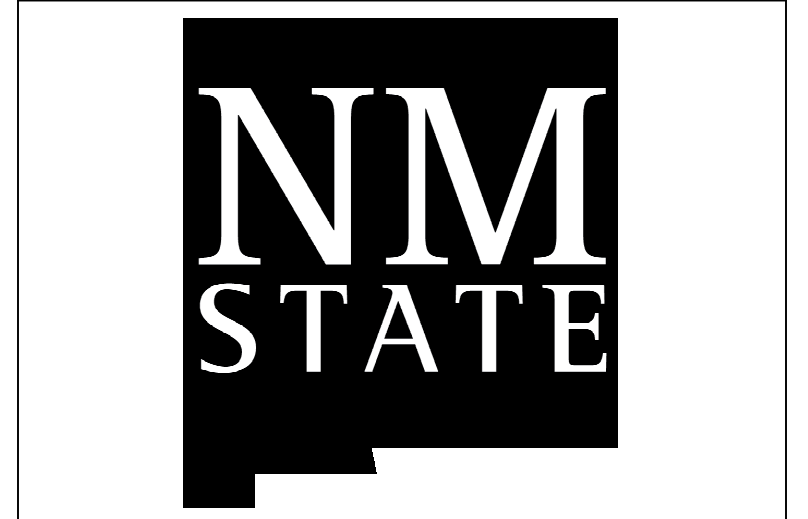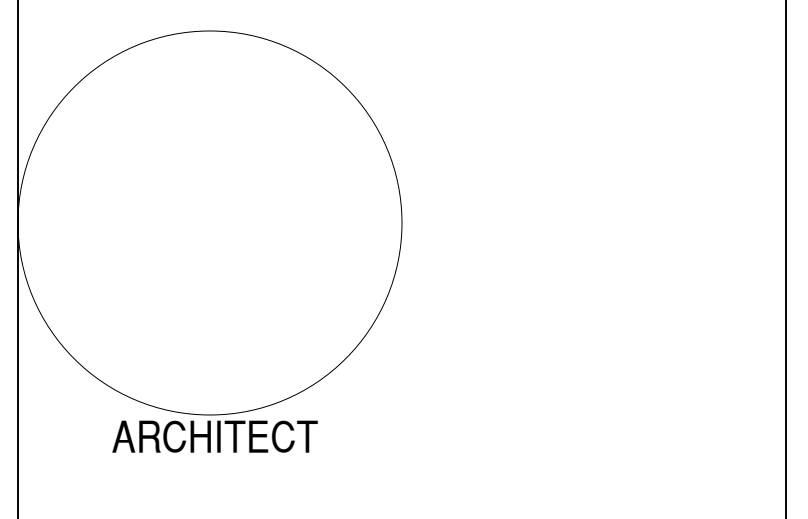

**AG MOD PHASE 3: NEALE HALL DEMO**

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3198 S. Espina St  
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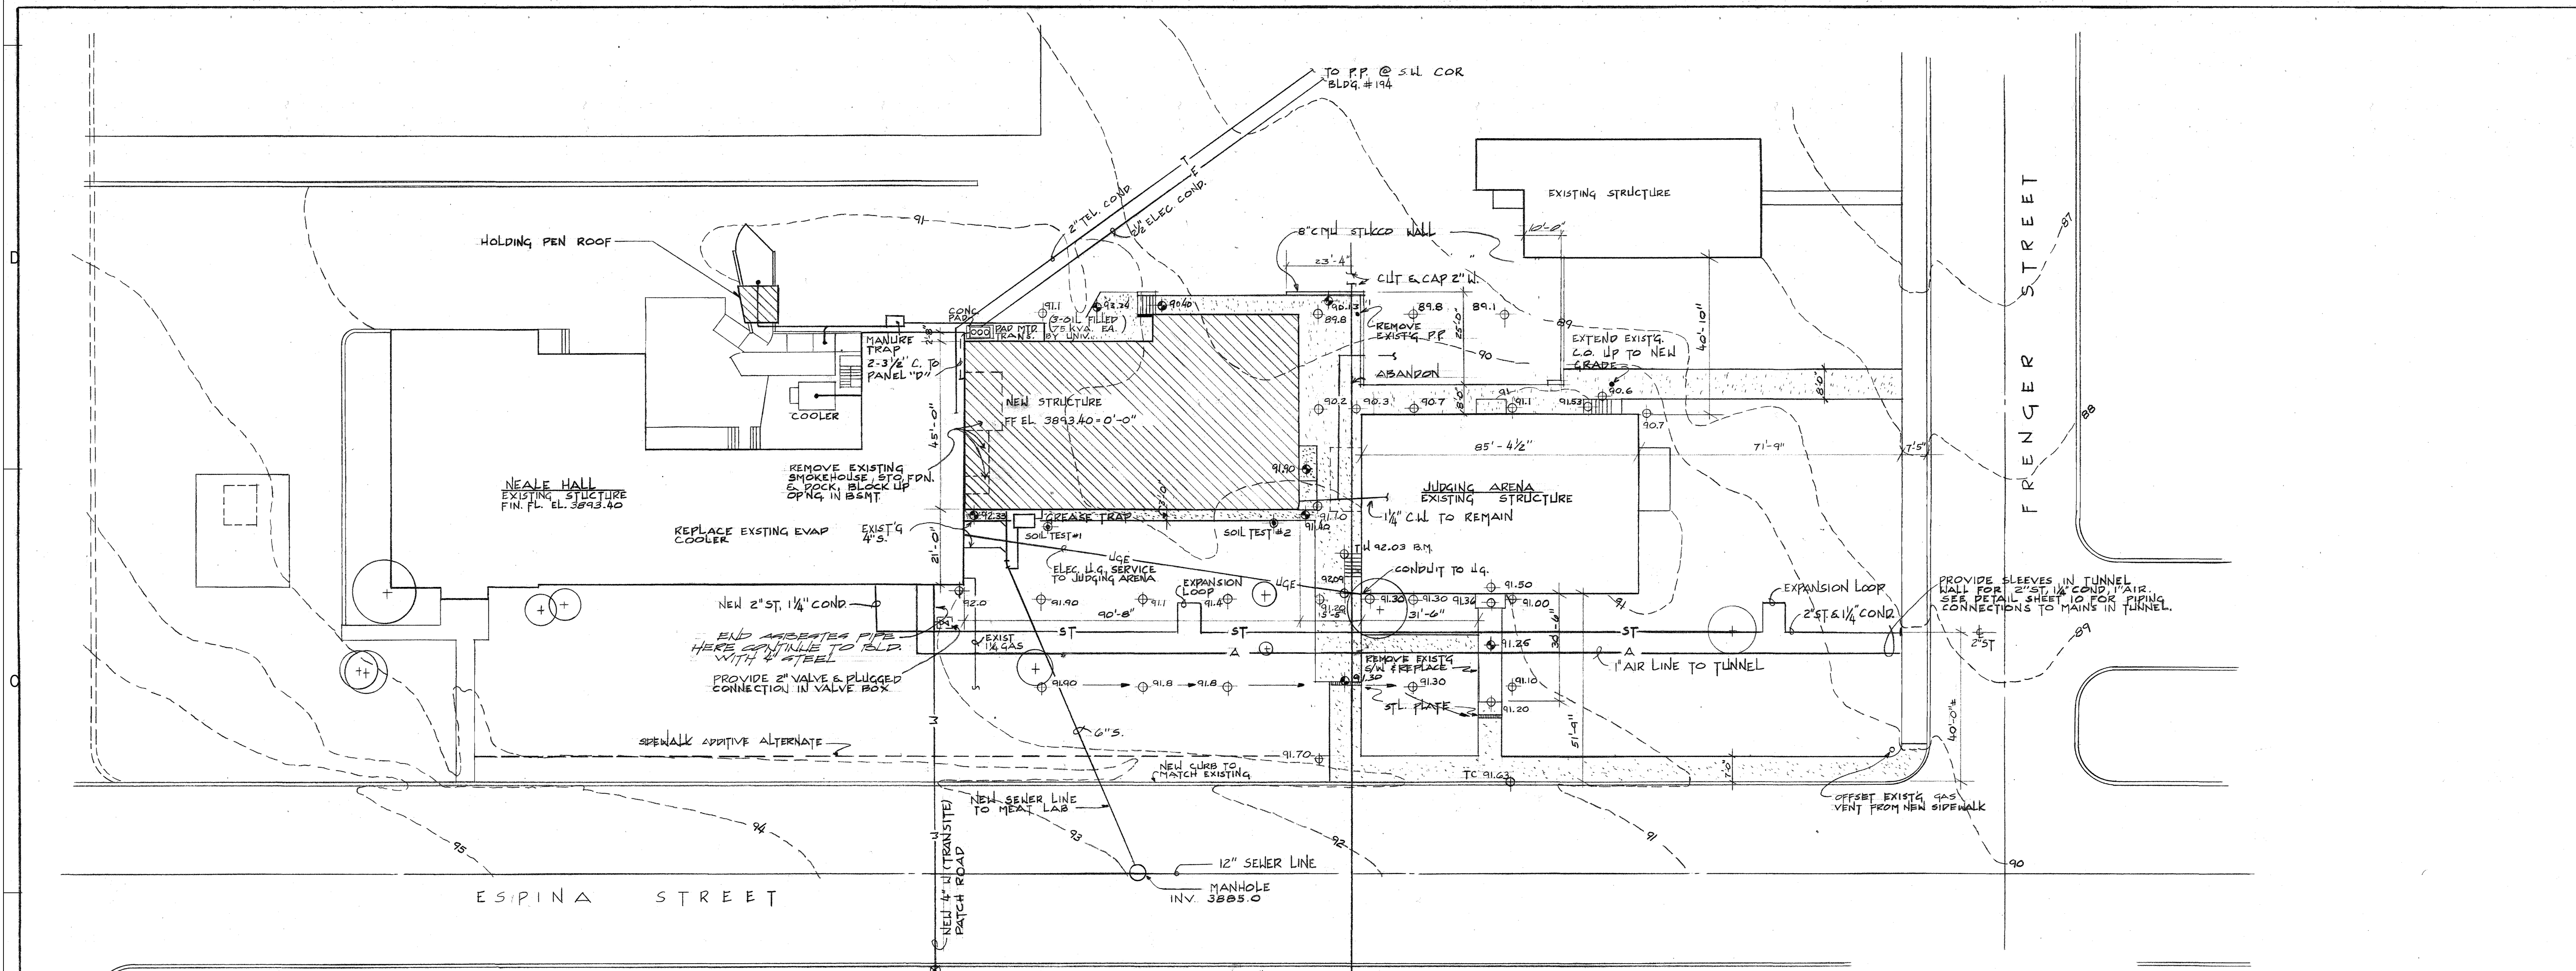
**AE-108**

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**SITE PLAN LEGEND**

- EXISTING CONTOUR
- ⊕ EXISTING ELEVATION
- ⊕ EXISTING TREES TO BE SAVED
- ▭ EXISTING STRUCTURE
- ▨ NEW CONSTRUCTION
- DRAINAGE DEPRESSION

**MATERIAL LEGEND**

CONCRETE

**SITE PLAN**  
 1" = 20'-0"

**SECTION MARK**

NUMBER OF DETAIL OR WALL SECTION

(1)

SHEET ON WHICH DETAIL OR SECTION IS LOCATED

**NOTES:**


1. PROTECT & SAVE ALL EXISTING SHRUBS & TREES.
2. CONTRACTOR SHALL MAINTAIN ALL UTILITY SERVICE TO EXISTING BLDGS DURING CONSTRUCTION.
3. EXISTING POWER POLE SHALL REMAIN UNTIL NEW SERVICE IS CONNECTED.
4. THE CONTRACTOR SHALL VERIFY ALL DIMENSIONS IN THE FIELD.

- 1 SITE PLAN
- 2 FOUNDATION PLAN
- 3 FLOOR PLAN
- 4 EQUIPMENT FLOOR PLAN
- 5 EQUIPMENT FLOOR PLAN (NEW STRUCTURE)
- 6 EXTERIOR ELEVATION
- 7 BUILDING SECTIONS
- 8 REGULATED SOLIDS PLAN
- 9 ELECTRICAL LIGHTING PLAN
- 10 ELECTRICAL POWER PLAN
- 11 GAS SUPPLY PLAN & ISOMETRIC
- 12 MANURE TRAP & RELEASE TRAP DETAILS
- 13 HEATING & AIR CONDITIONING PLAN
- 14 REFRIGERATION PLAN

# NEALE HALL ADDITION

## NEW MEXICO STATE UNIVERSITY

### UNIVERSITY PARK, NEW MEXICO

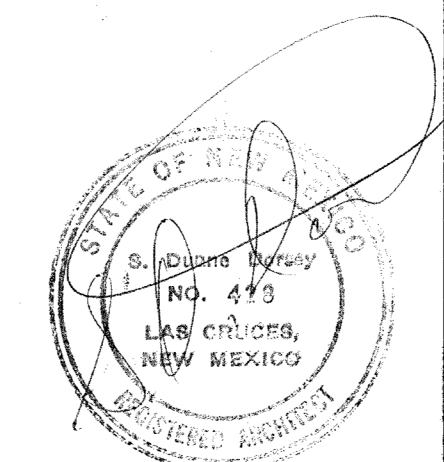

|   |   |   |
|---|---|---|
| SHEET<br>1<br>OF<br>14<br>SCALE<br>AS SHOWN | PROJECT NO. 100505  | DRAWN OSL<br>CHKD D.D.<br>DATE: 4-25-22 |
|   | PHYSICAL PLANT DEPARTMENT<br>NEW MEXICO STATE UNIVERSITY<br>UNIVERSITY PARK, NEW MEXICO |   |
| NEALE HALL<br>ADDITION                      |   |   |

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|------|------|-------------|
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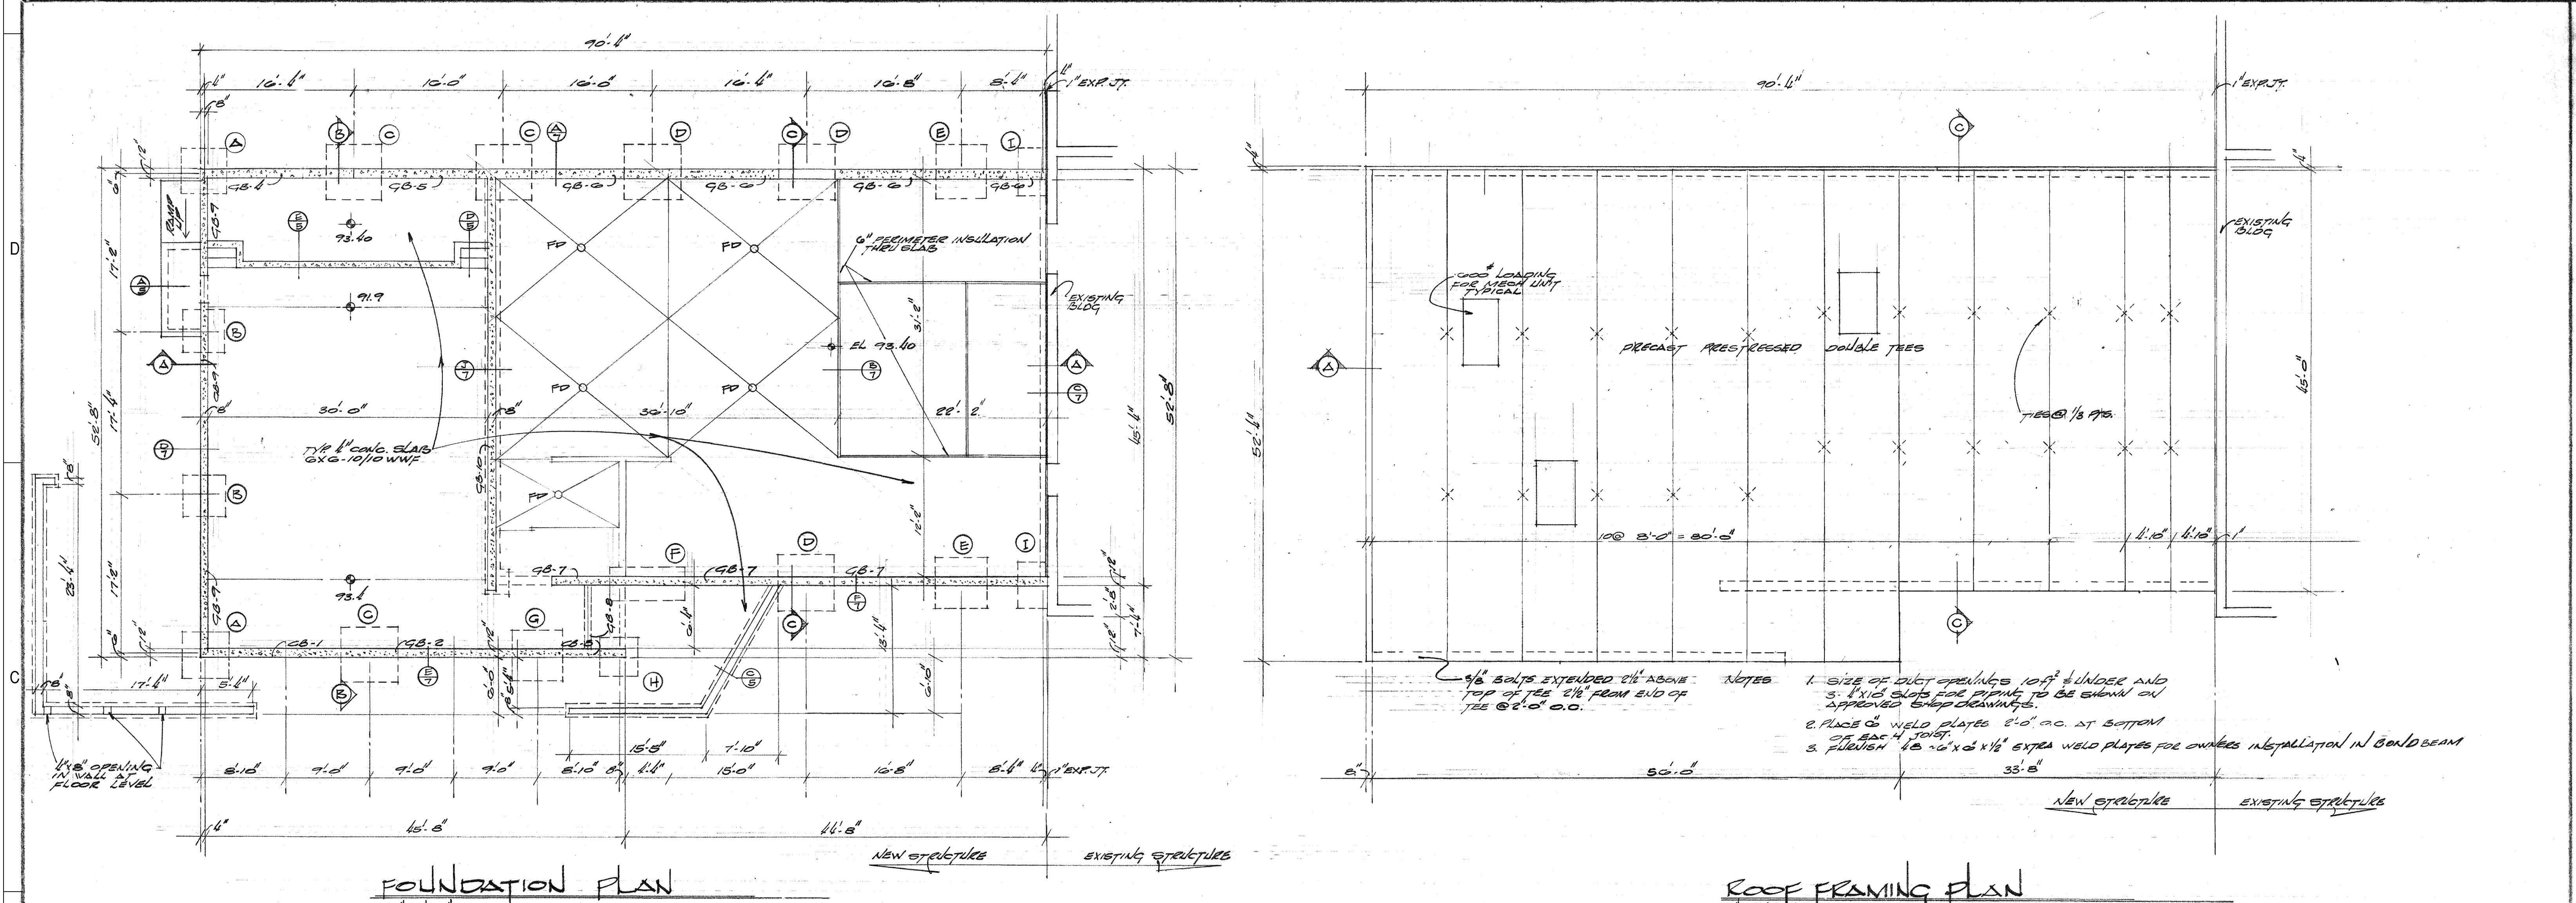
AE-109

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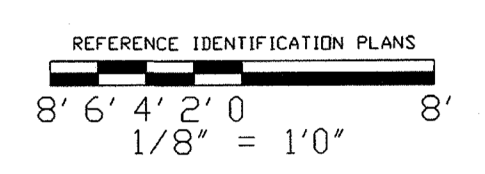
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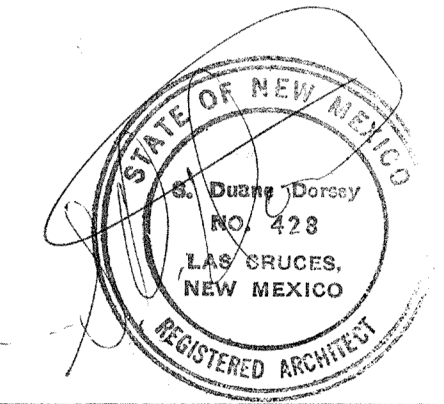
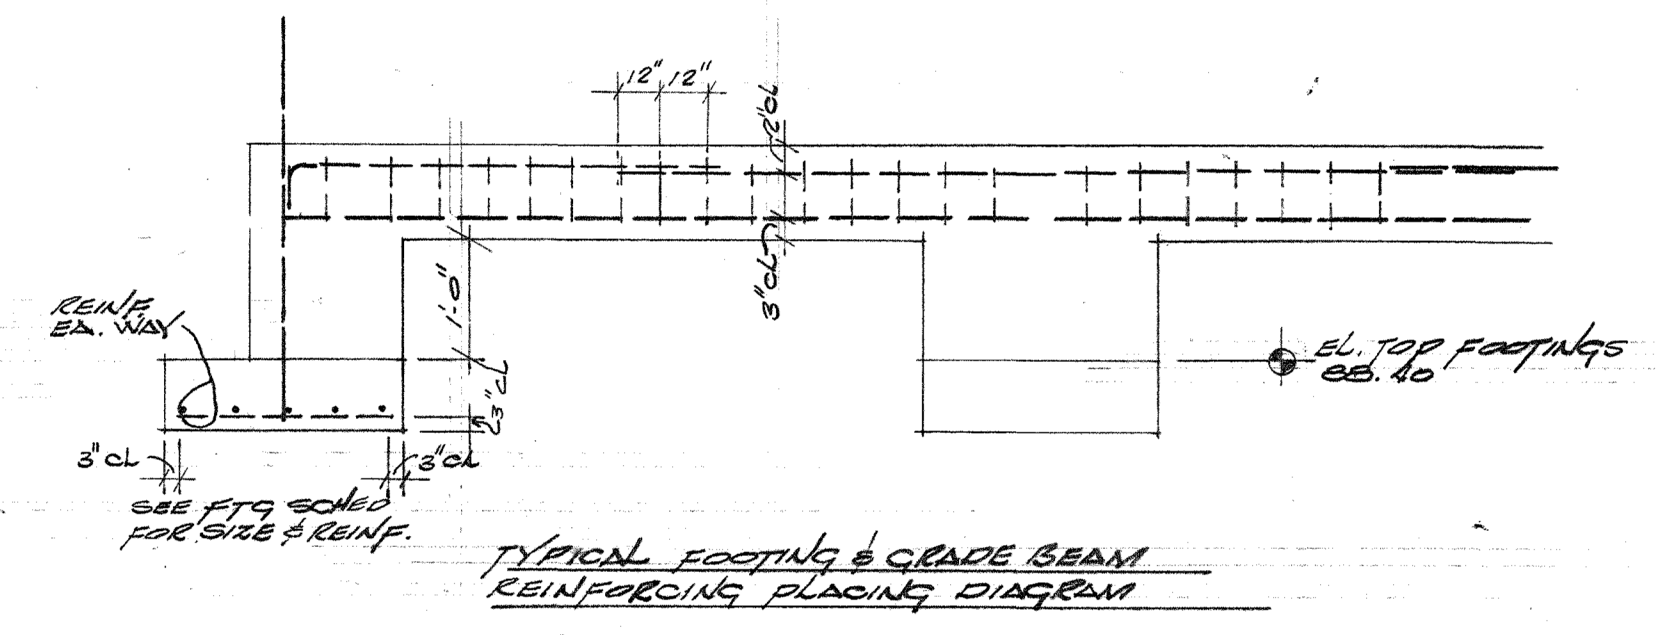


**FOUNDATION PLAN**  
 1/8" = 1'-0"

**ROOF FRAMING PLAN**  
 1/8" = 1'-0"



| FOOTINGS |                            | CONCRETE GRADE BEAMS |           |             |          | REMARKS     |  |
|----------|----------------------------|----------------------|-----------|-------------|----------|-------------|--|
| MARK     | FOOTING SIZE & REINF. E.W. | MARK                 | SIZE      | REINFORCING | STIRRUPS |             |  |
| (A)      | 5'-0" x 3'-0" x 1'-8"      | QB-1                 | 12' x 16" | 3-#4        | 2-#6     | #3@12" O.C. | SEE RECH. SECTIONS ON SHEET 773B FOR ACTUAL CONFIGURATION AND BALANCE OF BAR REINFORCING |
| (B)      | 4'-0" x 3'-0" x 1'-8"      | QB-2                 | 12' x 16" | 3-#4        | 2-#6     | #3@12" O.C. |  |
| (C)      | 4'-0" x 3'-0" x 1'-8"      | QB-3                 | 12' x 16" | 3-#4        | 2-#6     | #3@12" O.C. |  |
| (D)      | 4'-0" x 3'-0" x 1'-8"      | QB-4                 | 12' x 16" | 3-#4        | 2-#6     | #3@12" O.C. |  |
| (E)      | 5'-0" x 3'-0" x 1'-8"      | QB-5                 | 12' x 16" | 3-#4        | 2-#6     | #3@12" O.C. |  |
| (F)      | 4'-0" x 3'-0" x 1'-8"      | QB-6                 | 12' x 16" | 3-#4        | 2-#6     | #3@12" O.C. |  |
| (G)      | 5'-0" x 3'-0" x 1'-8"      | QB-7                 | 12' x 16" | 3-#4        | 2-#6     | #3@12" O.C. |  |
| (H)      | 4'-0" x 3'-0" x 1'-8"      | QB-8                 | 12' x 16" | 3-#4        | 2-#6     | #3@12" O.C. |  |
| (I)      | 4'-0" x 3'-0" x 1'-8"      | QB-9                 | 8' x 16"  | 2-#5        | 2-#5     | #3@12" O.C. |  |
| (K)      | NONE                       | QB-10                | 8' x 16"  | 2-#5        | 2-#5     | #3@12" O.C. |  |



SHEET 0 OF 14  
 SCALE AS SHOWN

PHYSICAL PLANT DEPARTMENT  
 NEW MEXICO STATE UNIVERSITY  
 UNIVERSITY PARK, NEW MEXICO

NEALE HALL ADDITION

DRAWN BY: J.W. CHD  
 C.H.D. D.D.  
 DATE: 4-25-72

| MARK | DATE | DESCRIPTION |
|------|------|-------------|
|      |      |             |

ISSUE:  
 DATE:  
 PROJECT NO: 773B  
 DRAWN BY: Author  
 CHECKED BY: Checker

SHEET TITLE  
 EXISTING PLANS




AE-110

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**AG MOD PHASE 3: NEALE HALL DEMO**

**95% CONSTRUCTION DOCUMENTS**

3198 S. Espina St  
Las Cruces, NM 88001

MARCH 12, 2024
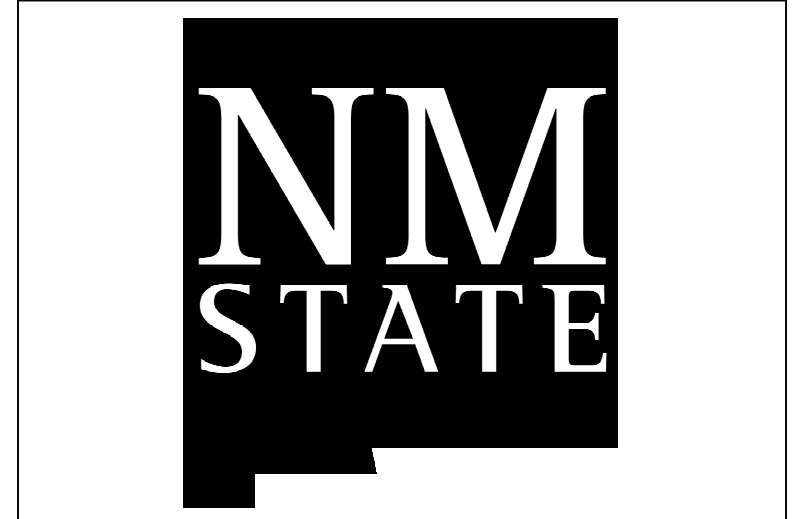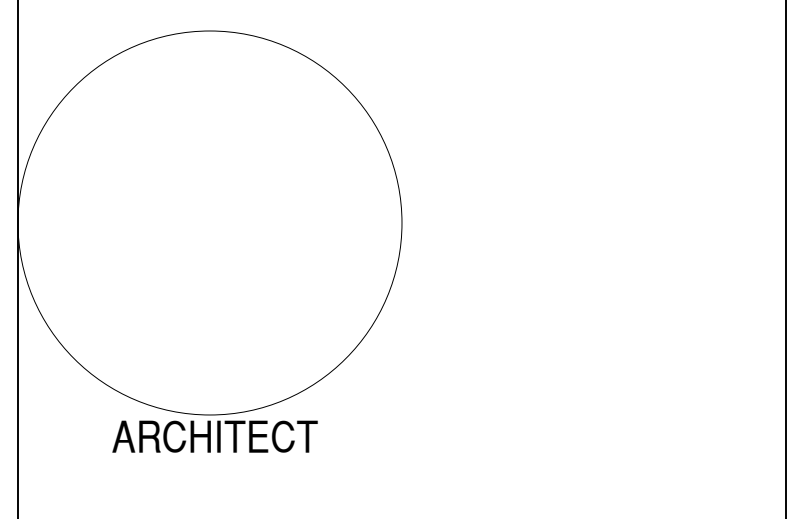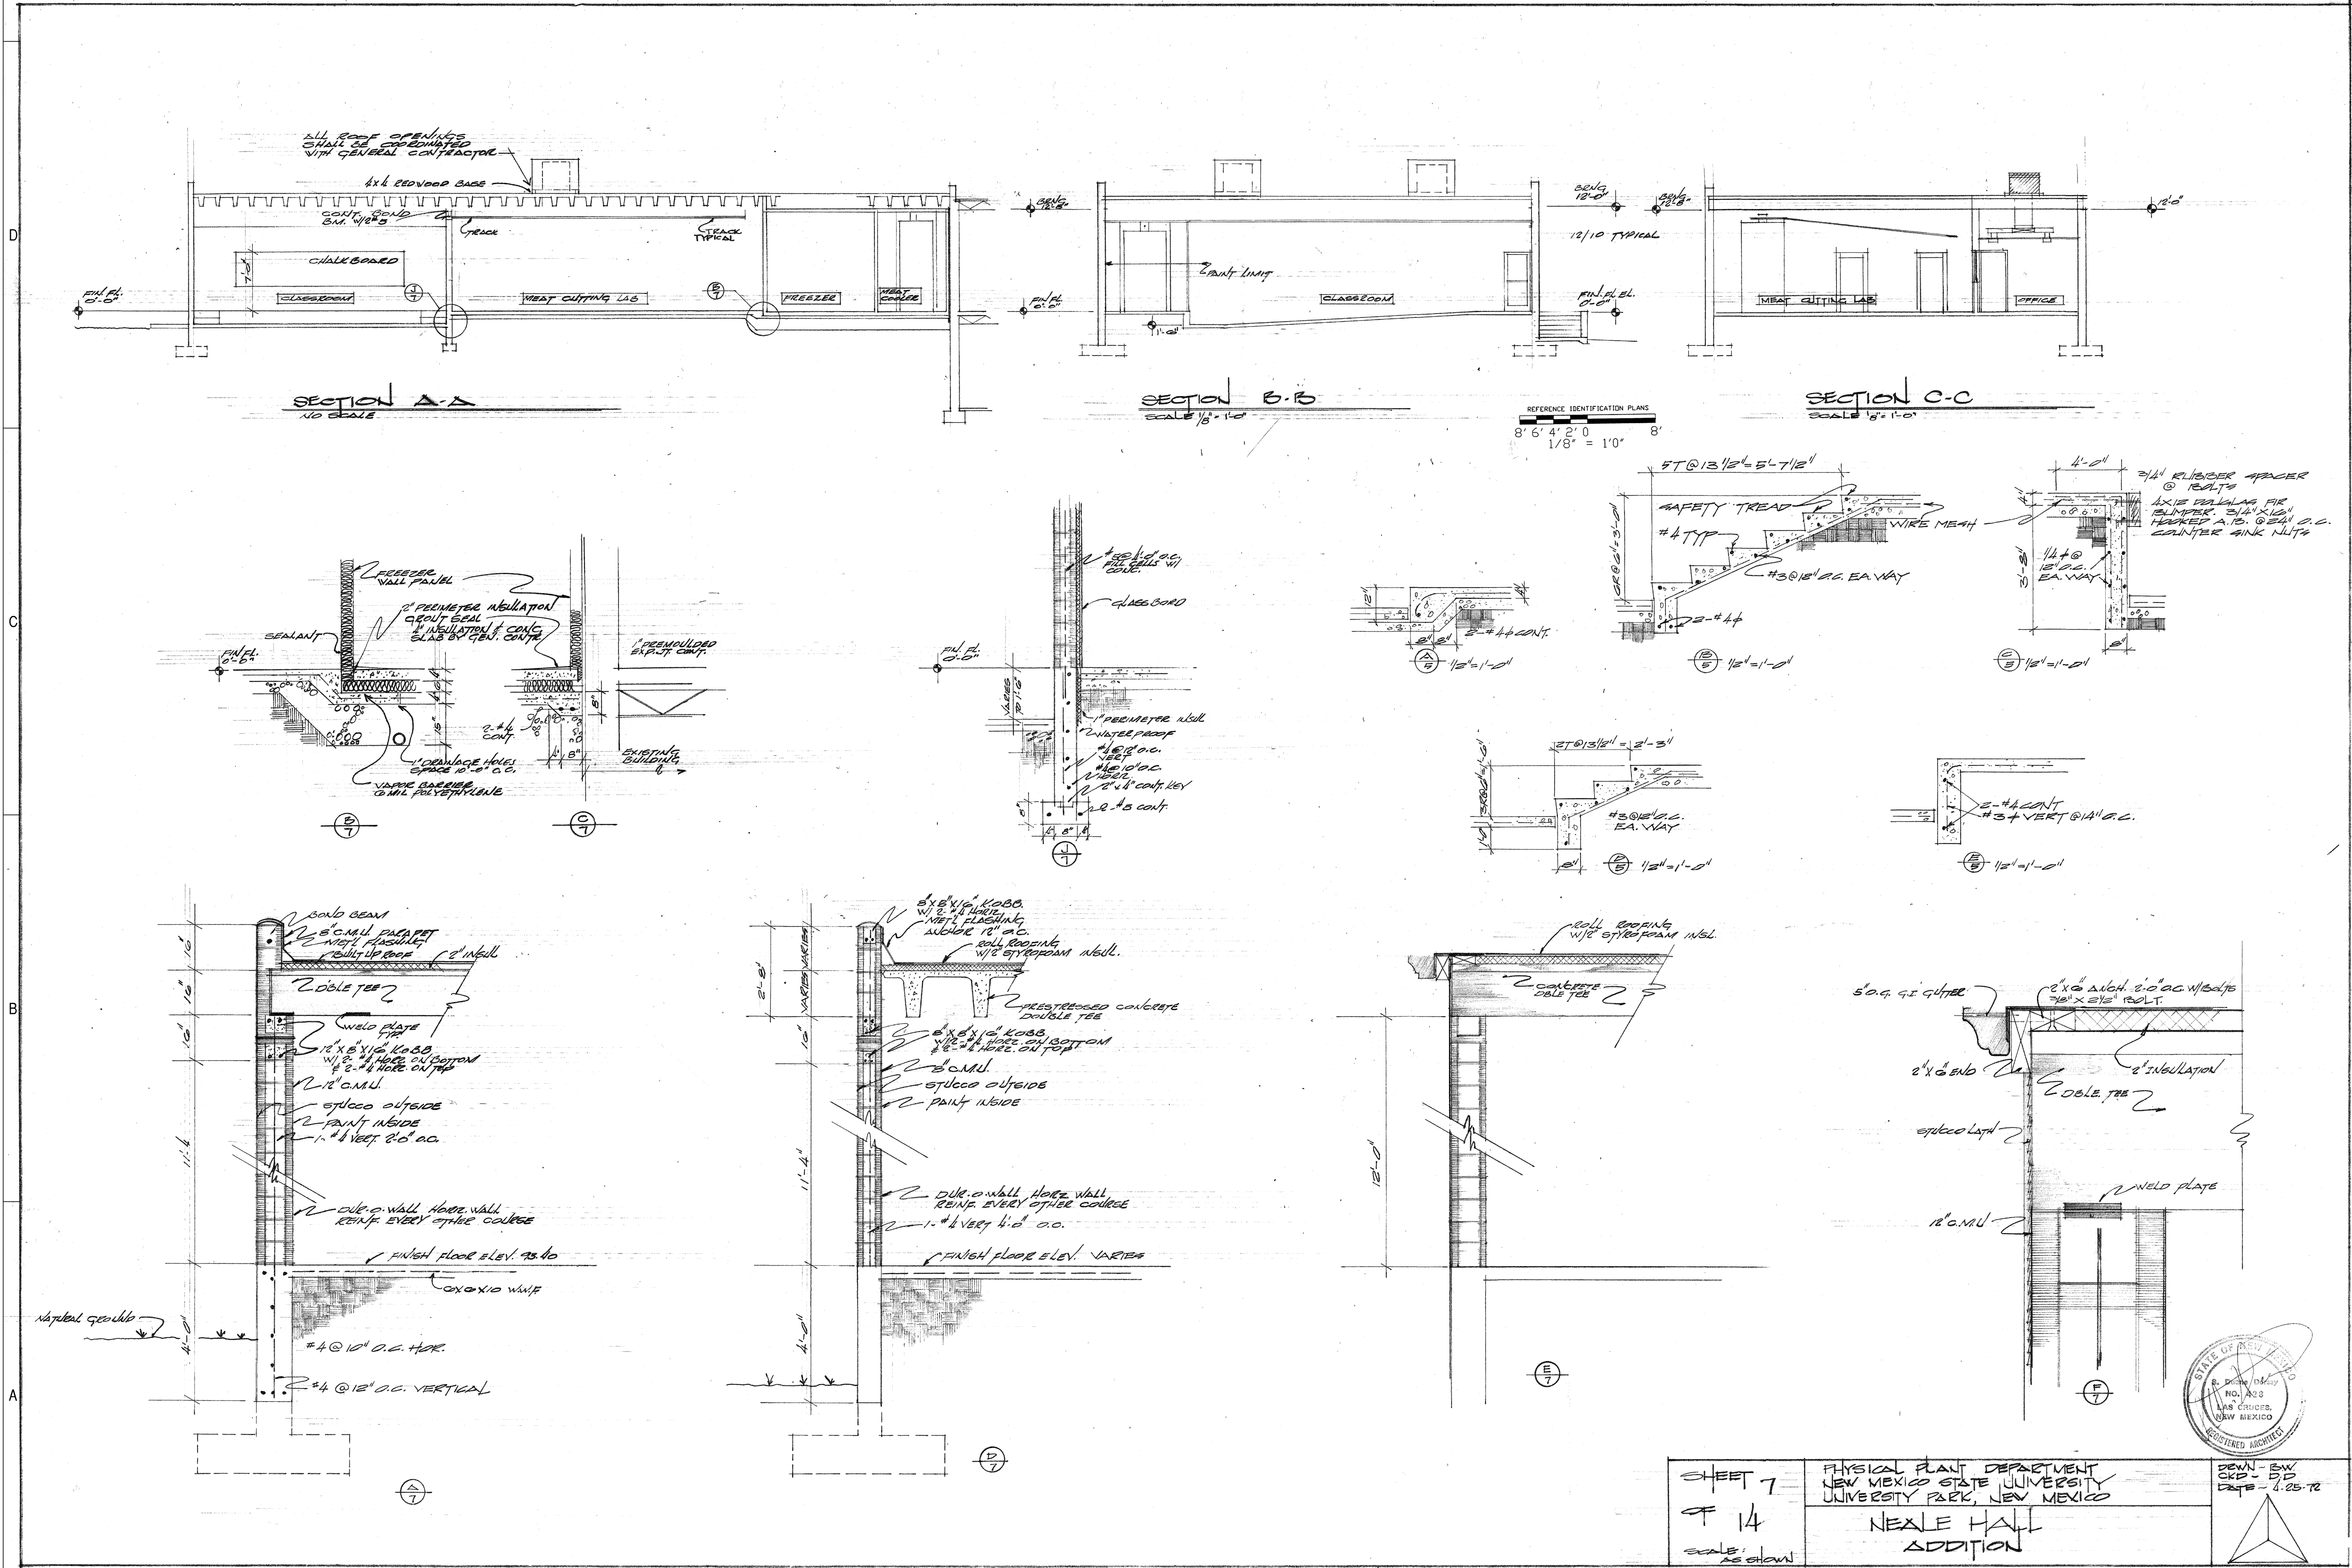
| MARK | DATE | DESCRIPTION |
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ISSUE:  
DATE:  
PROJECT NO: 773B  
DRAWN BY: Author  
CHECKED BY: Checker

SHEET TITLE  
EXISTING PLANS

SHEET 7 OF 14

SCALE: AS SHOWN

PHYSICAL PLANT DEPARTMENT  
NEW MEXICO STATE UNIVERSITY  
UNIVERSITY PARK, NEW MEXICO

NEALE HALL ADDITION

STATE OF NEW MEXICO  
REGISTERED ARCHITECT


DOWN - SW  
UP - NE  
DATE - 1.25.22

CONSULTANTS

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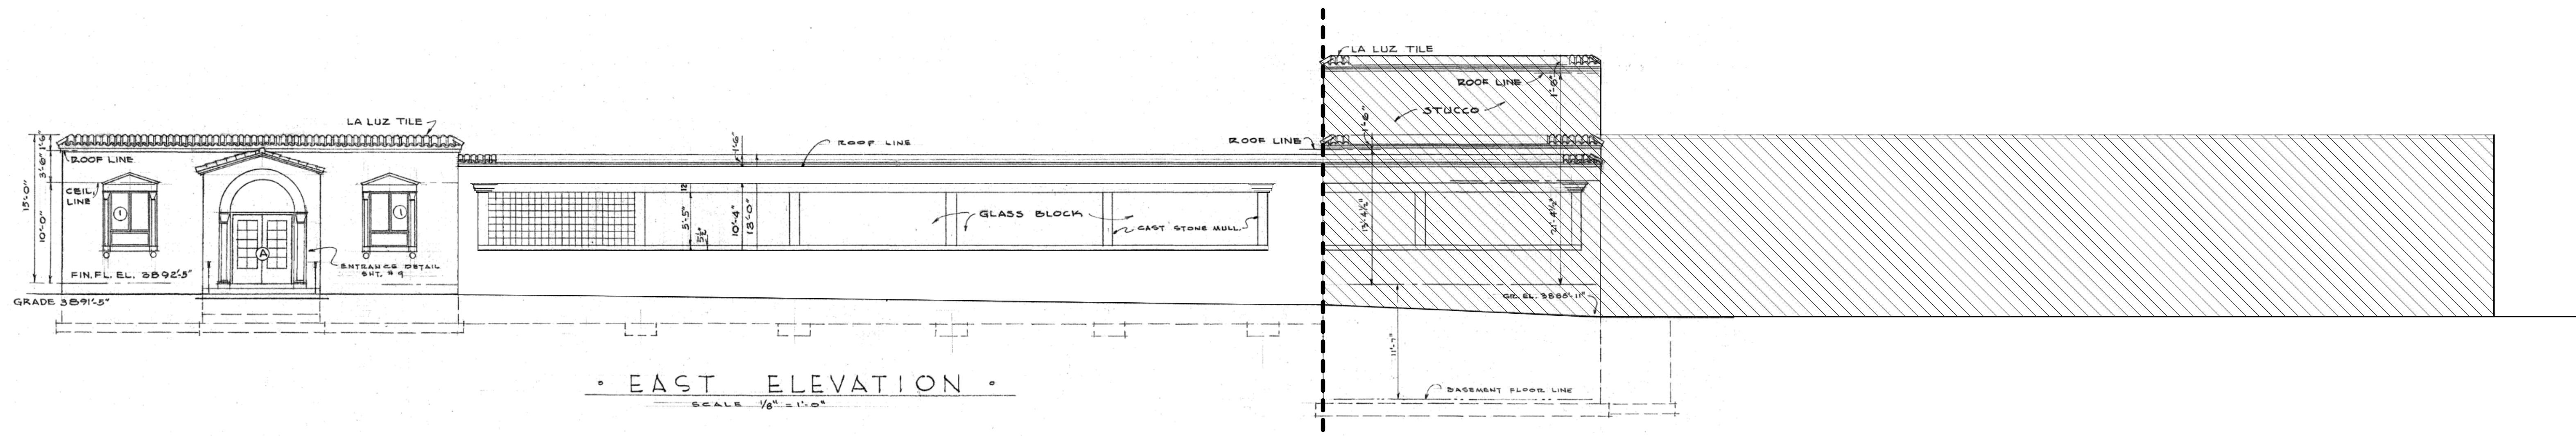
**STRUCTURAL**  
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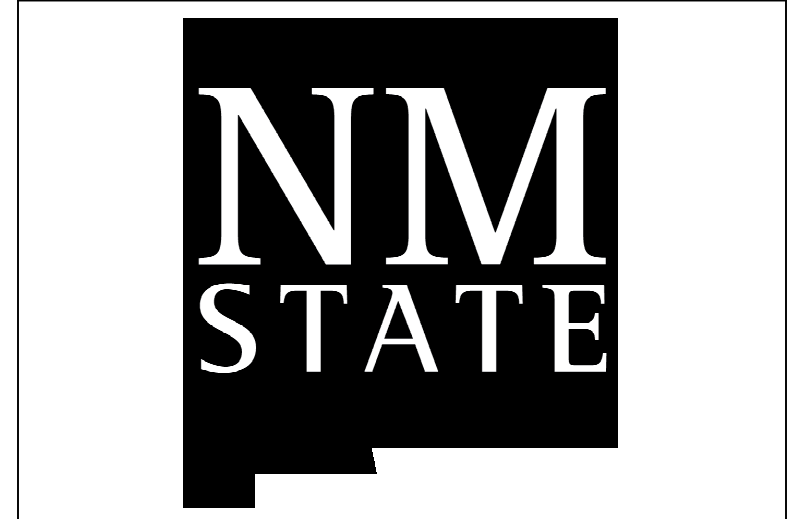
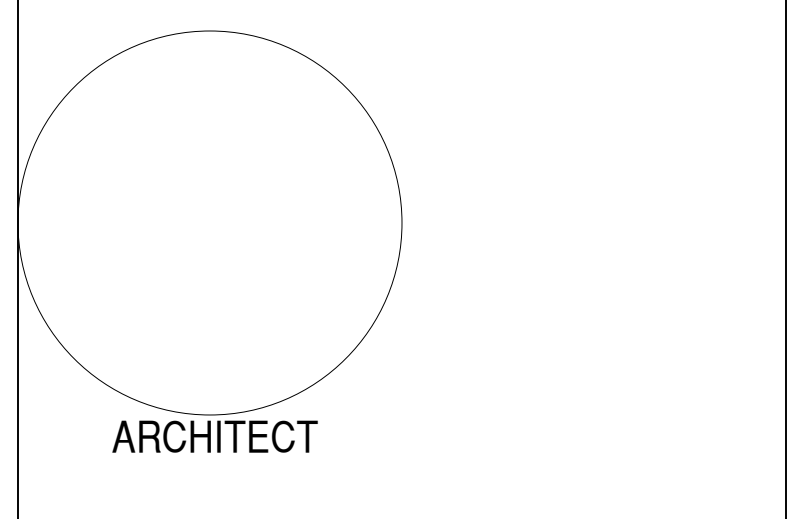
• EAST ELEVATION •  
 SCALE 1/8" = 1'-0"

B1 EAST ELEVATION - EXISTING  
 1/8" = 1'-0"

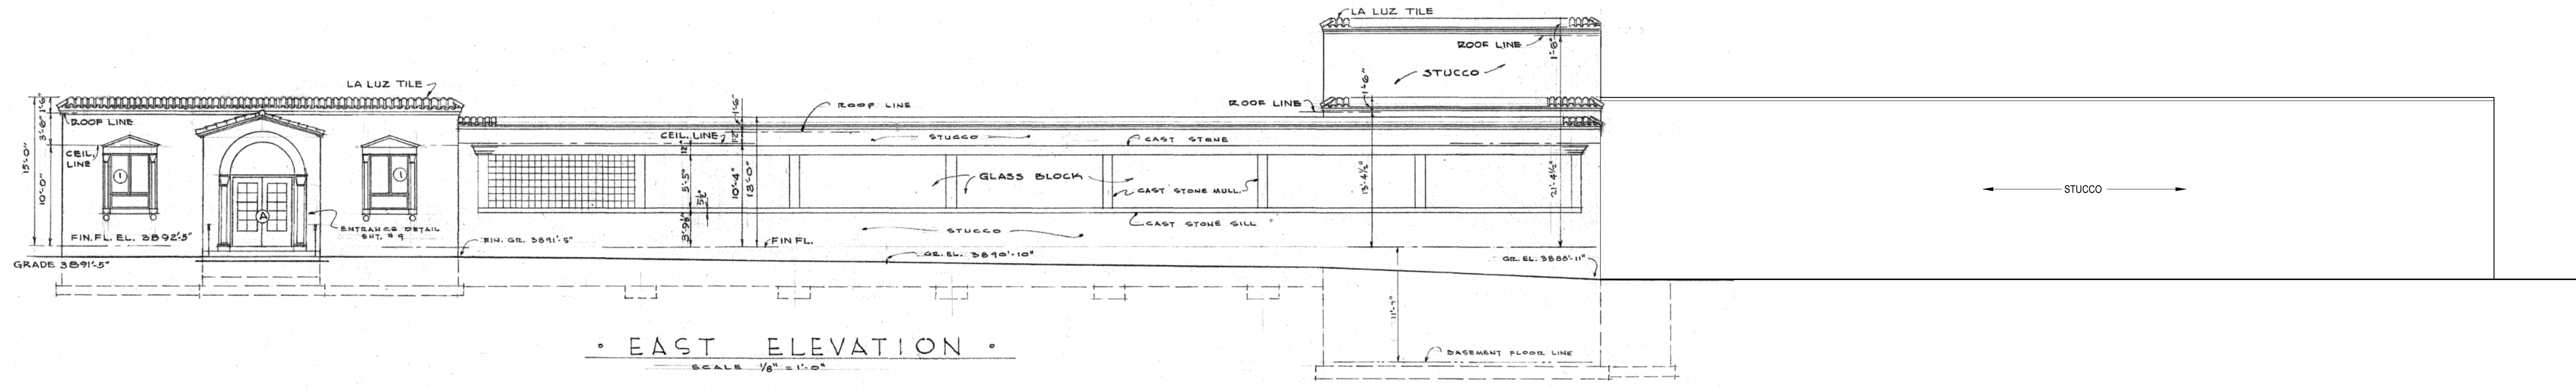

• EAST ELEVATION •  
 SCALE 1/8" = 1'-0"

A1 EAST ELEVATION - NEW  
 1/8" = 1'-0"



**AG MOD PHASE 3: NEALE HALL DEMO**

**95% CONSTRUCTION DOCUMENTS**

3198 S. Espina St  
 Las Cruces, NM 88001  
 MARCH 12, 2024

| MARK | DATE | DESCRIPTION |
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ISSUE:  
 DATE:  
 PROJECT NO: 773B  
 DRAWN BY: Author  
 CHECKED BY: Checker

SHEET TITLE  
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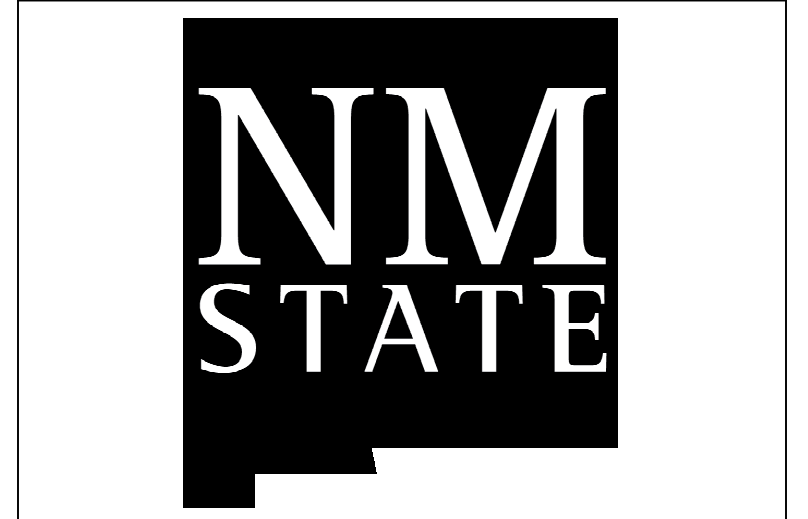
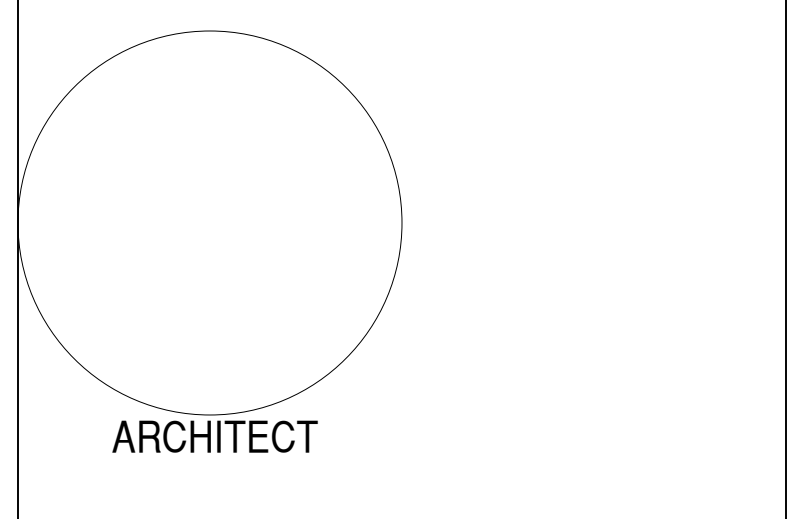
**AE-201**

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**AG MOD PHASE 3: NEALE HALL DEMO**

**95% CONSTRUCTION DOCUMENTS**

3198 S. Espina St  
Las Cruces, NM 88001


MARCH 12, 2024

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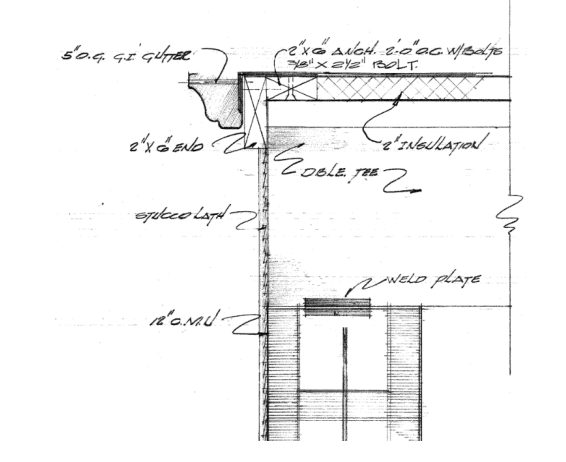
ISSUE:  
DATE:  
PROJECT NO: 773B  
DRAWN BY: Author  
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SHEET TITLE  
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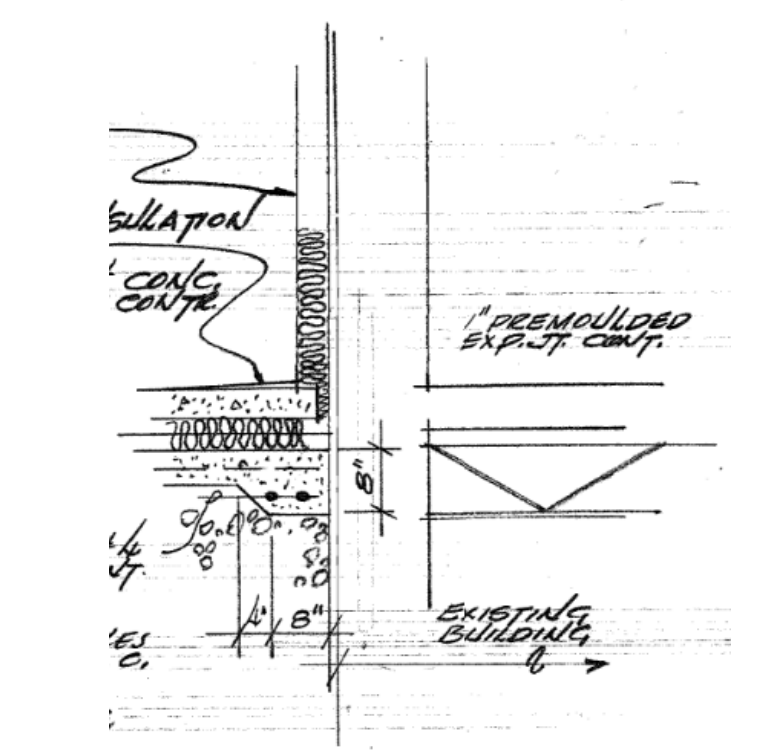
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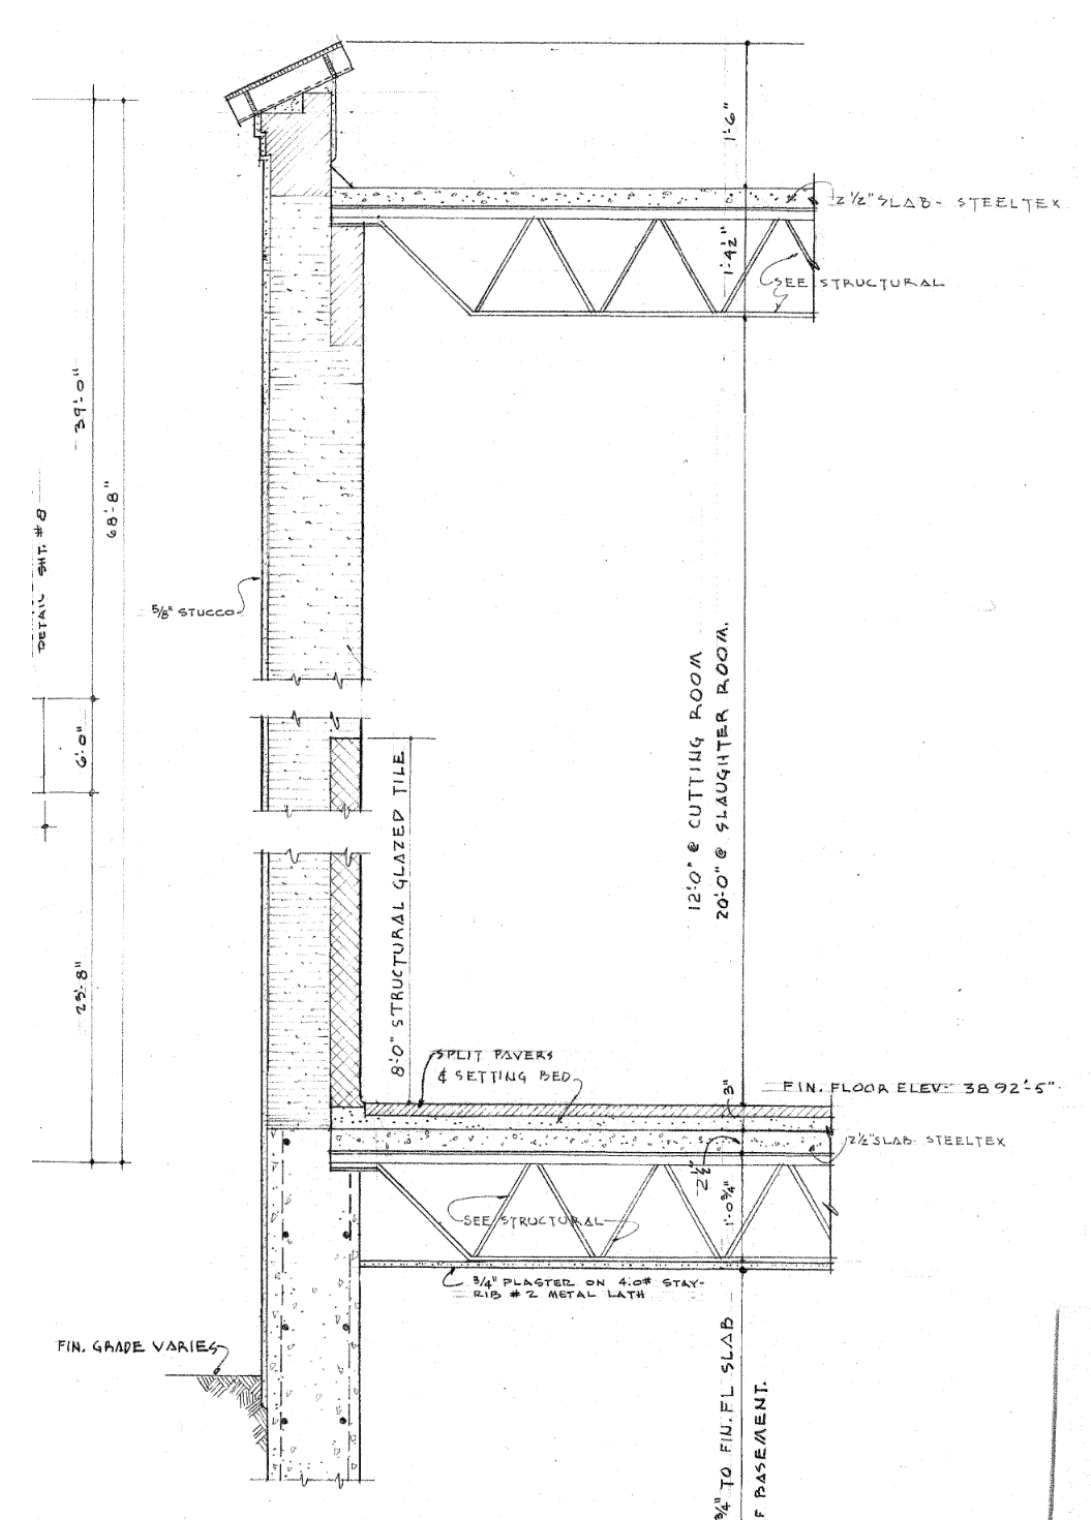
**6 DETAIL C3**  
3/4" = 1'-0"




**5 DETAIL F7**  
3/4" = 1'-0"

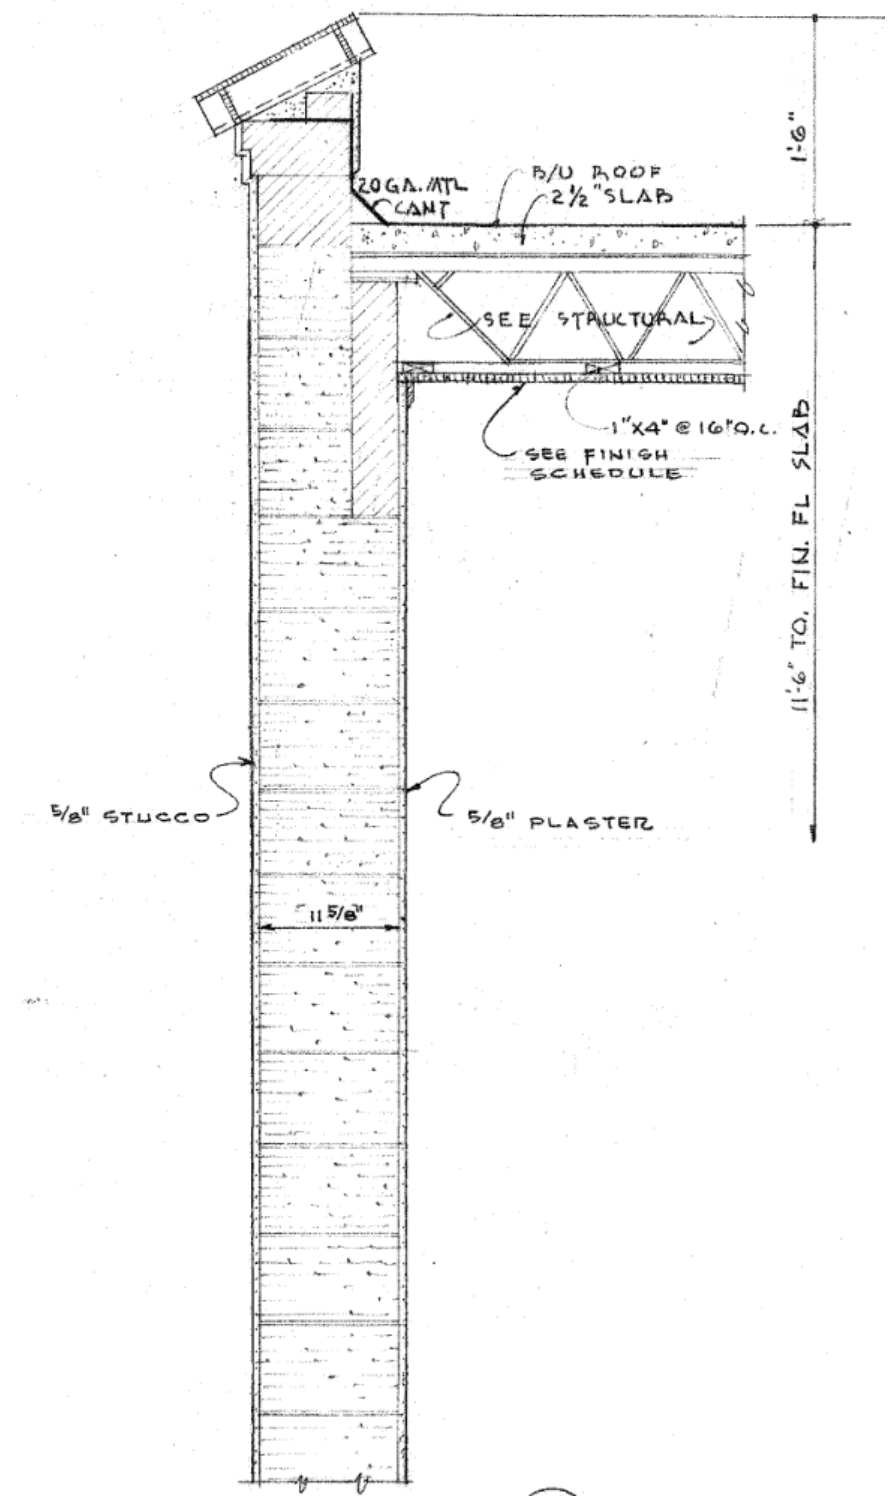


**4 DETAIL C7**  
1/2" = 1'-0"




**8 FRAMING SECTION A3**  
1/2" = 1'-0"

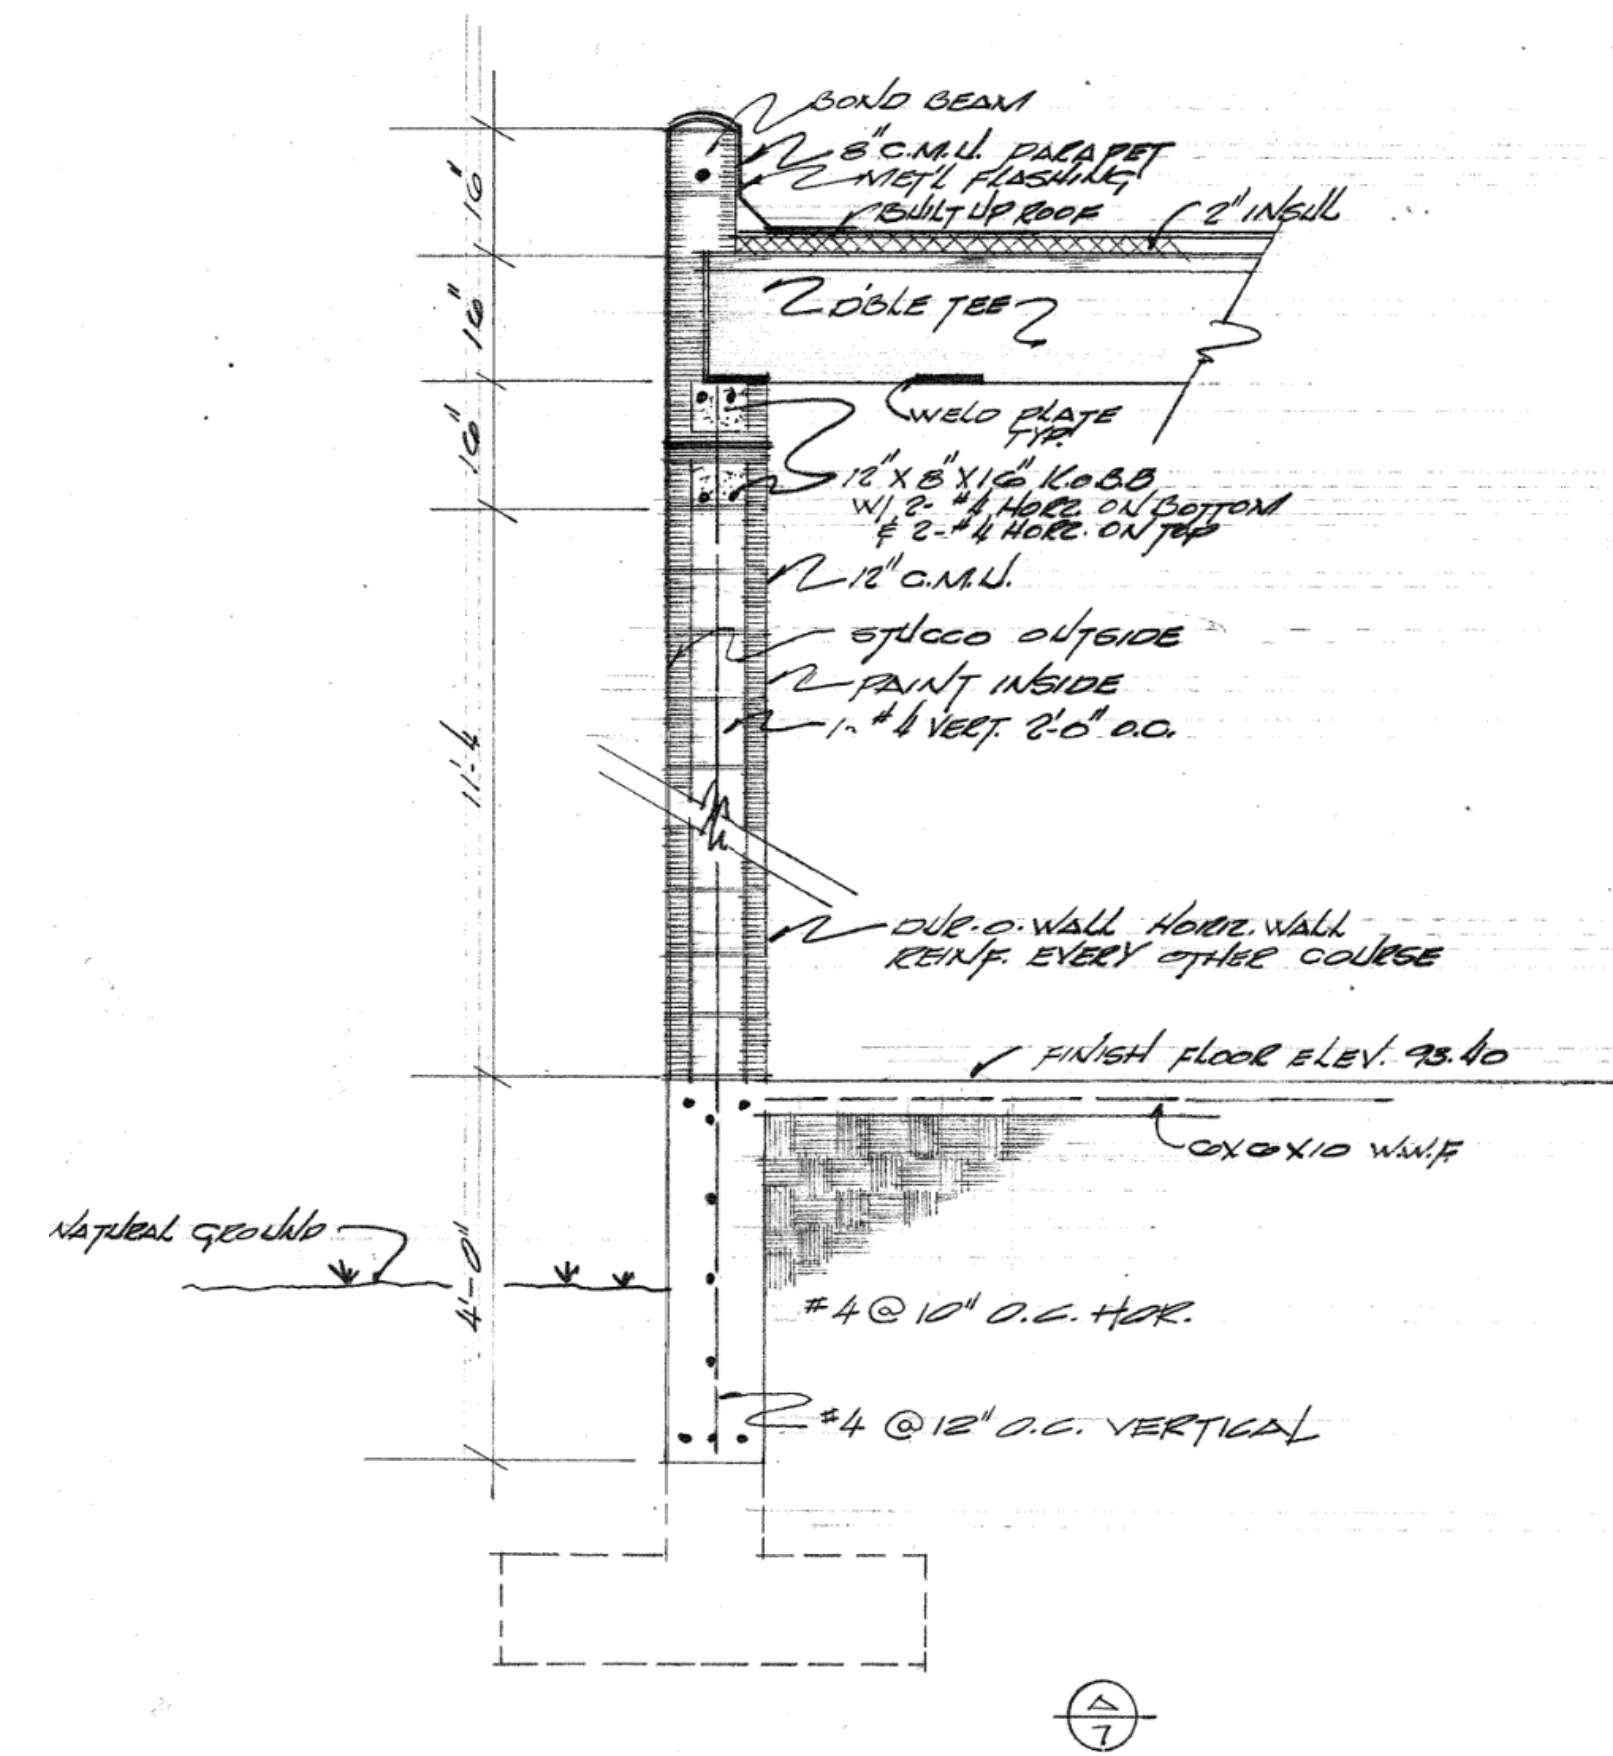


**2 WALL SECTION A7**  
1/2" = 1'-0"

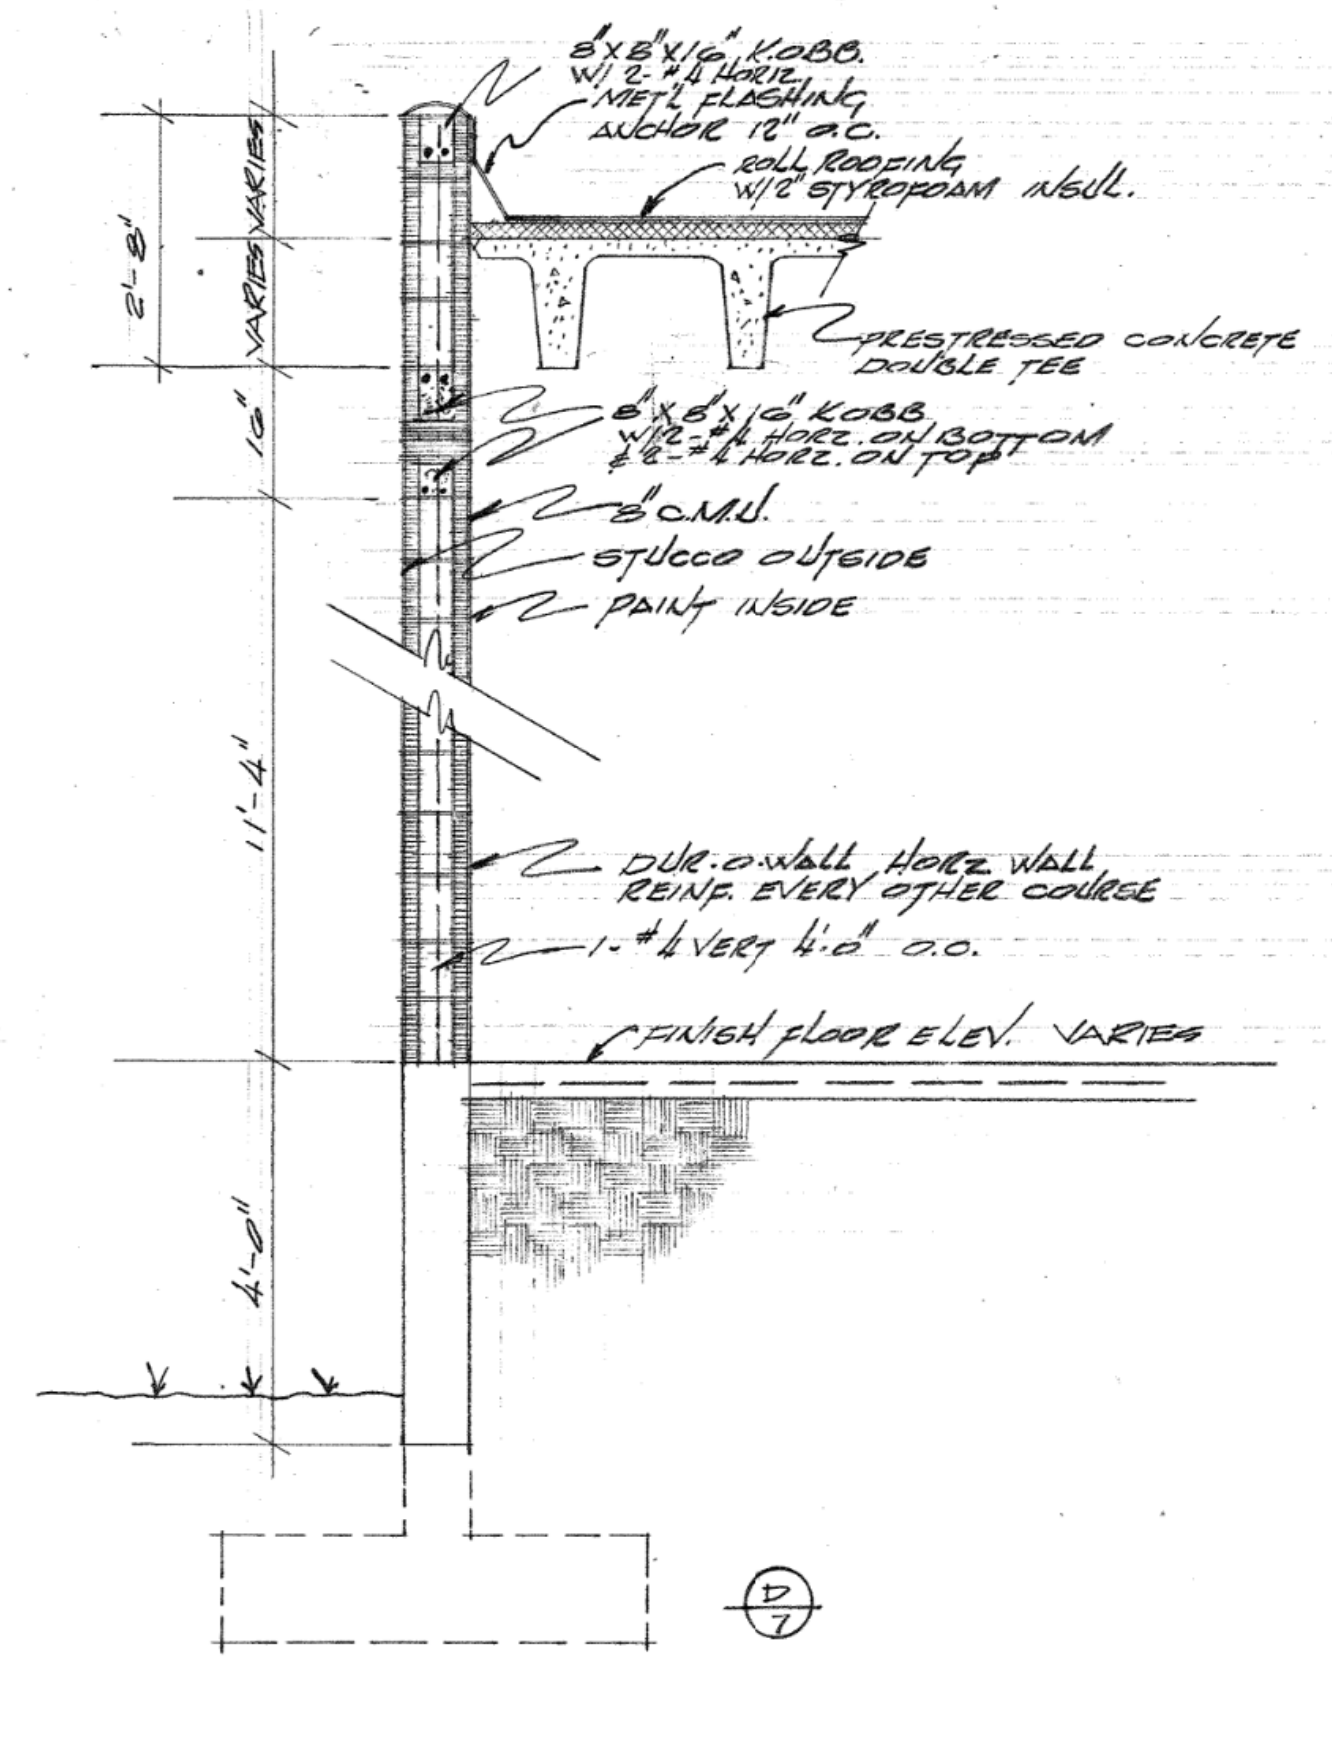

**3 WALL SECTION D7**  
1/2" = 1'-0"

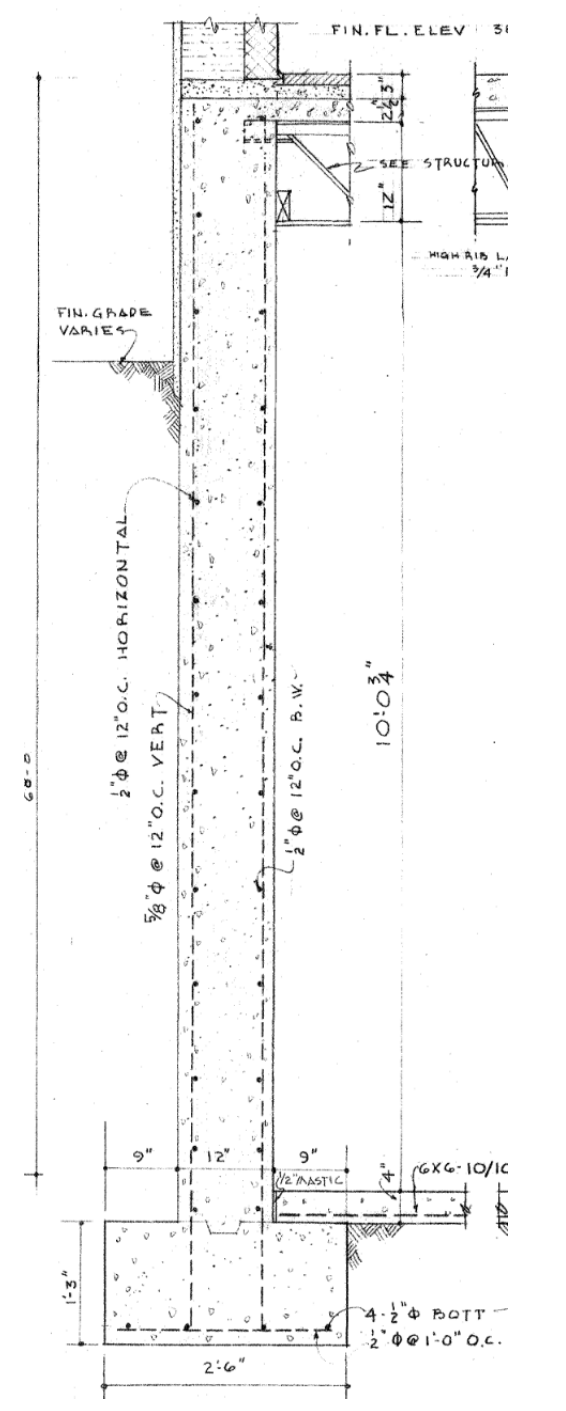

**1 FOUNDATION SECTION A2**  
1/2" = 1'-0"

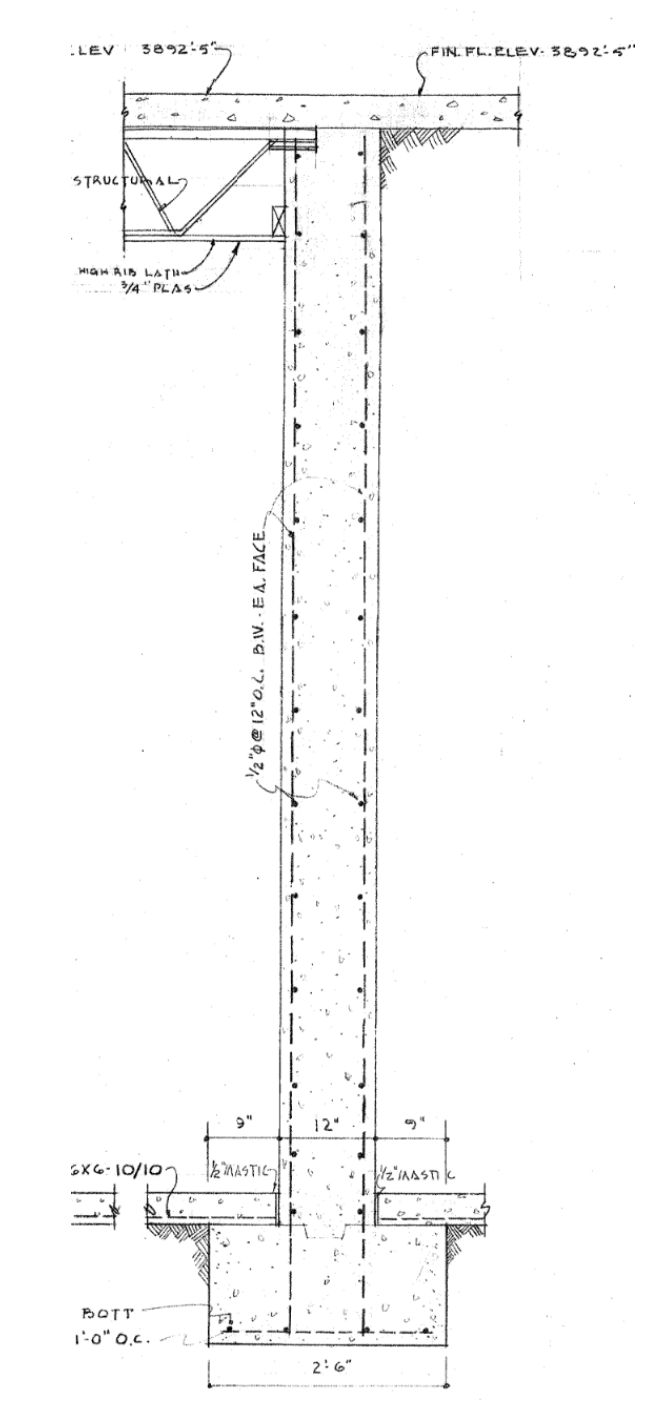

**7 FOUNDATION SECTION B2**  
1/2" = 1'-0"

**STRUCTURAL DEMO NOTES**

- A. INSTALL TEMPORARY POST SHORES IN THE EXISTING BASEMENT PRIOR TO DEMOLITION OPERATIONS.
- B. SAWCUT ROOF JOISTS AND DECK AT EXISTING WALL TO REMAIN PRIOR TO REMOVAL OF THE EXISTING ROOF.
- C. SAWCUT MAIN LEVEL FLOOR SLAB AND FLOOR JOISTS AT REMAINING WALL SURFACE PRIOR TO REMOVAL.
- D. SAWCUT UPPER AND LOWER LEVEL INTERSECTING WALLS AT THE SURFACE OF THE WALL TO REMAIN PRIOR TO REMOVAL.
- E. SAWCUT AND REMOVE BASEMENT SLAB UP TO TEMPORARY BRACES AND BASEMENT WALLS.
- F. BEGIN BACKFILL OPERATIONS TO BRING SITE TO GRADE. CONTRACTOR SHALL PROVIDE BACKFILL PLAN THAT DESCRIBES REMOVAL OF TEMPORARY BRACES AND REMAINING BASEMENT SLAB ON GRADE WHILE PREVENTING DEFLECTION OF REMAINING BASEMENT WALL.

**GENERAL NOTES**


- A. CONTRACTOR SHALL TAKE ADEQUATE MEASURES TO PROTECT EXISTING FLOOR, WALL, CEILING FINISHES, AND EXISTING EQUIPMENT SCHEDULED TO REMAIN FROM DAMAGE. CONTRACTOR SHALL PREVENT THE ACCUMULATION OF DUST AND CONSTRUCTION DEBRIS. PROVIDE SECURE SEALS USING PLASTIC SHEETS OR OTHER SUITABLE BARRIERS TO PROTECT FINISHES AND EQUIPMENT. ANY DAMAGE TO SUCH ITEMS SHALL BE REPAIRED OR THE ITEM REPLACED BY THE CONTRACTOR AT NO COST TO THE OWNER. CONTRACTOR TO PROVIDE DOCUMENTATION AND INVENTORY OF ITEMS TO REMAIN FINISH STATE PRIOR TO START OF DEMOLITION WORK.
- B. HOUSEKEEPING: THE CONTRACTOR SHALL WORK NEATLY. MAINTAINING ENTIRE EXISTING AREA TO BE REMODELED OR TO REMAIN SECURE AT ALL TIMES UNTIL COMPLETION OF NEW WORK. CONTRACTOR SHALL PROVIDE DAILY CLEANUP IN DEMOLITION AREA TO PREVENT DUST BUILD-UP AND THE ACCUMULATION OF CONSTRUCTION DEBRIS.
- C. CONTRACTOR SHALL COORDINATE ALL ASSOCIATED PLUMBING, MECHANICAL, AND ELECTRICAL DEMOLITION FOR THE PROJECT. SEE PLUMBING/MECHANICAL/ELECTRICAL DEMOLITION DRAWING.
- D. THIS DRAWING INDICATES THE INTENT OF DEMOLITION AT THE EXISTING BUILDING. THE CONTRACTOR IS ADVISED TO VISIT THE JOB SITE TO BECOME FAMILIAR WITH THE SCOPE OF WORK PRIOR TO BIDDING.
- E. THE CONTRACTOR SHALL CAREFULLY EXECUTE DEMOLITION/REMOVAL WORK IDENTIFIED HEREIN AND PERFORM ALL DEMOLITION ON THE SHORTEST TIME POSSIBLE. DEMOLISHED MATERIALS SHALL BE REMOVED FROM THE SITE IMMEDIATELY AND DISPOSED OF LEGALLY.
- F. UTILITIES: LOCATE ALL EXISTING ACTIVE UTILITIES AND DETERMINE ALL REQUIREMENTS FOR DISCONNECTION, RECONNECTION, REROUTING OR CAPPING. CONTRACTOR SHALL PROTECT ALL UTILITIES DESIGNATED TO REMAIN FROM DAMAGE. CONTRACTOR SHALL NOTIFY AND COORDINATE ANY UTILITY INTERRUPTIONS WITH OWNER A MINIMUM OF 10 DAYS IN ADVANCE.
- G. AT LOAD BEARING WALL DEMOLITION: BRACE STRUCTURE AS REQUIRED. COORDINATE WITH STRUCTURAL.
- H. MAINTAIN STRUCTURAL INTEGRITY OF EXISTING WALLS DURING DEMOLITION AND RENOVATION.
- I. ALL DEMOLITION DRAWINGS INDICATE THE GENERAL SCOPE OF WORK. CONTRACTOR IS RESPONSIBLE TO DEMOLISH AND REMOVE ALL EXISTING BUILDING ELEMENTS REQUIRED TO COMPLETE WORK.
- J. CONTRACTOR SHALL BE RESPONSIBLE FOR SECURITY AND WEATHERIGHTNESS OF EXISTING BUILDING AFTER ANY PARTIAL DEMOLITION. TEMPORARY DOOR, CANOPIES, FENCING, ETC. TO BE INCLUDED.

**KEYED NOTES**

- 1. DEMOLISH AND REMOVE BUILDING IN ITS ENTIRETY. DEMOLISH AND REMOVE EXISTING BASEMENT. SEE DEMOLITION PLANS FOR EXTEND OF WORK.
- 2. EXISTING WALL TO REMAIN. REFER TO STRUCTURAL FOR BRACING SUPPORT AS NEEDED.
- 3. REMOVE EXISTING GLASS WINDOW INFILL - LIMITED TO EXTENT SHOWN ON PLAN. CONTRACTOR TO MAINTAIN STRUCTURAL INTEGRITY OF WALL OPENING.
- 4. REMOVE EXISTING LOADING DOCK, CONCRETE PLATFORM, STAIRS, RAILINGS, WALLS, GATES, AND RAMP - EXTENT AS SHOWN ON PLAN.
- 5. DEMOLISH EXISTING INTERIOR GYP BOARD WALL IN ITS ENTIRETY. EXTENTS AS SHOWN.
- 6. DEMOLISH EXISTING SITE CONCRETE IN ITS ENTIRETY. EXTENTS AS SHOWN.

**LEGEND**

- EXISTING WALLS TO REMAIN
- EXISTING WALLS TO BE DEMOLISHED
- BUILDING DEMOLITION
- SITE DEMOLITION

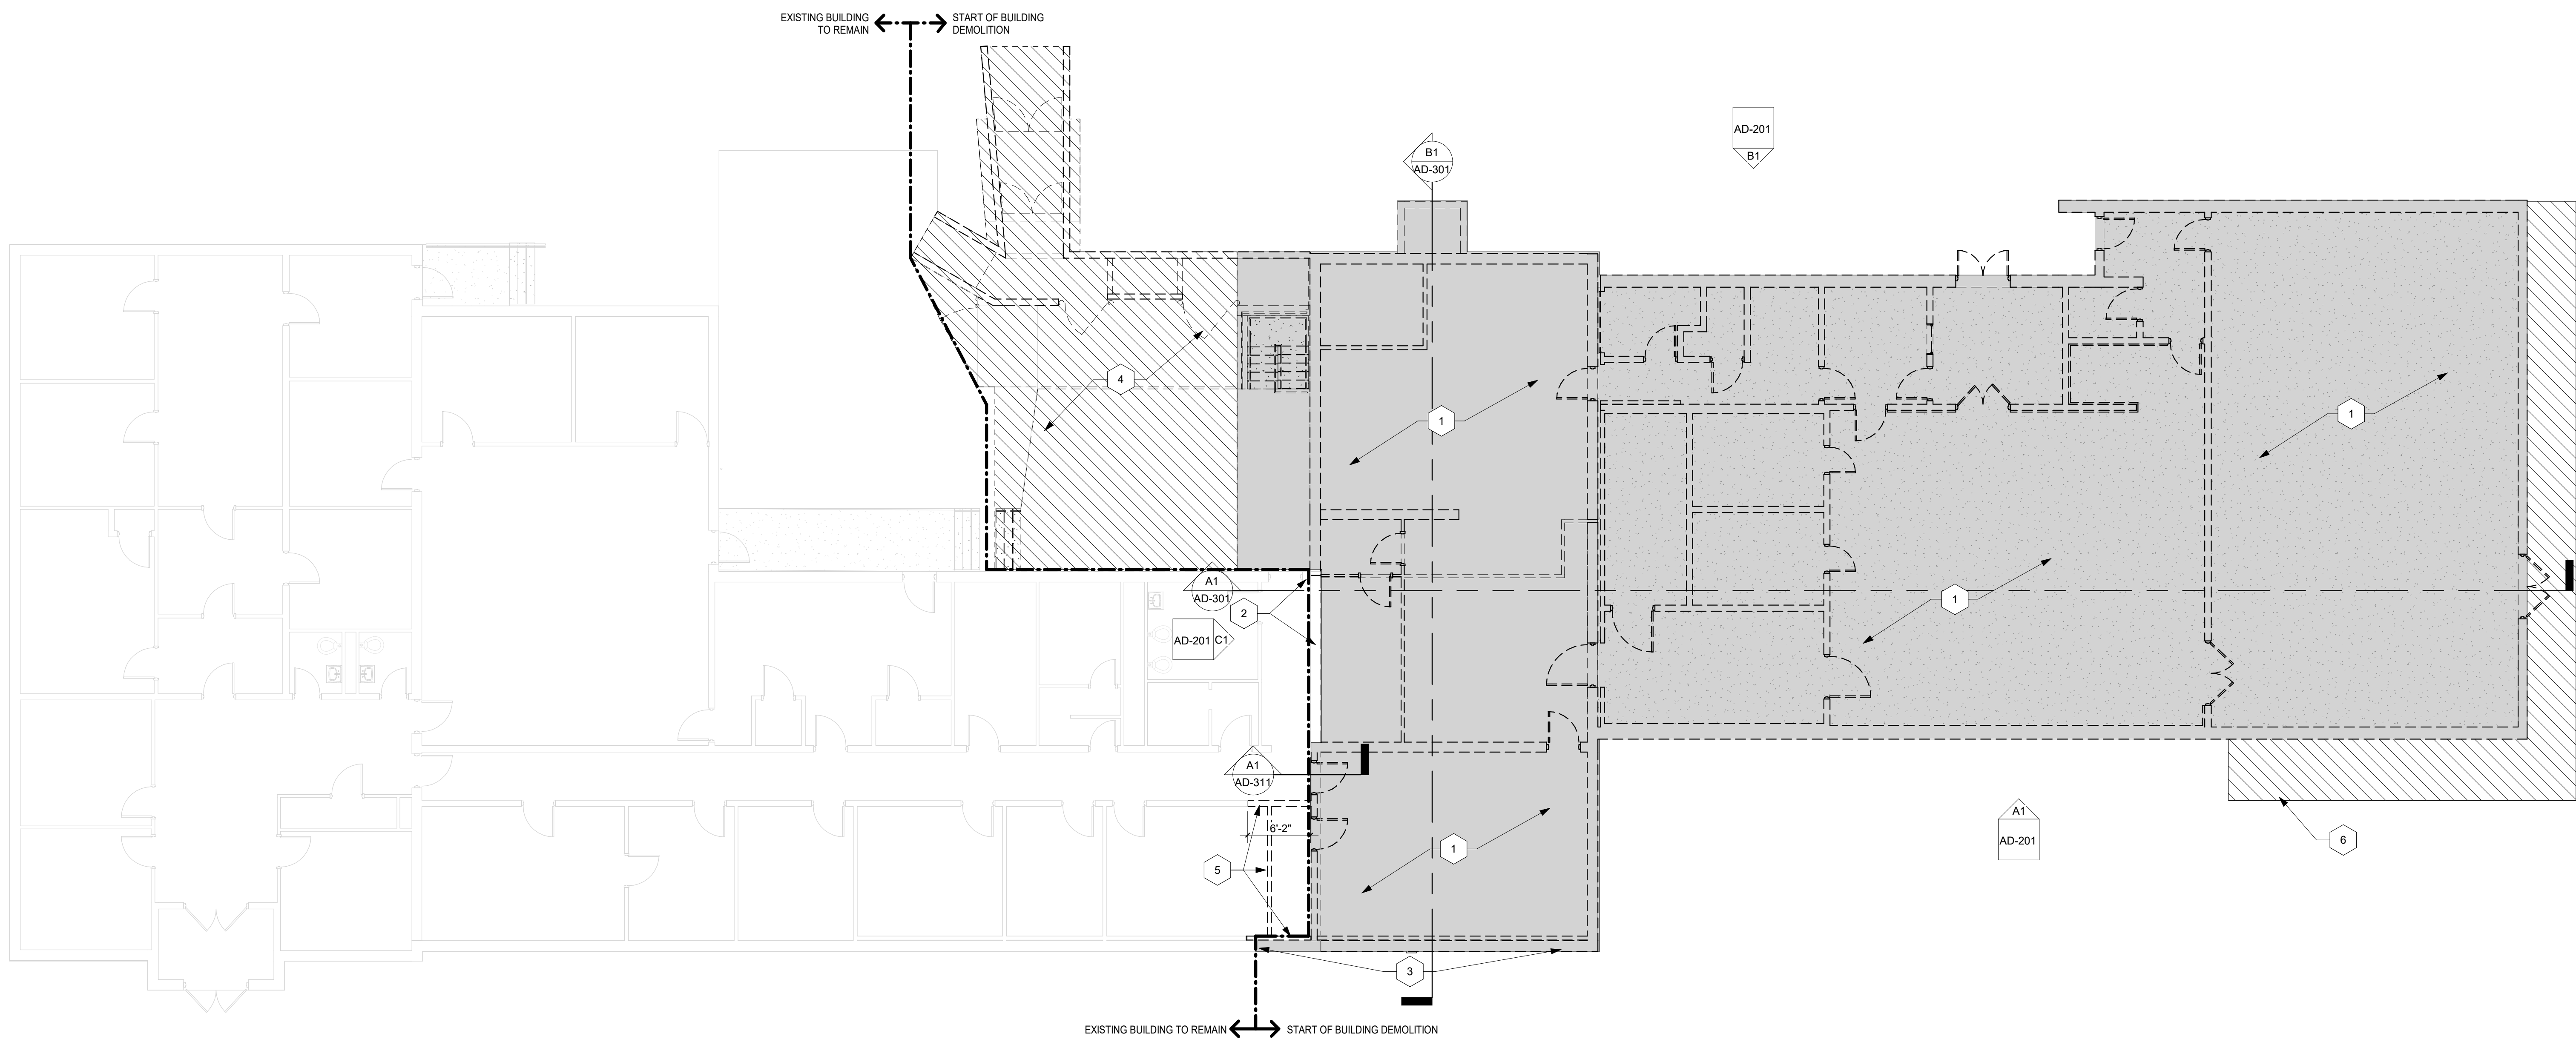


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**AG MOD PHASE 3: NEALE HALL DEMO**

**95% CONSTRUCTION DOCUMENTS**

3198 S. Espina St  
 Las Cruces, NM 88001

MARCH 12, 2024
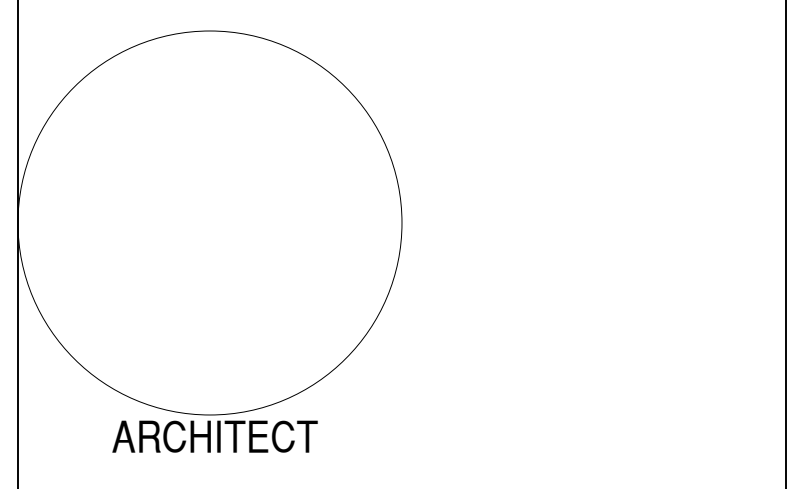
| MARK | DATE | DESCRIPTION |
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ISSUE:  
 DATE:  
 PROJECT NO: 773B  
 DRAWN BY: Author  
 CHECKED BY: Checker

SHEET TITLE  
 OVERALL DEMOLITION FLOOR PLAN

**AD-100**

**A1 OVERALL DEMOLITION FLOOR PLAN**  
 1/8" = 1'-0"



STRUCTURAL DEMO NOTES

- A. INSTALL TEMPORARY POST SHORES IN THE EXISTING BASEMENT PRIOR TO DEMOLITION OPERATIONS.
- B. SAWCUT ROOF JOISTS AND DECK AT EXISTING WALL TO REMAIN PRIOR TO REMOVAL OF THE EXISTING ROOF.
- C. SAWCUT MAIN LEVEL FLOOR SLAB AND FLOOR JOISTS AT REMAINING WALL SURFACE PRIOR TO REMOVAL.
- D. SAWCUT UPPER AND LOWER LEVEL INTERSECTING WALLS AT THE SURFACE OF THE WALL TO REMAIN PRIOR TO REMOVAL.
- E. SAWCUT AND REMOVE BASEMENT SLAB UP TO TEMPORARY BRACES AND BASEMENT WALLS.
- F. BEGIN BACKFILL OPERATIONS TO BRING SITE TO GRADE. CONTRACTOR SHALL PROVIDE BACKFILL PLAN THAT DESCRIBES REMOVAL OF TEMPORARY BRACES AND REMAINING BASEMENT SLAB ON GRADE WHILE PREVENTING DEFLECTION OF REMAINING BASEMENT WALL.

KEYED NOTES

- 1. DEMOLISH EXISTING EXTERIOR CMU WALL IN ITS ENTIRETY. EXTENTS AS SHOWN.
- 2. DEMOLISH EXISTING DOOR AND FRAME IN ITS ENTIRETY. EXTENTS AS SHOWN.
- 3. DEMOLISH EXISTING WINDOW IN ITS ENTIRETY. SUPPORT ROOF AS REQUIRED DURING DEMO. EXTENTS AS SHOWN.
- 4. DEMOLISH EXISTING INTERIOR GYP BOARD WALL IN ITS ENTIRETY. EXTENTS AS SHOWN.
- 5. DEMOLISH EXISTING INTERIOR CMU WALL IN ITS ENTIRETY. EXTENTS AS SHOWN.
- 6. DEMOLISH FREEZER WALLS IN THEIR ENTIRETY.
- 7. DEMOLISH STAIRS AND SITE LOADING DOCK. SEE ASD-101
- 8. DEMO CONCRETE SLAB TO SUPPORT UTILITY CONNECTIONS AS REQUIRED. REPAIR AND REPLACE CONCRETE SLAB TO MATCH EXISTING AFTER UTILITY INSTALLATION.
- 9. DEMOLISH CONCRETE PIT. INFILL WITH ENGINEERED FILL AND INSTALL ASPHALT PAVEMENTS LEVEL WITH SURROUNDING ASPHALT.
- 10. DEMOLISH EXISTING OVERHEAD DOOR AND FRAME IN ITS ENTIRETY. EXTENTS AS SHOWN.
- 11. PROTECT EXISTING WALLS AND DOORS TO REMAIN DURING DEMOLITION AND CONSTRUCTION.
- 12. DEMOLISH CASEWORK IN ITS ENTIRETY. THIS INCLUDES ANY FIXTURES AND UPPER CASEWORK.
- 13. DEMOLISH EXISTING CEILING TO ACCOMMODATE NEW CONSTRUCTION. COORDINATE EXTENT OF DEMO WITH NEW CONSTRUCTION. EXISTING CEILING TO REMAIN.

GENERAL NOTES

- A. CONTRACTOR SHALL TAKE ADEQUATE MEASURES TO PROTECT EXISTING FLOOR, WALL, CEILING FINISHES, AND EXISTING EQUIPMENT SCHEDULED TO REMAIN FROM DAMAGE. CONTRACTOR SHALL PREVENT THE ACCUMULATION OF DUST AND CONSTRUCTION DEBRIS. PROVIDE SECURE SEALS USING PLASTIC SHEETS OR OTHER SUITABLE BARRIERS TO PROTECT FINISHES AND EQUIPMENT. ANY DAMAGE TO SUCH ITEMS SHALL BE REPAIRED OR THE ITEM REPLACED BY THE CONTRACTOR AT NO COST TO THE OWNER. CONTRACTOR TO PROVIDE DOCUMENTATION AND INVENTORY OF ITEMS TO REMAIN/FINISH STATE PRIOR TO START OF DEMOLITION WORK.
- B. HOUSEKEEPING: THE CONTRACTOR SHALL WORK NEATLY, MAINTAINING ENTIRE EXISTING ARE TO BE REMODELED OR TO REMAIN SECURE AT ALL TIMES UNTIL COMPLETION OF NEW WORK. CONTRACTOR SHALL PROVIDE DAILY CLEANUP IN DEMOLITION AREA TO PREVENT DUST BUILD-UP AND THE ACCUMULATION OF CONSTRUCTION DEBRIS.
- C. CONTRACTOR SHALL COORDINATE ALL ASSOCIATED PLUMBING, MECHANICAL, AND ELECTRICAL DEMOLITION FOR THE PROJECT. SEE PLUMBING/MECHANICAL/ELECTRICAL DEMOLITION DRAWING.
- D. THIS DRAWING INDICATES THE INTENT OF DEMOLITION AT THE EXISTING BUILDING. THE CONTRACTOR IS ADVISED TO VISIT THE JOB SITE TO BECOME FAMILIAR WITH THE SCOPE OF WORK PRIOR TO BIDDING.
- E. THE CONTRACTOR SHALL CAREFULLY EXECUTE DEMOLITION/REMOVAL WORK IDENTIFIED HEREIN AND PERFORM ALL DEMOLITION ON THE SHORTEST TIME POSSIBLE. DEMOLISHED MATERIALS SHALL BE REMOVED FROM THE SITE IMMEDIATELY, AND DISPOSED OF LEGALLY.
- F. UTILITIES: LOCATE ALL EXISTING ACTIVE UTILITIES AND DETERMINE ALL REQUIREMENTS FOR DISCONNECTION, RECONNECTION, REROUTING OR CAPPING. CONTRACTOR SHALL PROTECT ALL UTILITIES DESIGNATED TO REMAIN FROM DAMAGE. CONTRACTOR SHALL NOTIFY AND COORDINATE ANY UTILITY INTERRUPTIONS WITH OWNER A MINIMUM OF 10 DAYS IN ADVANCE.
- G. AT LOAD BEARING WALL DEMOLITION: BRACE STRUCTURE AS REQUIRED. COORDINATE WITH STRUCTURAL.
- H. MAINTAIN STRUCTURAL INTEGRITY OF EXISTING WALLS DURING DEMOLITION AND RENOVATION.
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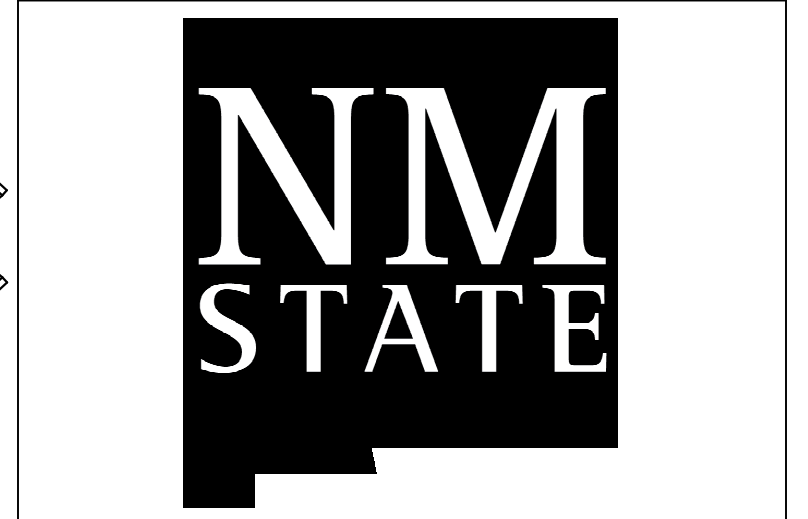
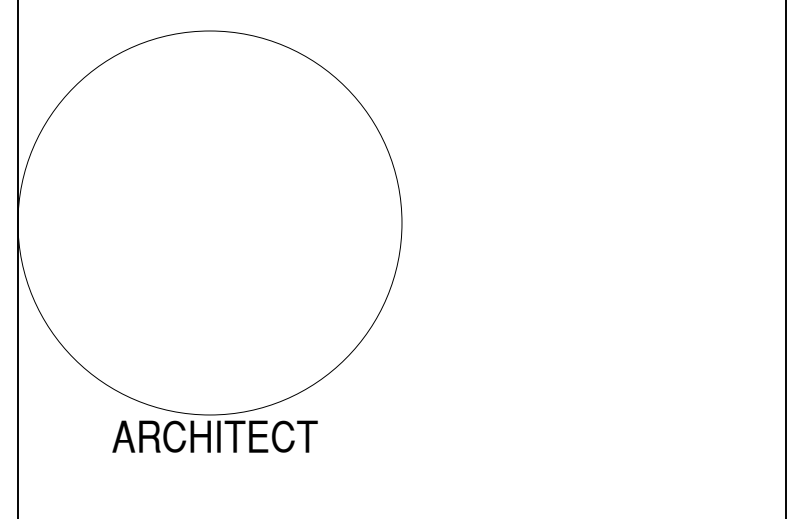


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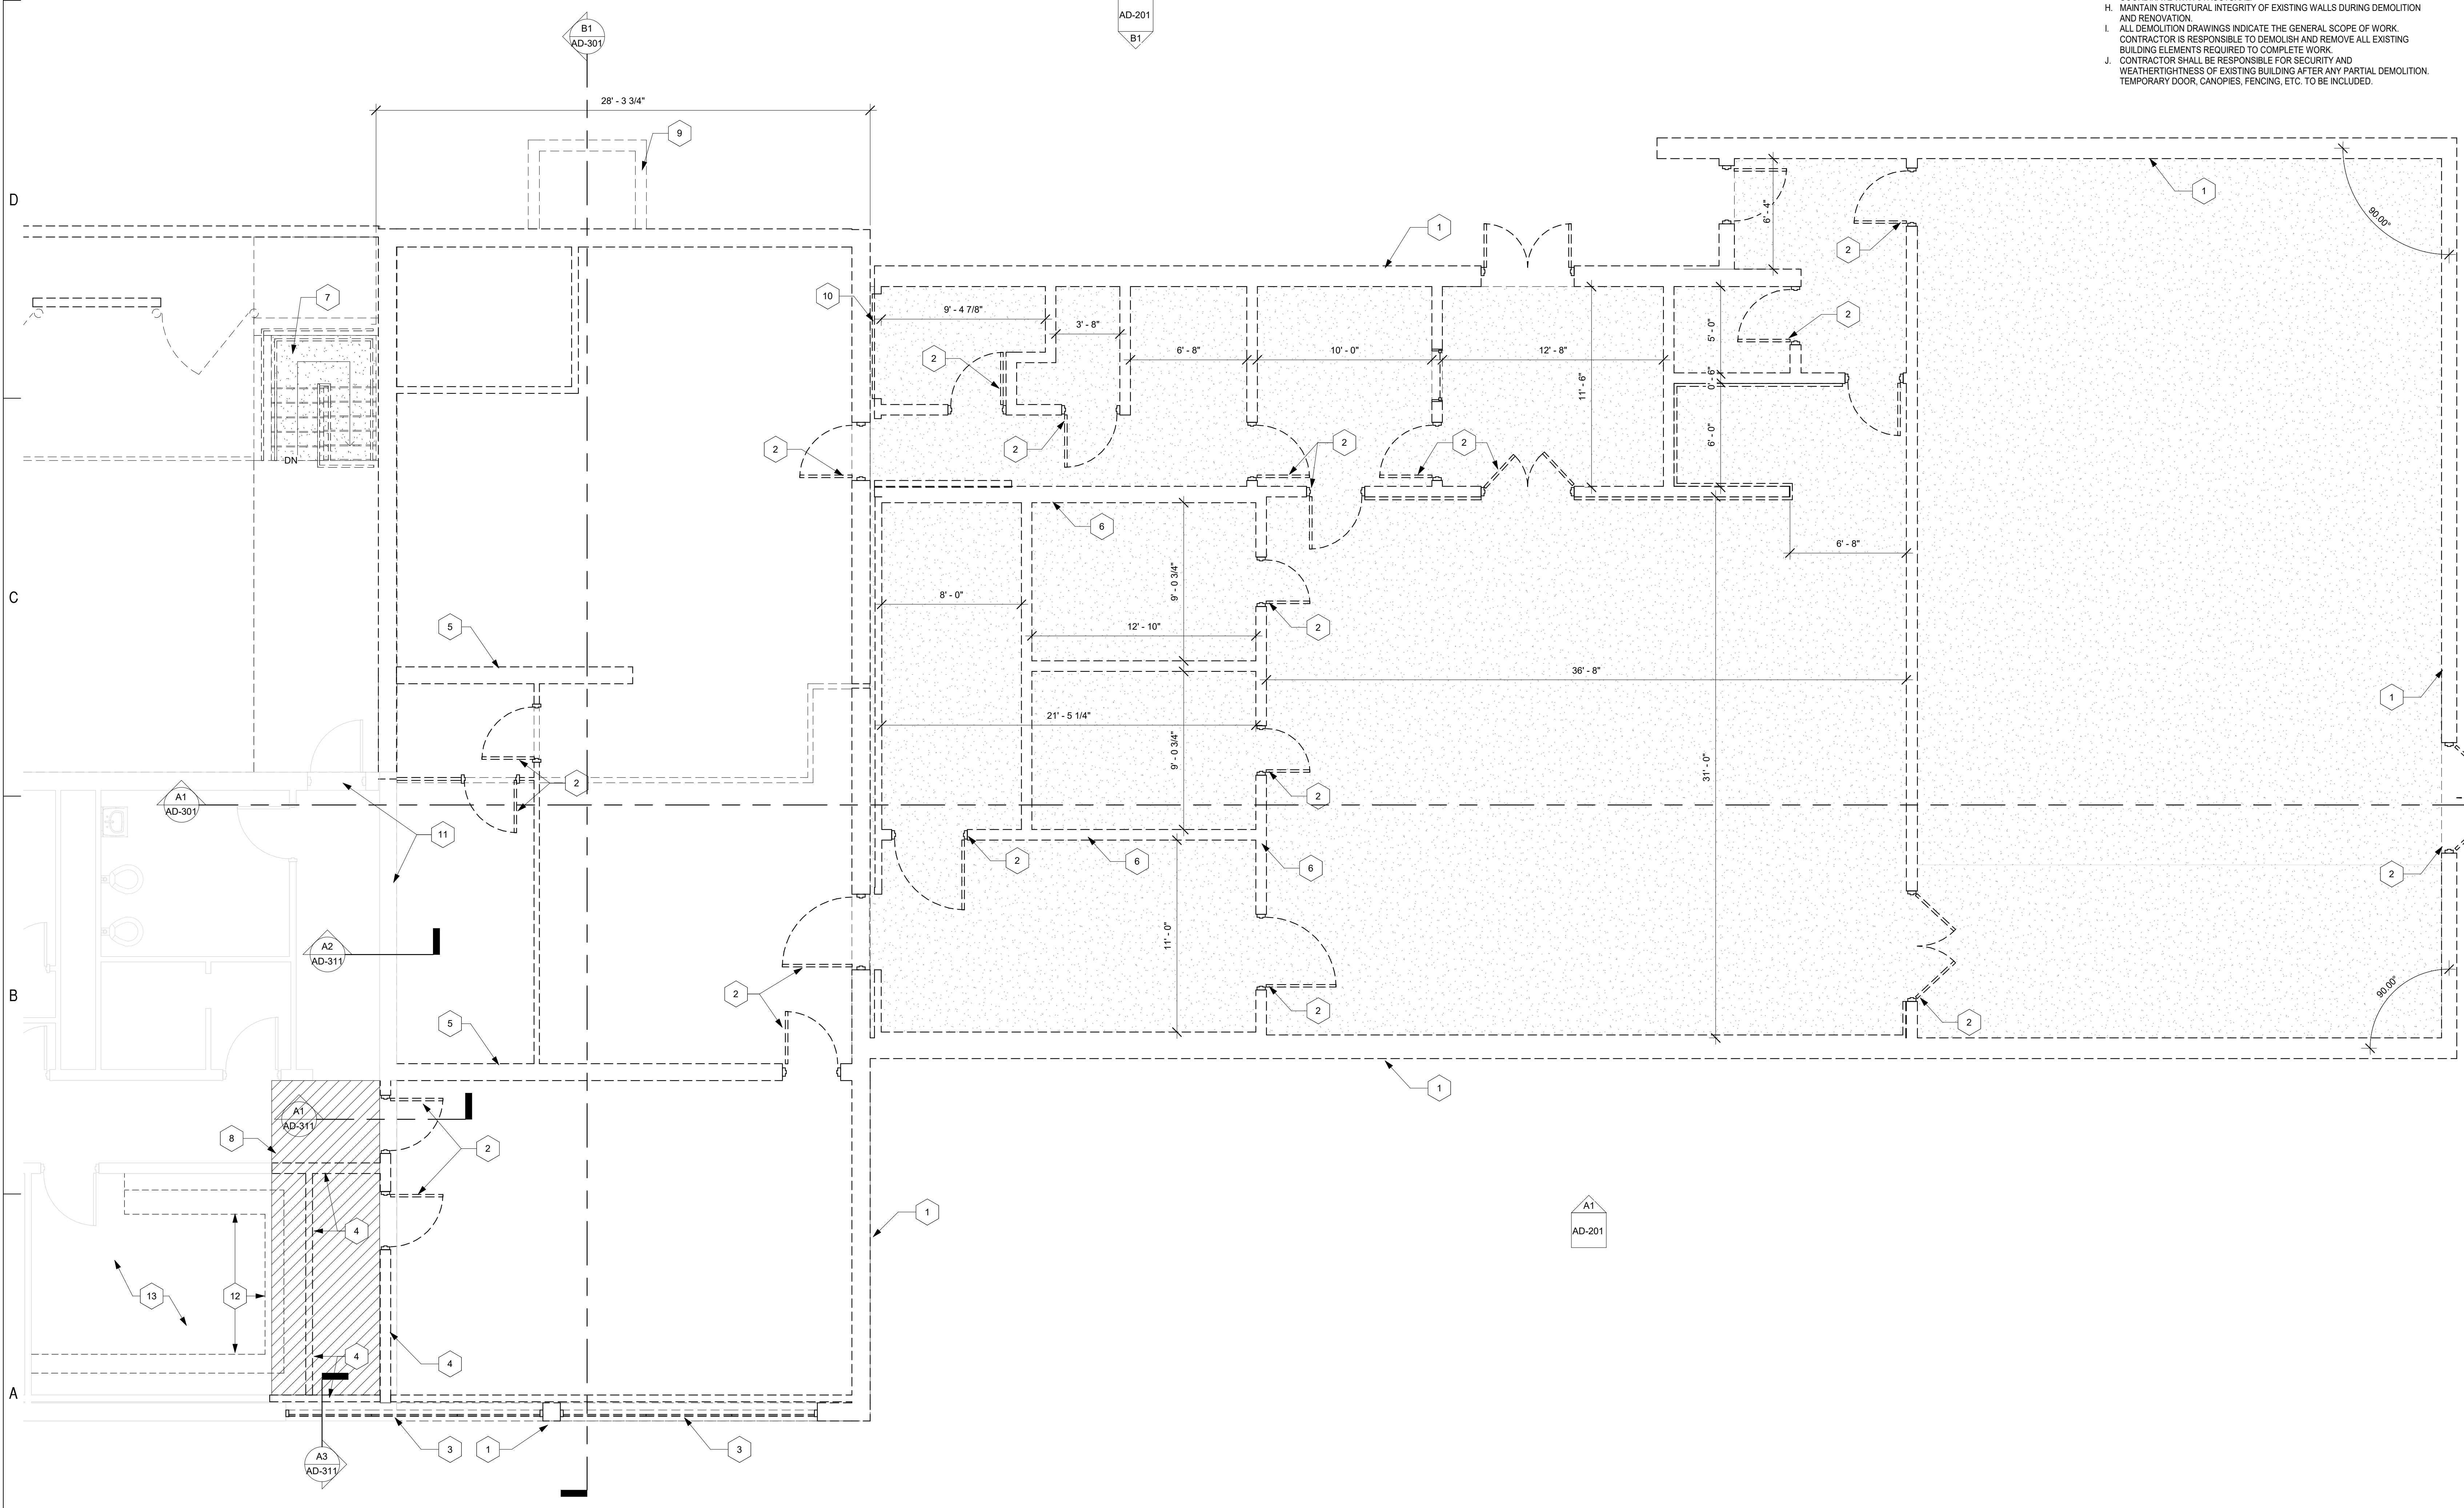
**AG MOD PHASE 3: NEALE HALL DEMO**  
**95% CONSTRUCTION DOCUMENTS**  
3198 S. Espina St  
Las Cruces, NM 88001  
MARCH 12, 2024

| MARK | DATE | DESCRIPTION |
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ISSUE:  
DATE:  
PROJECT NO: 773B  
DRAWN BY: JRC  
CHECKED BY: SBJ

SHEET TITLE  
DEMOLITION FLOOR PLAN

AD-101



**A1** DEMOLITION FLOOR PLAN  
1/4" = 1'-0"

STRUCTURAL DEMO NOTES

- A. INSTALL TEMPORARY POST SHORES IN THE EXISTING BASEMENT PRIOR TO DEMOLITION OPERATIONS.
- B. SAWCUT ROOF JOISTS AND DECK AT EXISTING WALL TO REMAIN PRIOR TO REMOVAL OF THE EXISTING ROOF.
- C. SAWCUT MAIN LEVEL FLOOR SLAB AND FLOOR JOISTS AT REMAINING WALL SURFACE PRIOR TO REMOVAL.
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- F. BEGIN BACKFILL OPERATIONS TO BRING SITE TO GRADE. CONTRACTOR SHALL PROVIDE BACKFILL PLAN THAT DESCRIBES REMOVAL OF TEMPORARY BRACES AND REMAINING BASEMENT SLAB ON GRADE WHILE PREVENTING DEFLECTION OF REMAINING BASEMENT WALL.

KEYED NOTES

- 1 DEMOLISH 12" CONCRETE WALLS AND FOUNDATION. PROVIDE SHORING FOR BUILDING AND WALLS TO REMAIN.
- 2 DEMOLISH CONCRETE SLAB
- 3 DEMOLISH EXISTING DOOR AND FRAME.
- 4 DEMOLISH INTERIOR STUD AND GYP/CARD WALLS.
- 5 DEMOLISH ALL EQUIPMENT, CASEWORK AND FIXTURES IN THEIR ENTIRETY.
- 6 DEMOLISH EXISTING COLUMN AND FOOTING
- 7 DEMOLISH EXISTING STAIRS AND HANDRAILS.
- 8 DEMOLISH EXISTING PIT WALLS, FLOOR AND COVER
- 9 DEMOLISH CASEWORK IN ITS ENTIRETY.
- 10 DEMOLISH CHAINLINK FENCE IN ITS ENTIRETY.
- 11 BUILDING ABOVE TO BE DEMOLISHED

GENERAL NOTES

- A. CONTRACTOR SHALL TAKE ADEQUATE MEASURES TO PROTECT EXISTING FLOOR, WALL, CEILING FINISHES, AND EXISTING EQUIPMENT SCHEDULED TO REMAIN FROM DAMAGE. CONTRACTOR SHALL PREVENT THE ACCUMULATION OF DUST AND CONSTRUCTION DEBRIS. PROVIDE SECURE SEALS USING PLASTIC SHEETS OR OTHER SUITABLE BARRIERS TO PROTECT FINISHES AND EQUIPMENT. ANY DAMAGE TO SUCH ITEMS SHALL BE REPAIRED OR THE ITEM REPLACED BY THE CONTRACTOR AT NO COST TO THE OWNER. CONTRACTOR TO PROVIDE DOCUMENTATION AND INVENTORY OF ITEMS TO REMAIN/FINISH STATE PRIOR TO START OF DEMOLITION WORK.
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- G. AT LOAD BEARING WALL DEMOLITION: BRACE STRUCTURE AS REQUIRED. COORDINATE WITH STRUCTURAL.
- H. MAINTAIN STRUCTURAL INTEGRITY OF EXISTING WALLS DURING DEMOLITION AND RENOVATION.
- I. ALL DEMOLITION DRAWINGS INDICATE THE GENERAL SCOPE OF WORK. CONTRACTOR IS RESPONSIBLE TO DEMOLISH AND REMOVE ALL EXISTING BUILDING ELEMENTS REQUIRED TO COMPLETE WORK.
- J. CONTRACTOR SHALL BE RESPONSIBLE FOR SECURITY AND WEATHERTIGHTNESS OF EXISTING BUILDING AFTER ANY PARTIAL DEMOLITION. TEMPORARY DOOR, CANOPIES, FENCING, ETC. TO BE INCLUDED.





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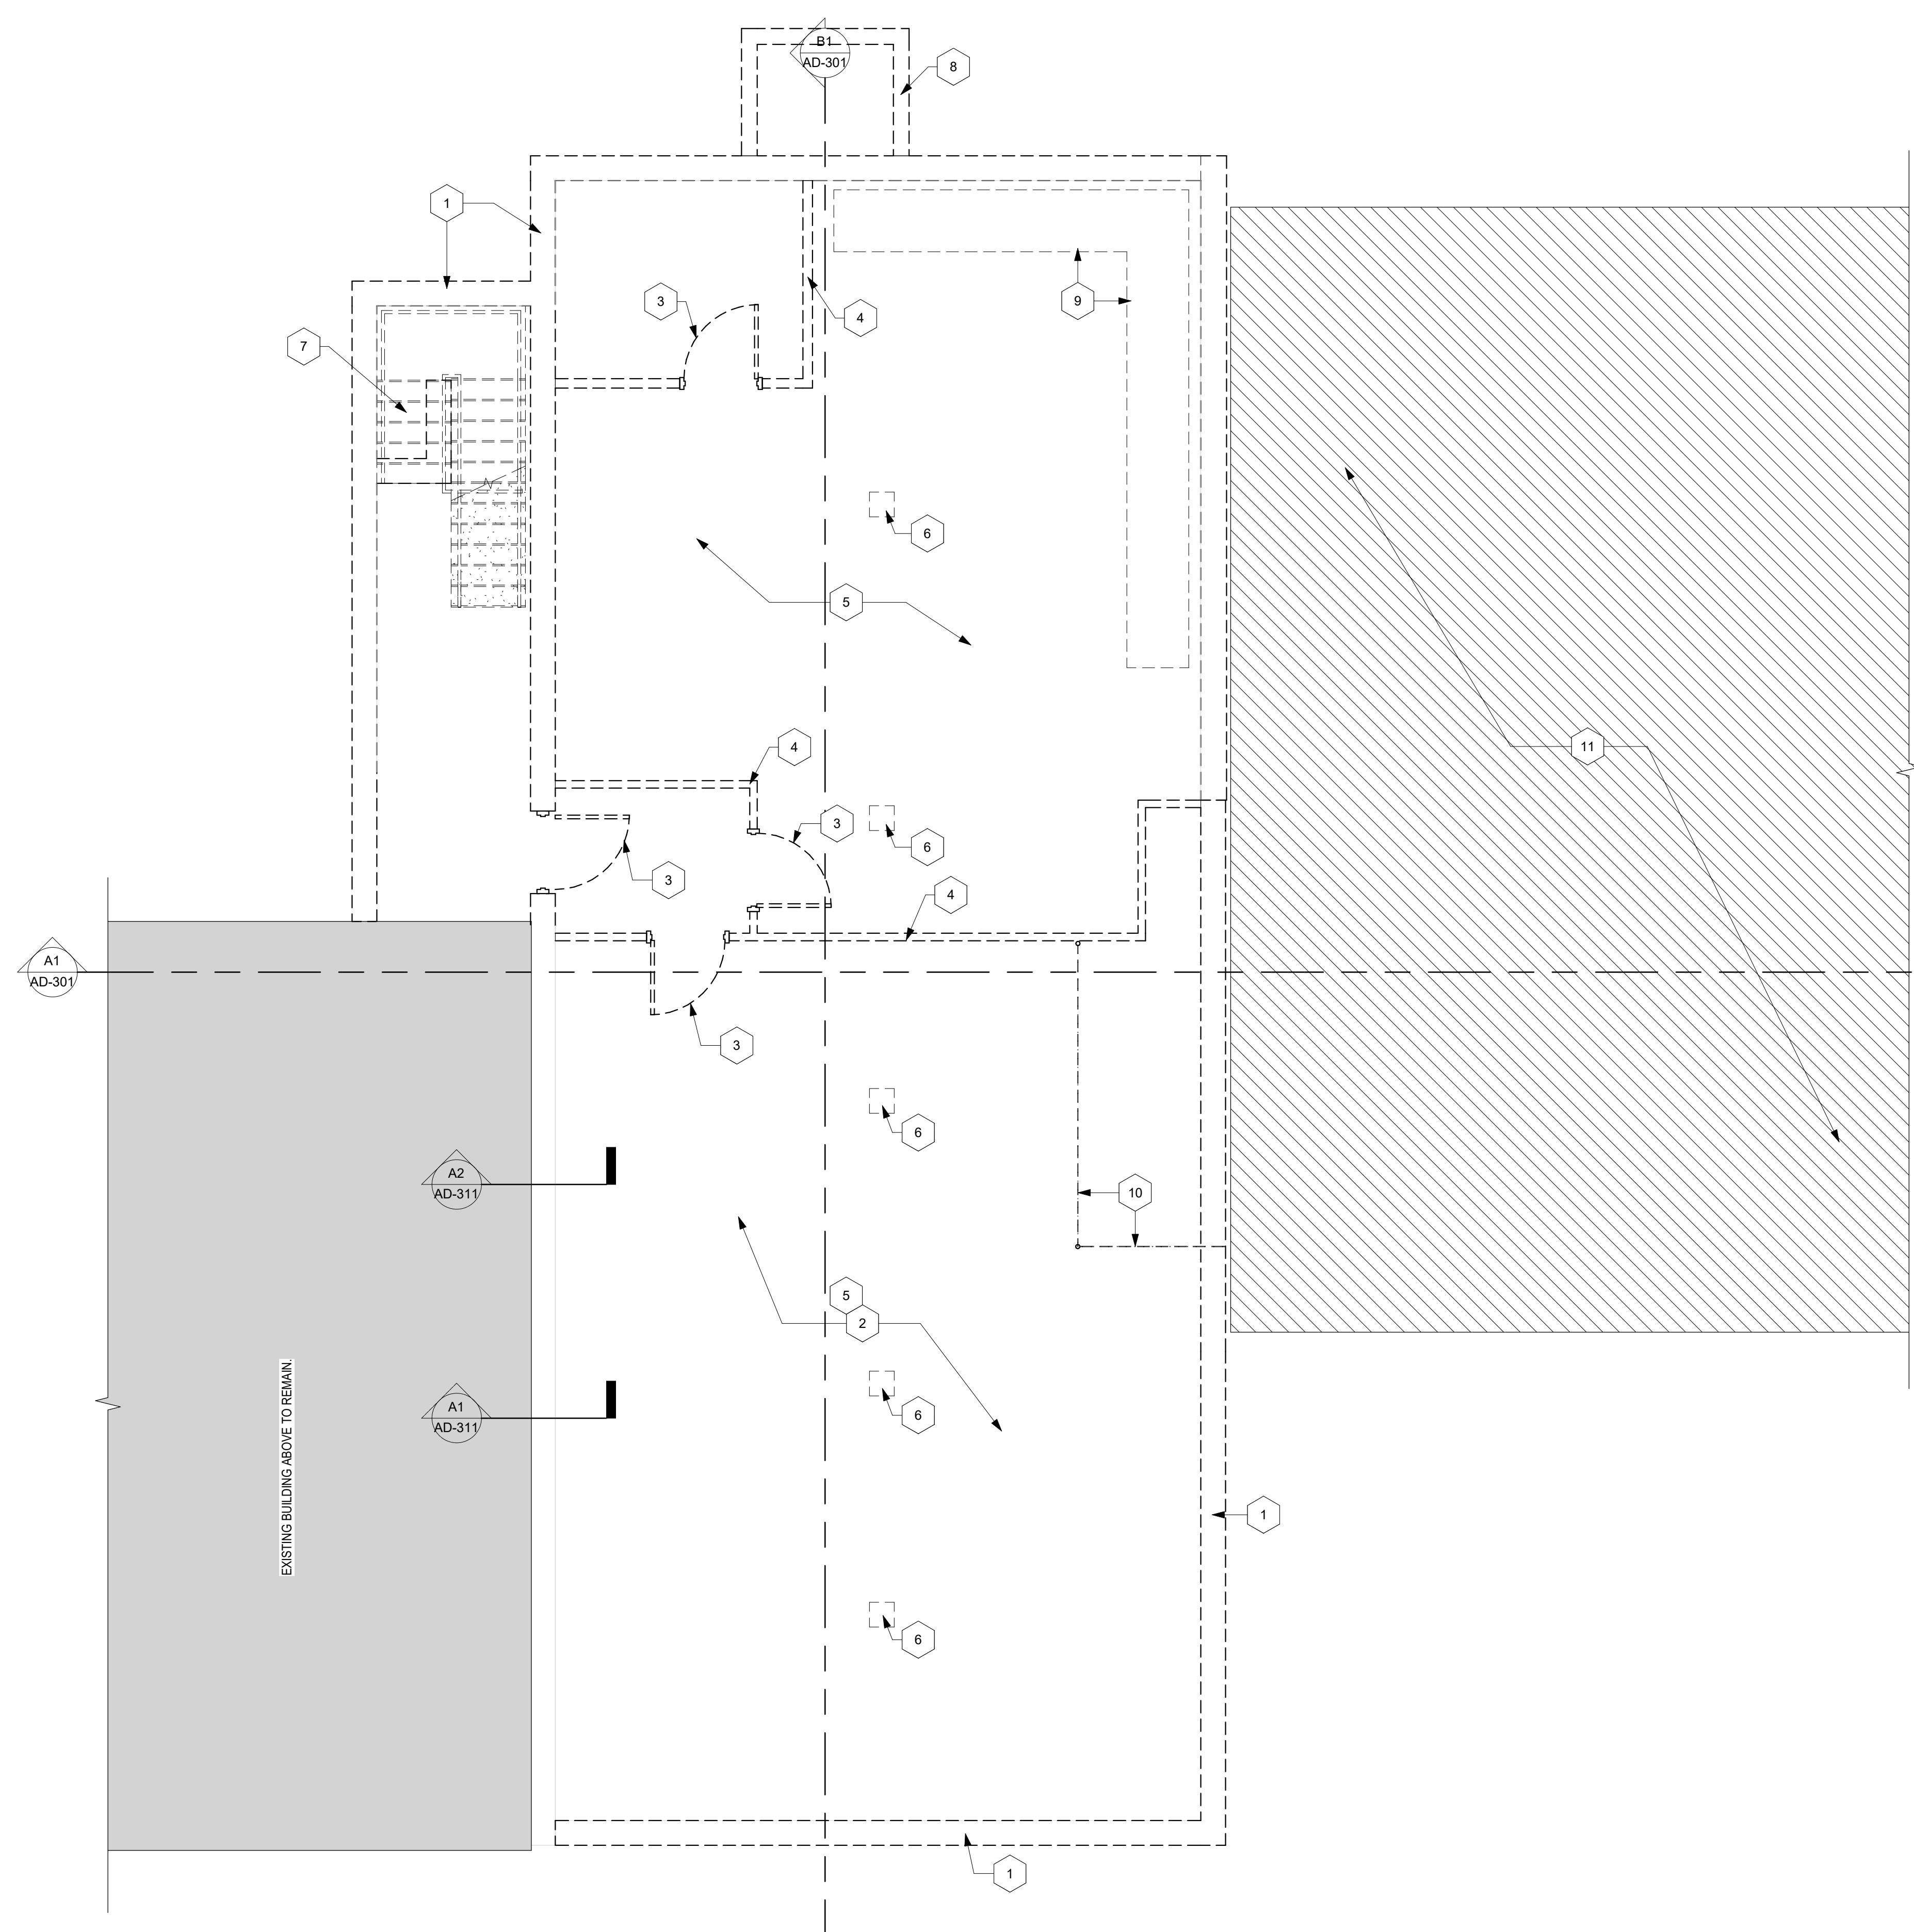
**AG MOD PHASE 3: NEALE HALL DEMO**  
**95% CONSTRUCTION DOCUMENTS**  
 3198 S. Espina St  
 Las Cruces, NM 88001  
 MARCH 12, 2024

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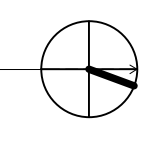
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 PROJECT NO: 773B  
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SHEET TITLE  
 DEMOLITION BASEMENT PLAN

AD-102

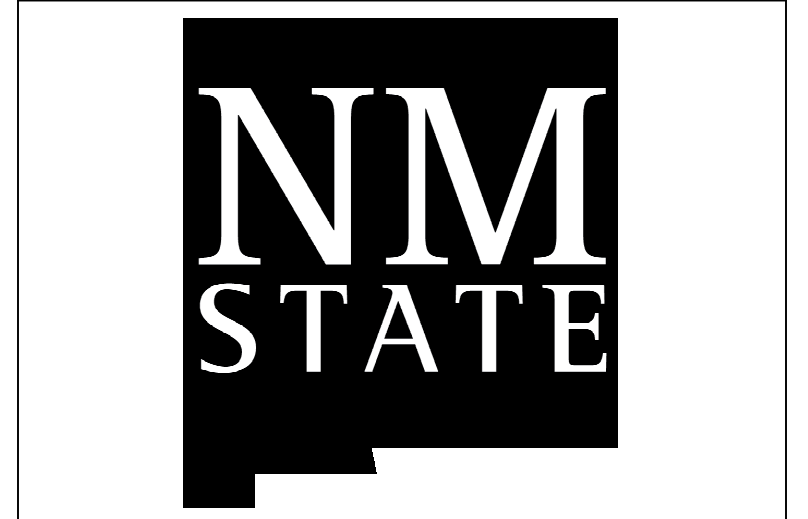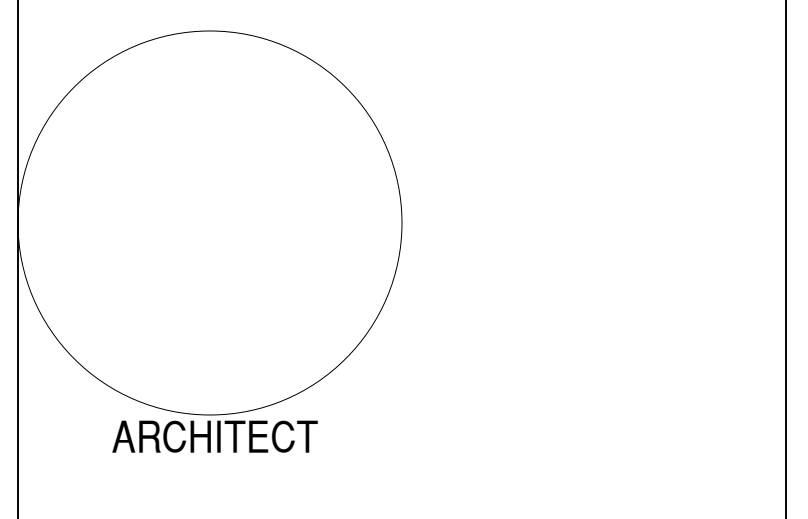

**A1** BASEMENT DEMOLITION PLAN  
 1/4" = 1'-0"



**STRUCTURAL DEMO NOTES**

- A. INSTALL TEMPORARY POST SHORES IN THE EXISTING BASEMENT PRIOR TO DEMOLITION OPERATIONS.
- B. SAWCUT ROOF JOISTS AND DECK AT EXISTING WALL TO REMAIN PRIOR TO REMOVAL OF THE EXISTING ROOF.
- C. SAWCUT MAIN LEVEL FLOOR SLAB AND FLOOR JOISTS AT REMAINING WALL SURFACE PRIOR TO REMOVAL.
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- F. BEGIN BACKFILL OPERATIONS TO BRING SITE TO GRADE. CONTRACTOR SHALL PROVIDE BACKFILL PLAN THAT DESCRIBES REMOVAL OF TEMPORARY BRACES AND REMAINING BASEMENT SLAB ON GRADE WHILE PREVENTING DEFLECTION OF REMAINING BASEMENT WALL.

**KEYED NOTES**

- 1. DEMOLISH THE TOP COURSES OF CMU WALL TO MATCH EXISTING WALL HEIGHT. PREP TO MATCH EXISTING PARAPET.
- 2. REPLACE ROOF MEMBRANE AS REQUIRED DUE TO DEMOLITION.
- 3. DEMOLISH EXISTING CANOPY AT LOADING DOCK.
- 4. DEMOLISH EXISTING ROOF IN THIS AREA.
- 5. MAINTAIN EXISTING CRICKET SLOPE.
- 6. SUPPORT ROOF STRUCTURE AT UNSUPPORTED AREAS DURING DEMOLITION. TYPICAL.
- 7. PROVIDE SUPPORTS UNDER GAS PIPING DURING DEMOLITION.
- 8. SALVAGE CLAY TILES AND PRECAST CONCRETE AT PARAPET AND USE FOR CONSTRUCTION OF NEW PARAPET. TYPICAL.

**GENERAL NOTES**

- A. CONTRACTOR SHALL TAKE ADEQUATE MEASURES TO PROTECT EXISTING FLOOR, WALL, CEILING FINISHES, AND EXISTING EQUIPMENT SCHEDULED TO REMAIN FROM DAMAGE. CONTRACTOR SHALL PREVENT THE ACCUMULATION OF DUST AND CONSTRUCTION DEBRIS. PROVIDE SECURE SEALS USING PLASTIC SHEETS OR OTHER SUITABLE BARRIERS TO PROTECT FINISHES AND EQUIPMENT. ANY DAMAGE TO SUCH ITEMS SHALL BE REPAIRED OR THE ITEM REPLACED BY THE CONTRACTOR AT NO COST TO THE OWNER. CONTRACTOR TO PROVIDE DOCUMENTATION AND INVENTORY OF ITEMS TO REMAIN/FINISH STATE PRIOR TO START OF DEMOLITION WORK.
- B. HOUSEKEEPING: THE CONTRACTOR SHALL WORK NEATLY, MAINTAINING ENTIRE EXISTING ARE TO BE REMODELED OR TO REMAIN SECURE AT ALL TIMES UNTIL COMPLETION OF NEW WORK. CONTRACTOR SHALL PROVIDE DAILY CLEANUP IN DEMOLITION AREA TO PREVENT DUST BUILD-UP AND THE ACCUMULATION OF CONSTRUCTION DEBRIS.
- C. CONTRACTOR SHALL COORDINATE ALL ASSOCIATED PLUMBING, MECHANICAL, AND ELECTRICAL DEMOLITION FOR THE PROJECT. SEE PLUMBING/MECHANICAL/ELECTRICAL DEMOLITION DRAWING.
- D. THIS DRAWING INDICATES THE INTENT OF DEMOLITION AT THE EXISTING BUILDING. THE CONTRACTOR IS ADVISED TO VISIT THE JOB SITE TO BECOME FAMILIAR WITH THE SCOPE OF WORK PRIOR TO BIDDING.
- E. THE CONTRACTOR SHALL CAREFULLY EXECUTE DEMOLITION/REMOVAL WORK IDENTIFIED HEREIN AND PERFORM ALL DEMOLITION ON THE SHORTEST TIME POSSIBLE. DEMOLISHED MATERIALS SHALL BE REMOVED FROM THE SITE IMMEDIATELY, AND DISPOSED OF LEGALLY.
- F. UTILITIES: LOCATE ALL EXISTING ACTIVE UTILITIES AND DETERMINE ALL REQUIREMENTS FOR DISCONNECTION, RECONNECTION, REROUTING OR CAPPING. CONTRACTOR SHALL PROTECT ALL UTILITIES DESIGNATED TO REMAIN FROM DAMAGE. CONTRACTOR SHALL NOTIFY AND COORDINATE ANY UTILITY INTERRUPTIONS WITH OWNER A MINIMUM OF 10 DAYS IN ADVANCE.
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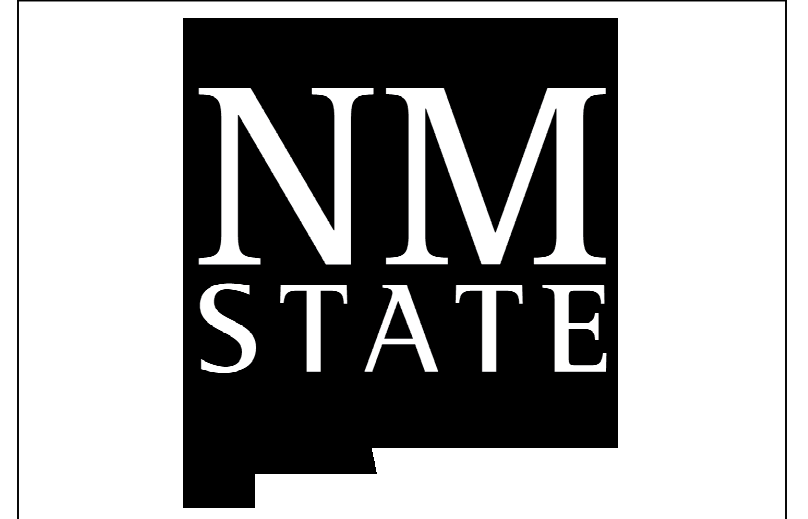
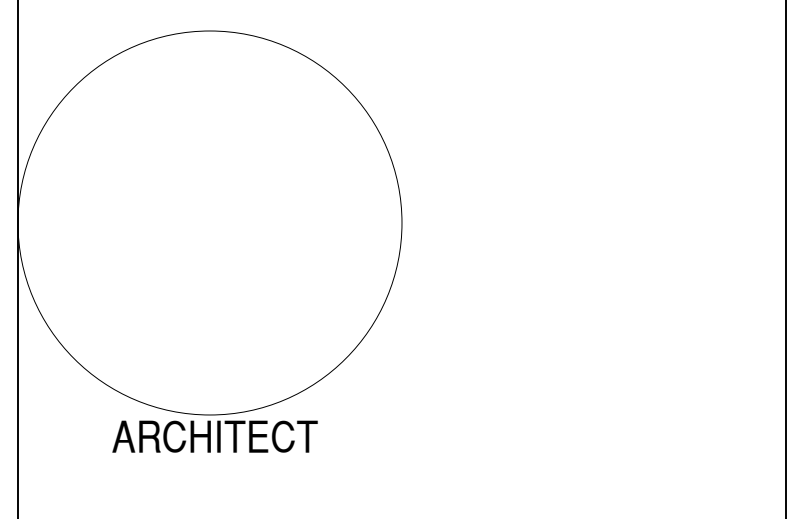


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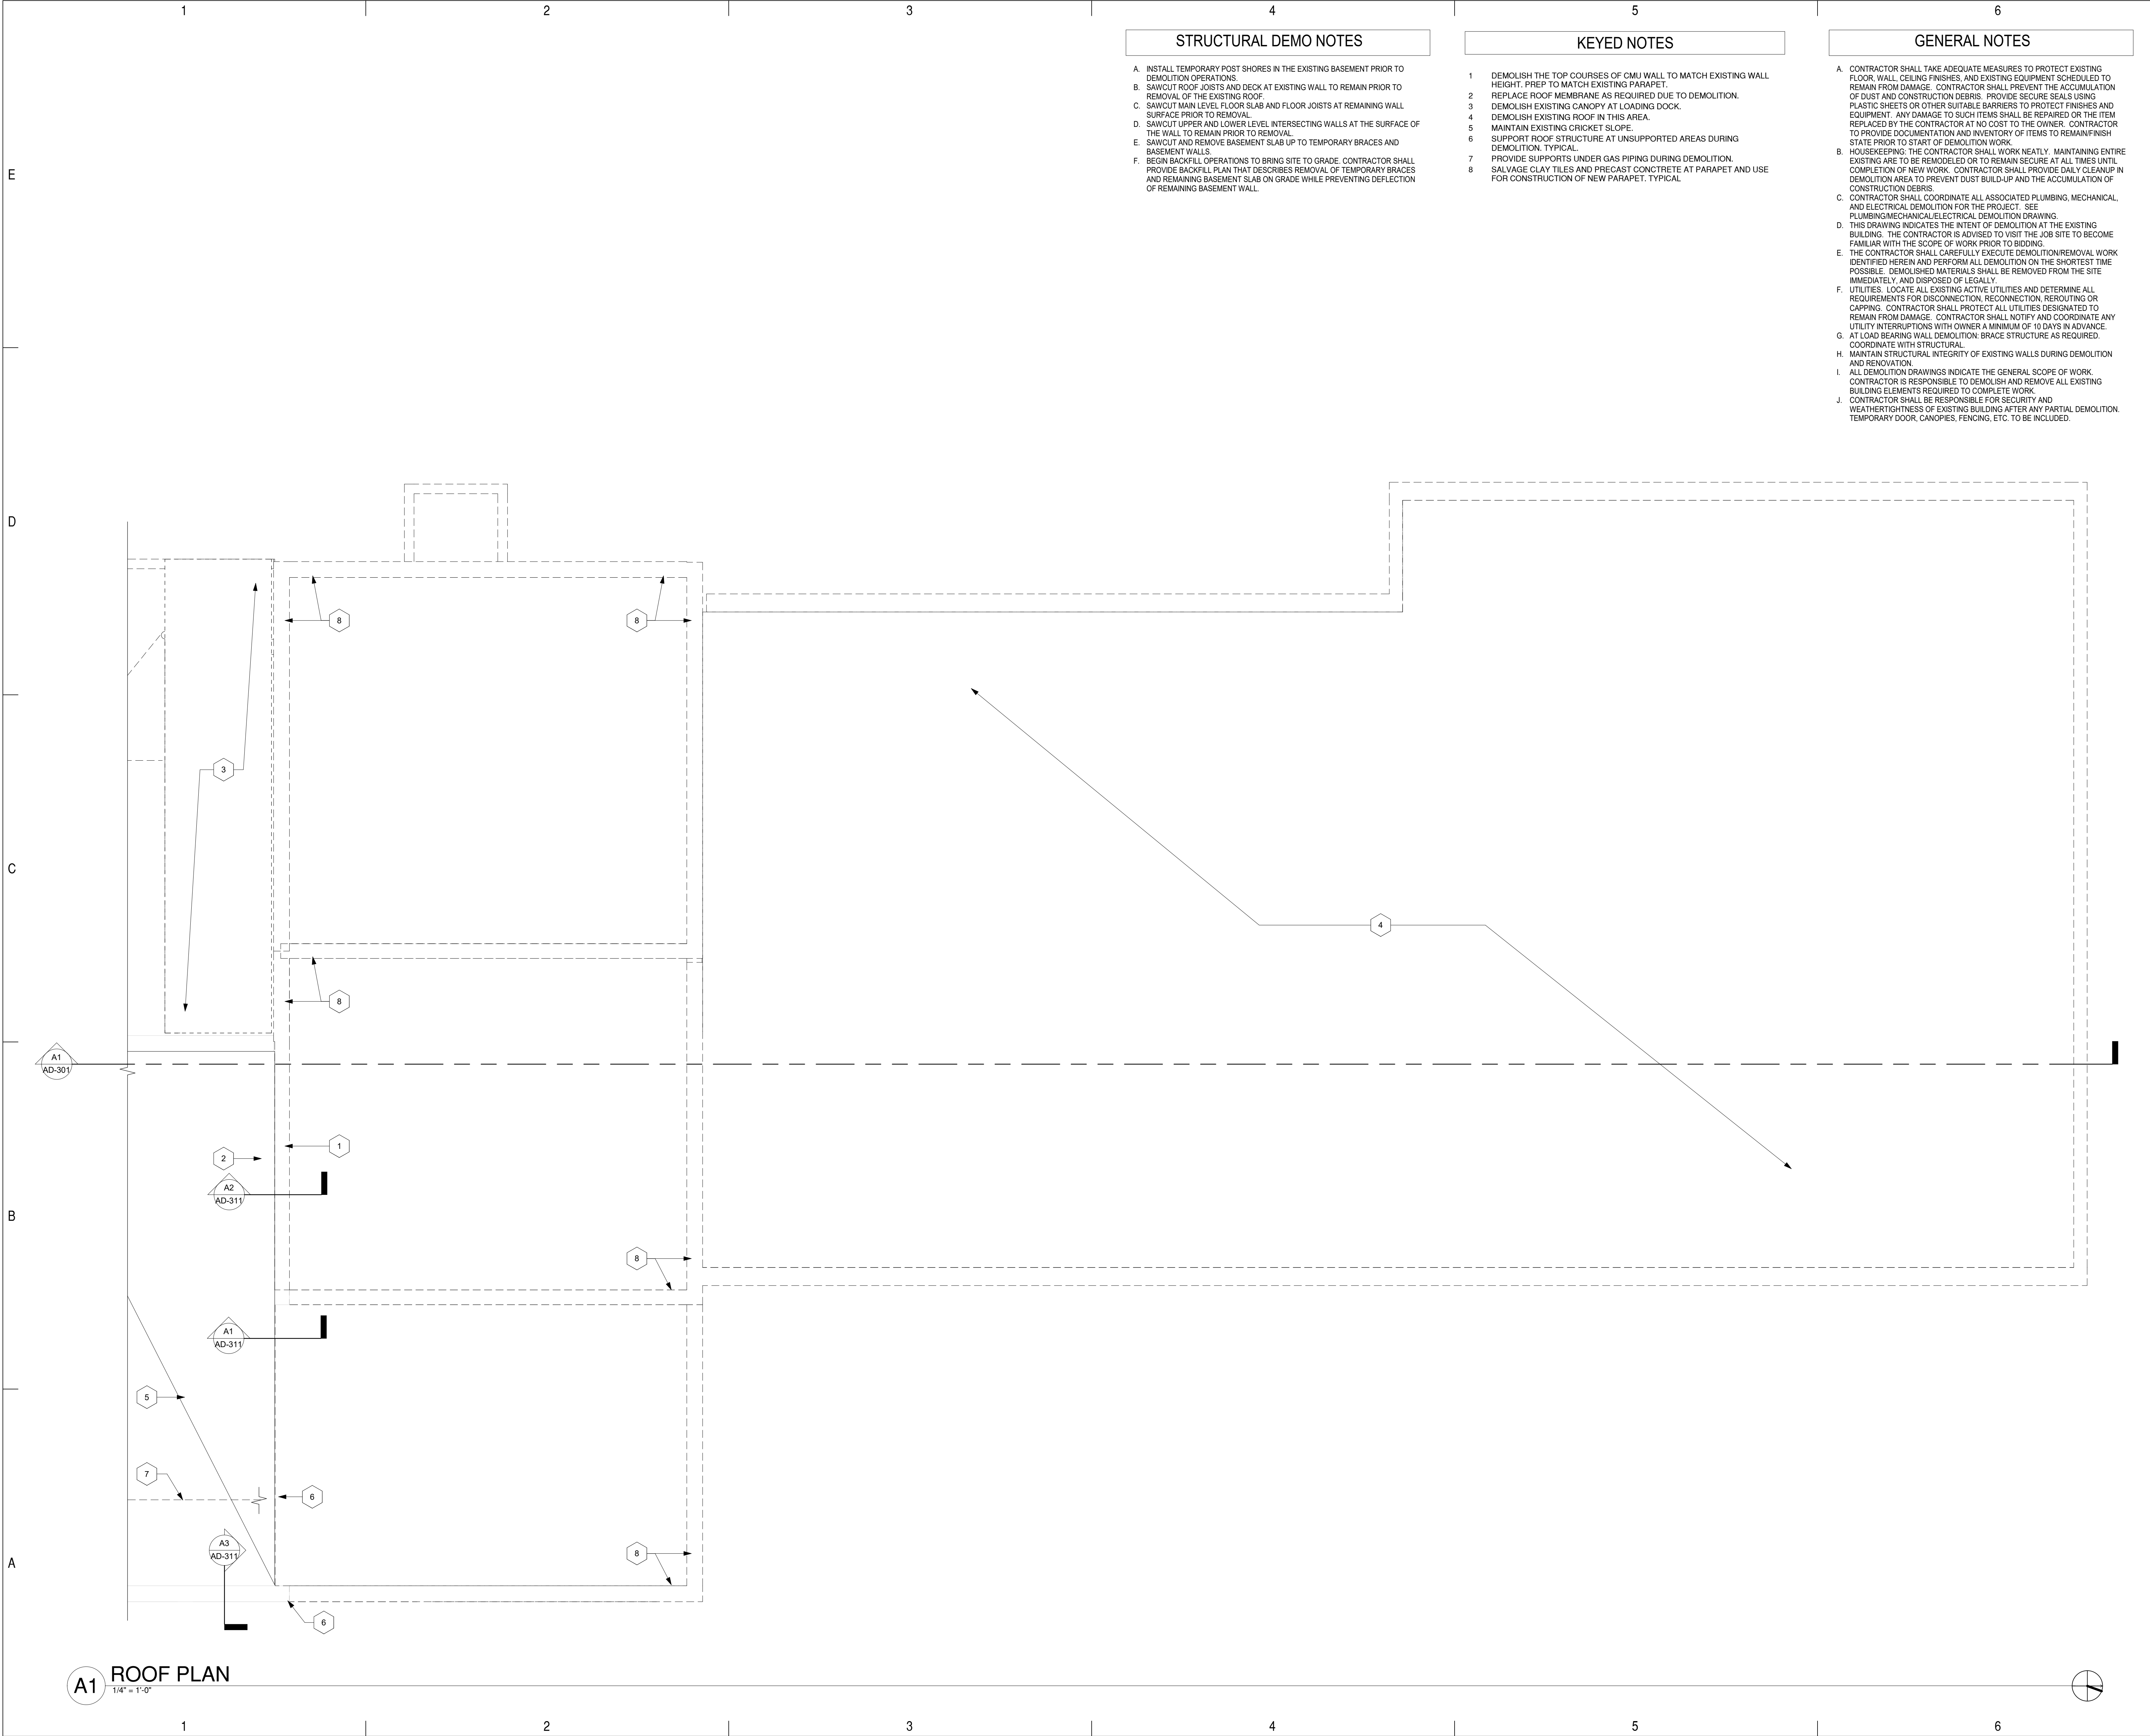
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SHEET TITLE  
 DEMO ROOF PLAN

**AD-131**



**A1** ROOF PLAN  
 1/4" = 1'-0"

STRUCTURAL DEMO NOTES

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KEYED NOTES

LEGEND

- EXISTING WALLS TO REMAIN
- - - EXISTING WALLS TO BE DEMOLISHED
- ▒ BUILDING DEMOLITION
- ▤ SITE DEMOLITION

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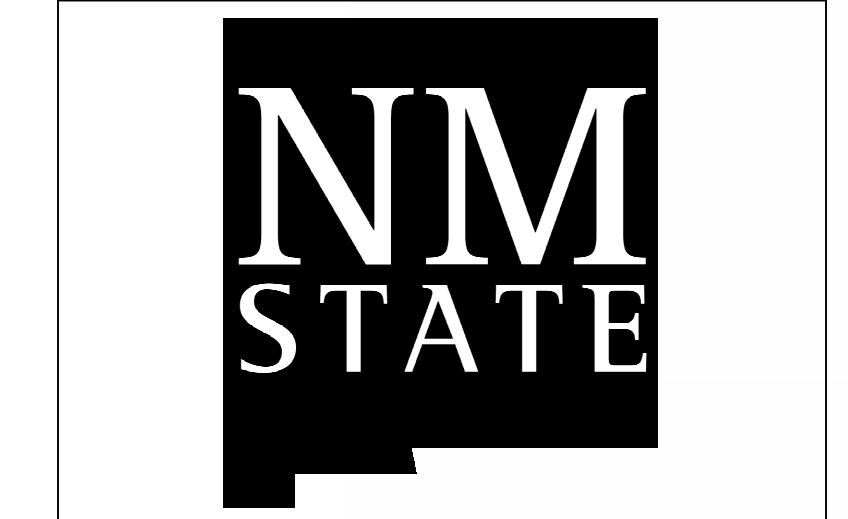
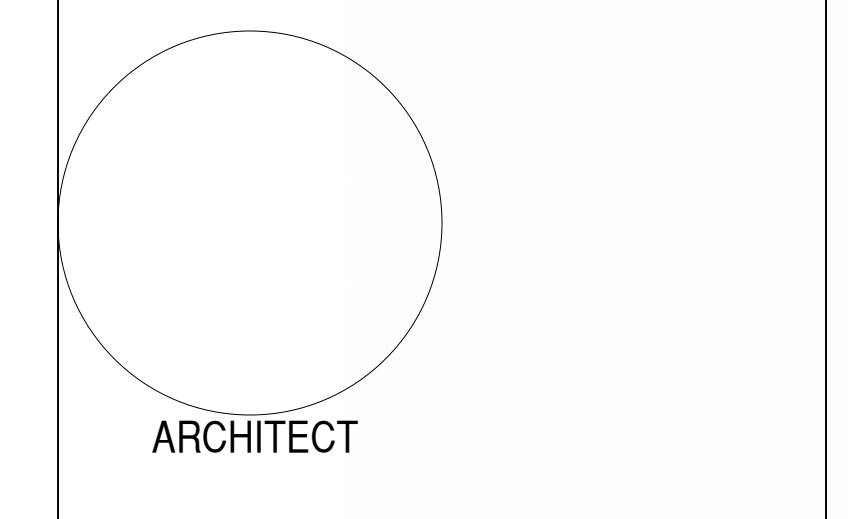
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**AG MOD PHASE 3: NEALE HALL DEMO**

**95% CONSTRUCTION DOCUMENTS**

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Las Cruces, NM 88001

MARCH 12, 2024

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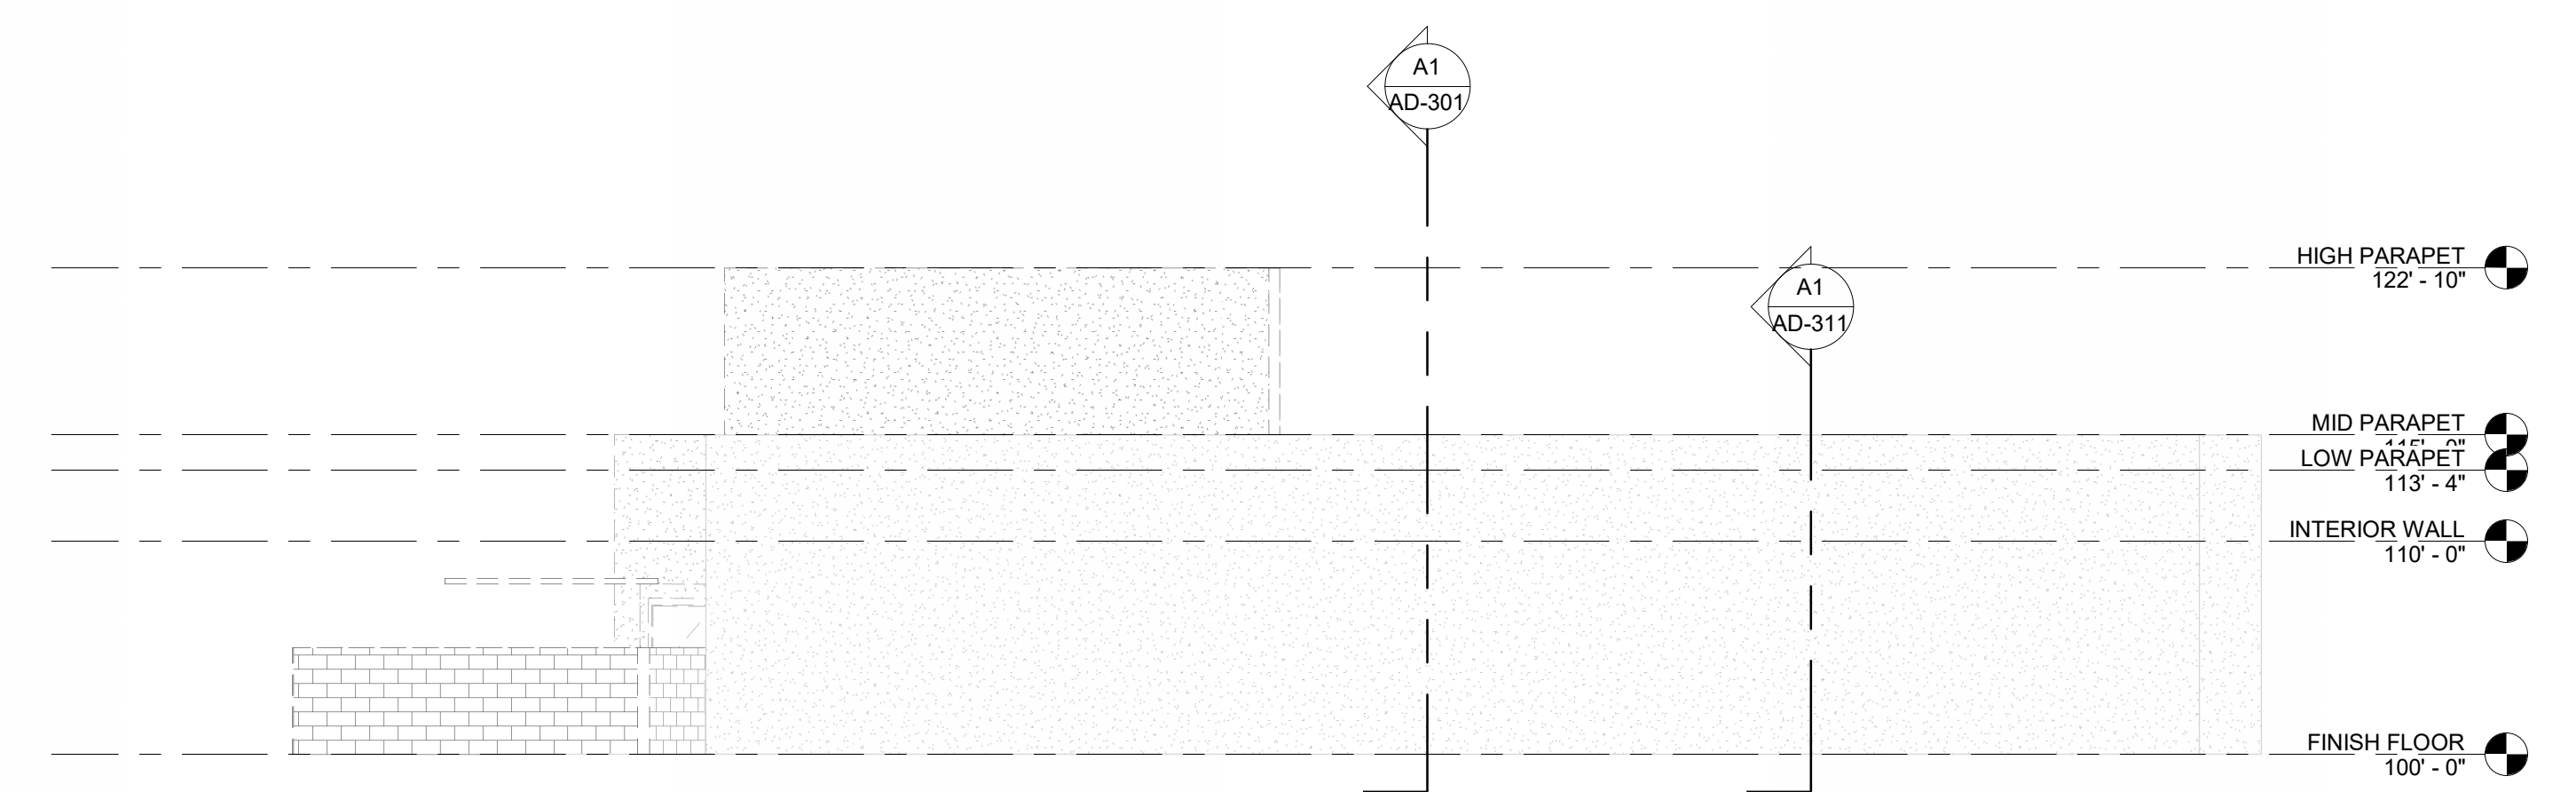
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SHEET TITLE  
DEMO BUILDING ELEVATIONS

AD-201


C1 DEMO ELEVATION - SOUTH

1/8" = 1'-0"




B1 ELEVATION - WEST

1/8" = 1'-0"

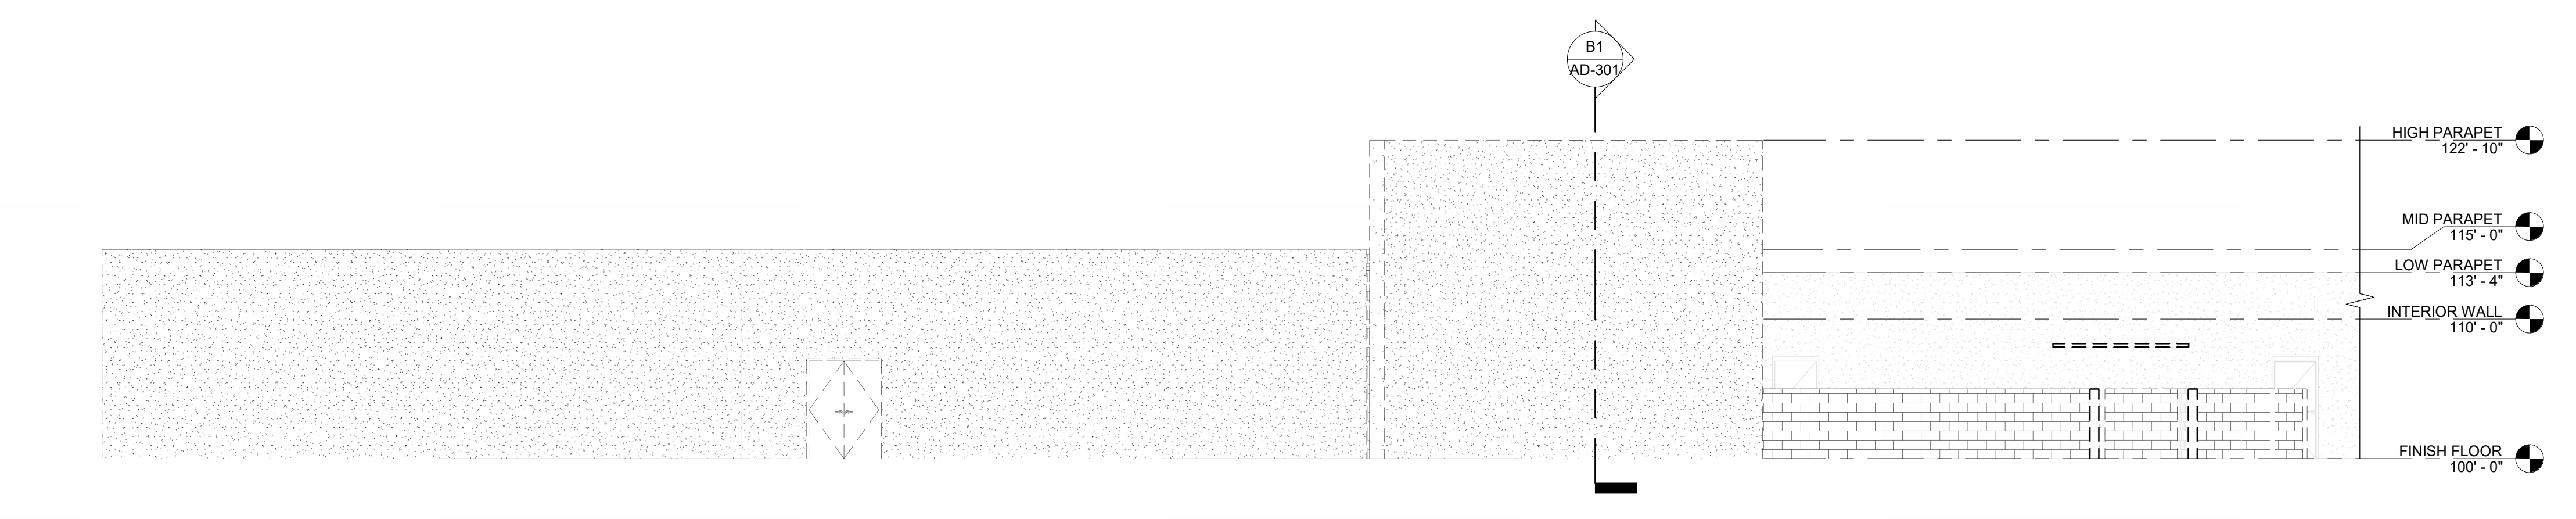

A1 DEMO ELEVATION - EAST

1/8" = 1'-0"

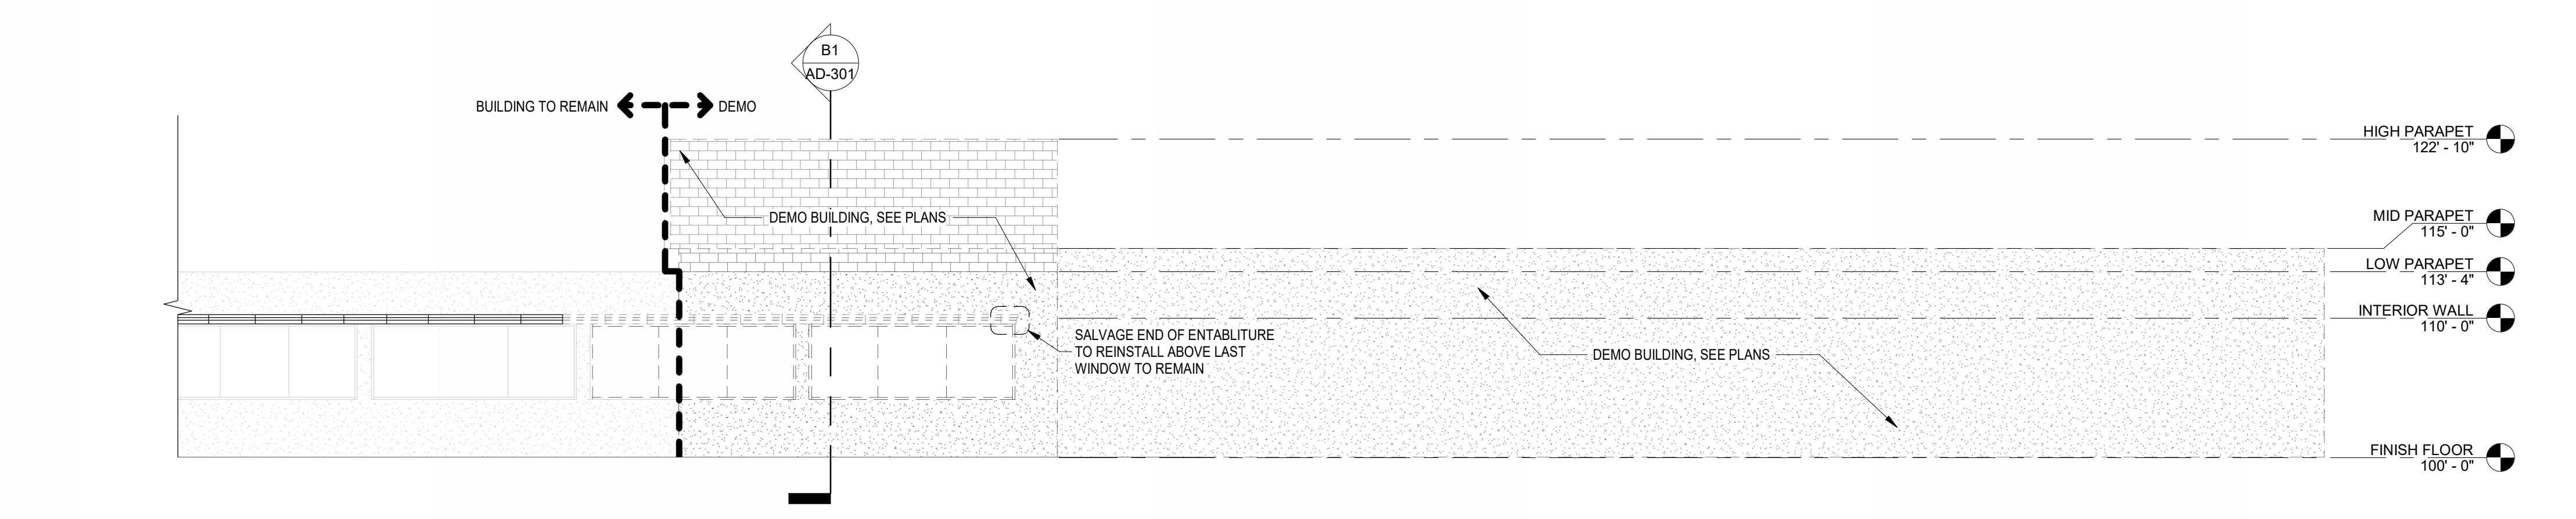

**STRUCTURAL DEMO NOTES**


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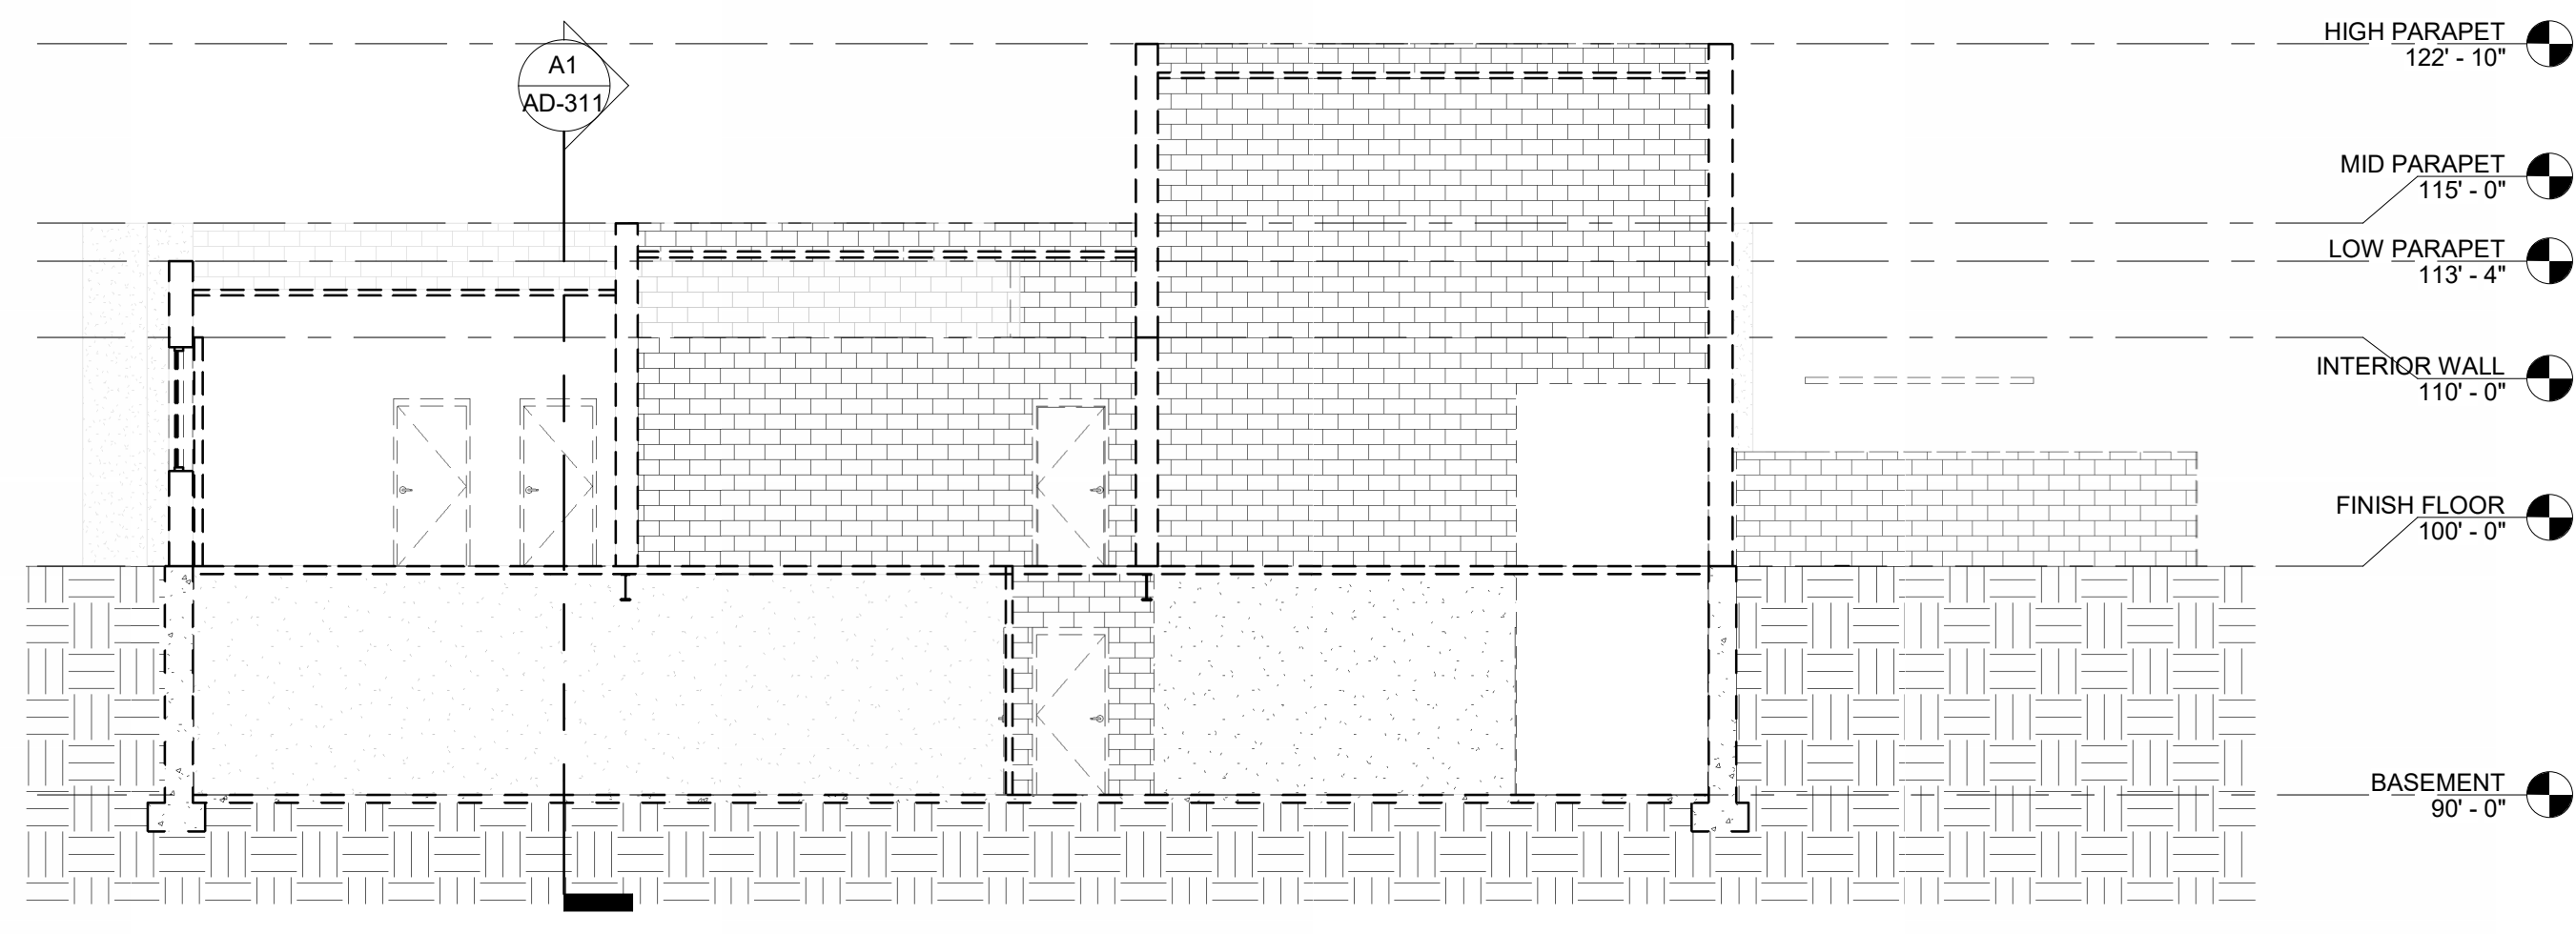
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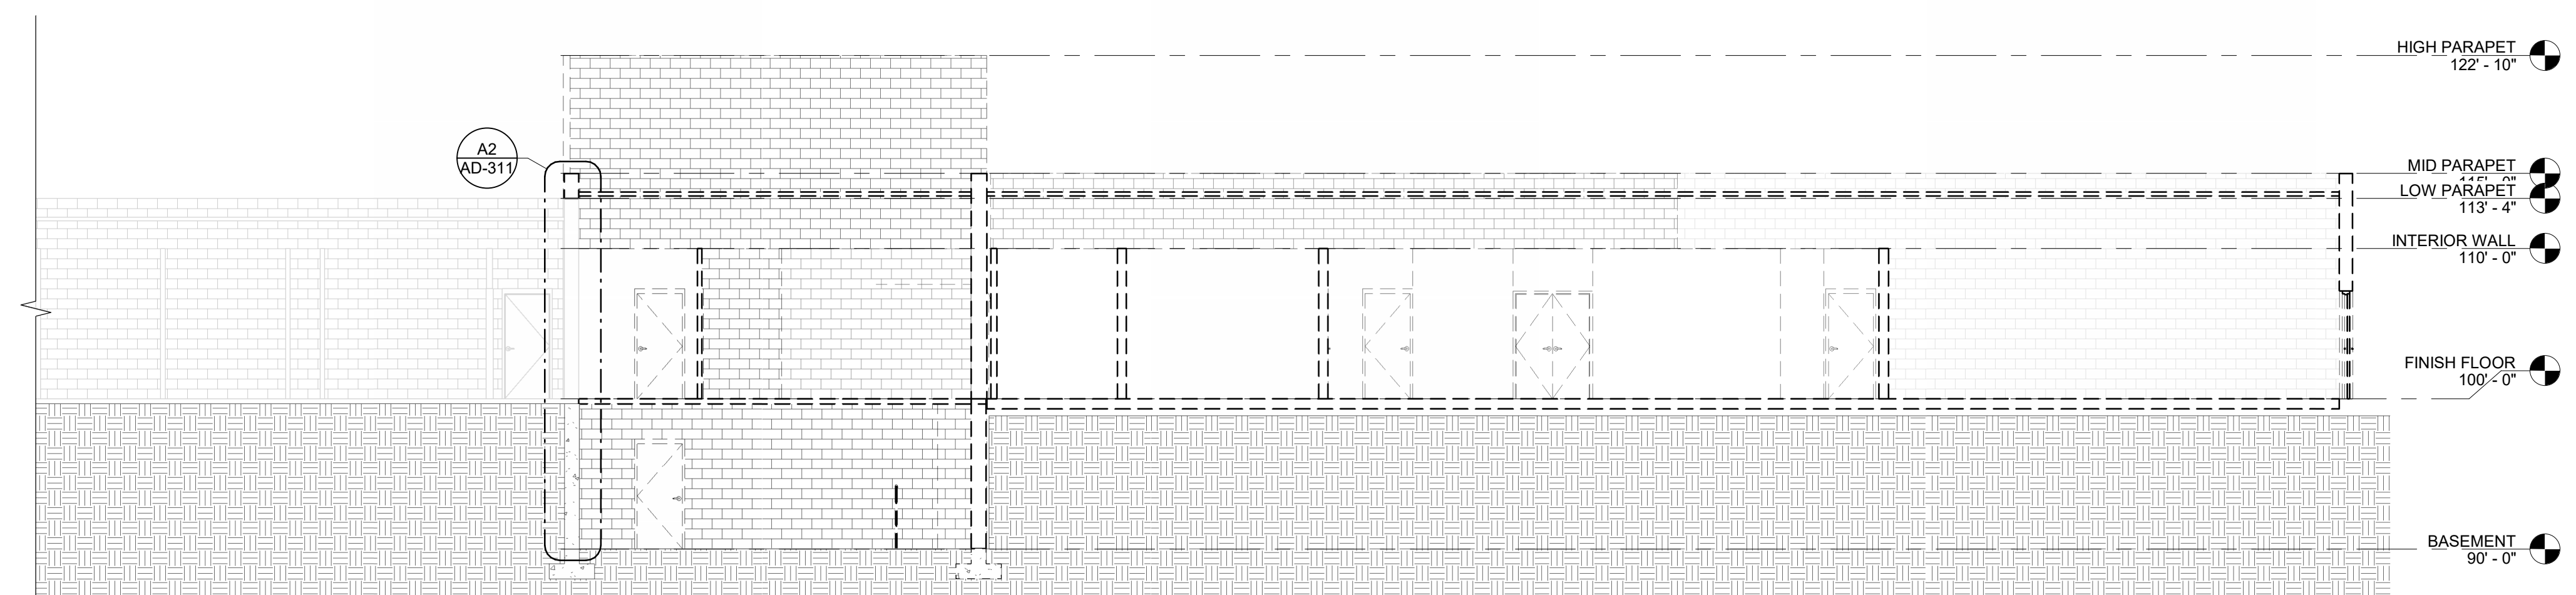
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SHEET TITLE  
 DEMO BUILDING SECTIONS

**AD-301**



**B1** DEMO SECTION LOOKING SOUTH  
 1/8" = 1'-0"

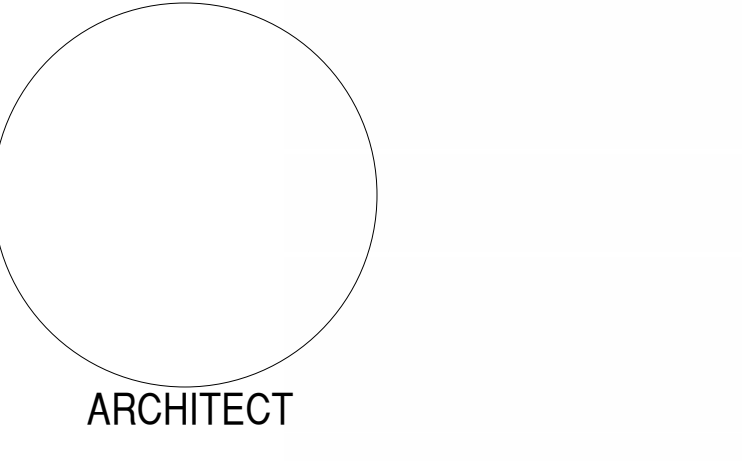

**A1** DEMO SECTION LOOKING WEST  
 1/8" = 1'-0"

**STRUCTURAL DEMO NOTES**

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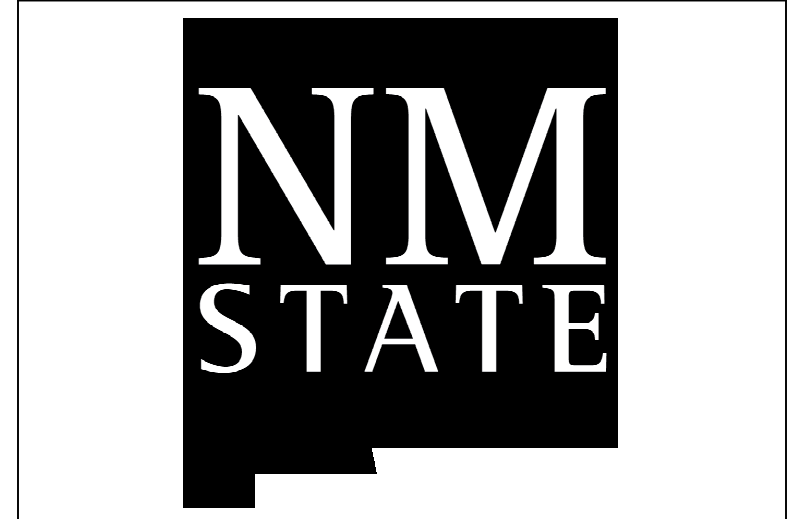
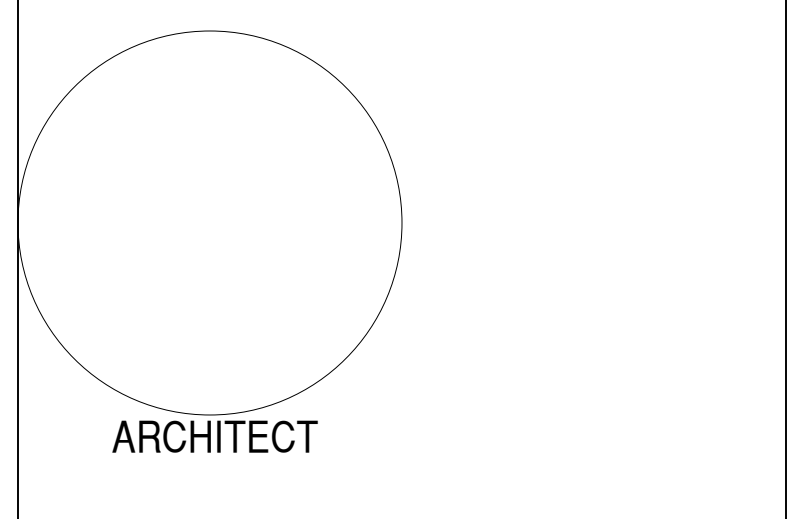
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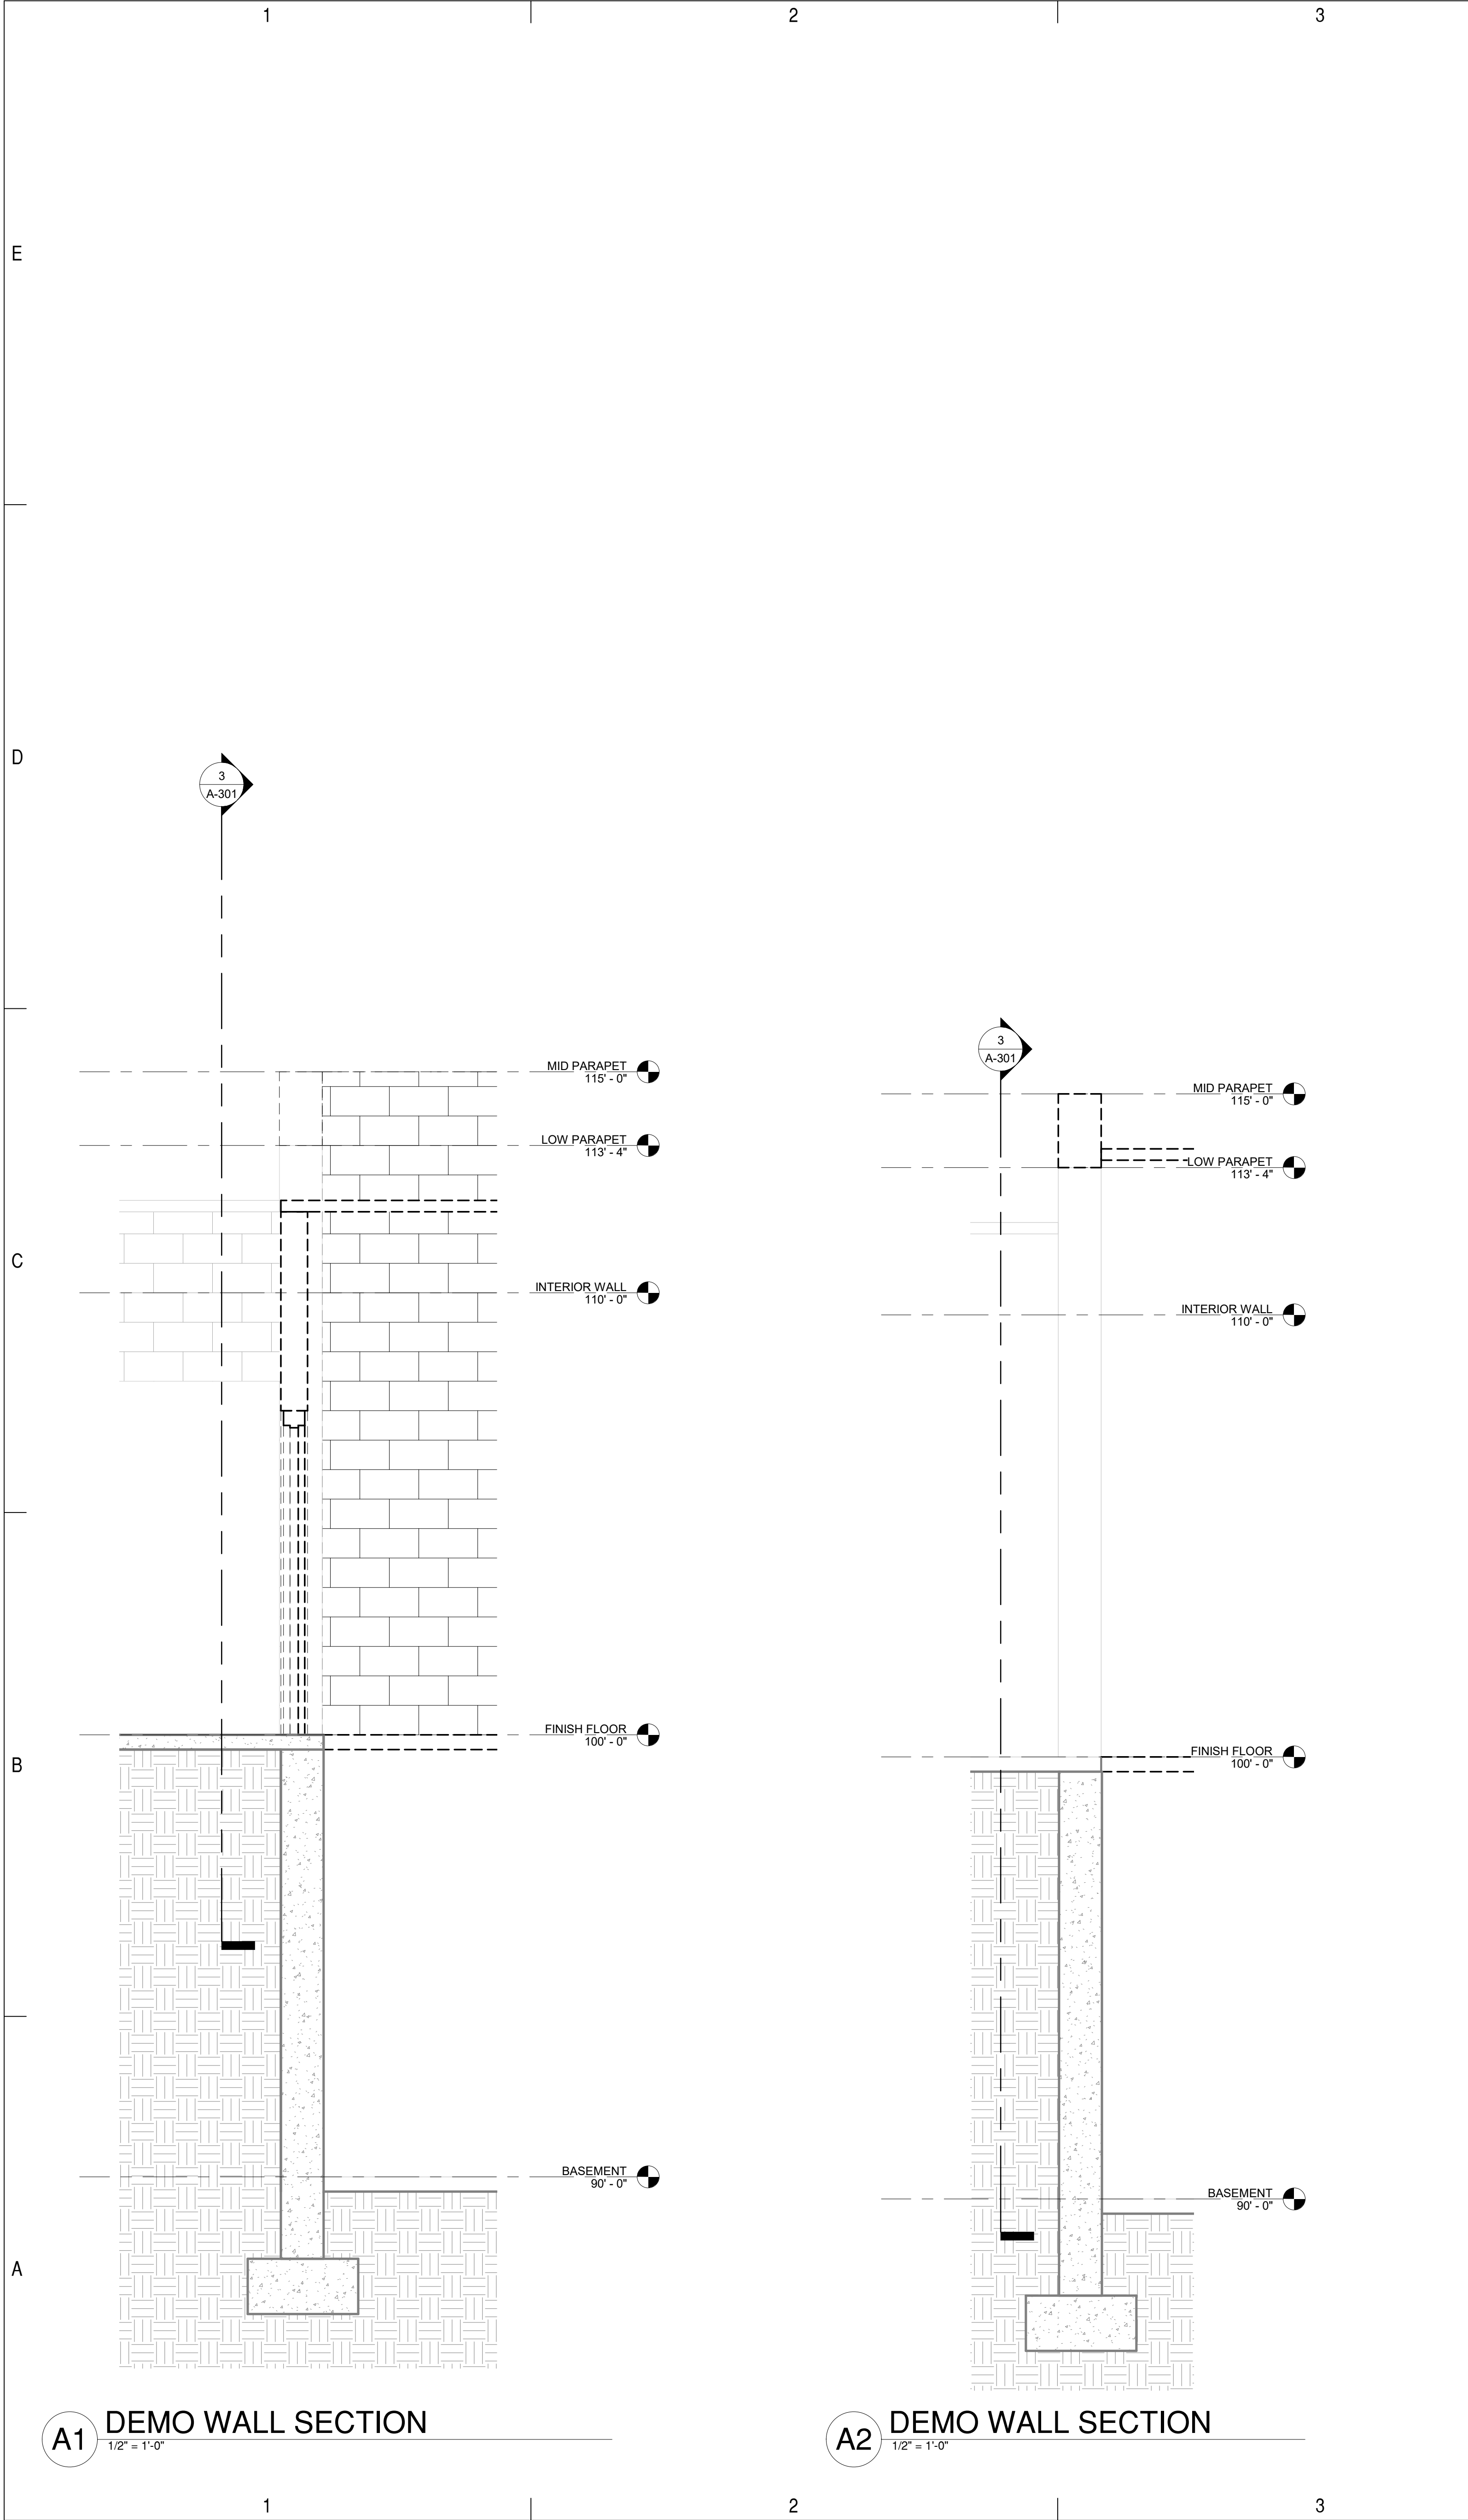
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SHEET TITLE  
 DEMO WALL SECTIONS

**AD-311**



**A1 DEMO WALL SECTION**  
 1/2" = 1'-0"

**A2 DEMO WALL SECTION**  
 1/2" = 1'-0"

**A3 DEMO WINDOW WALL SECTION**  
 1/2" = 1'-0"

AG MOD PHASE 3: NEALE HALL DEMO

3/14/2024 4:59:47 PM

- GENERAL NOTES**
- A. CONTRACTOR SHALL PERFORM DAILY CLEANUP WHEN FINISH GRADE WORK IS BEING PERFORMED.
  - B. SEE ENLARGED PLANS FOR CLASSROOM LAYOUTS, CASEWORK, ETC.
  - C. SEE ROOM MATERIALS LEGEND ON ID SHEETS FOR FLOOR/BASE/WALL AND CEILING MATERIAL INFORMATION.
  - D. PROVIDE WOOD BLOCKING IN ALL WALLS FOR SUPPORT OF PARTITIONS, SIGNAGE, ACCESSORIES, AND OTHER WALL SUPPORTED ITEMS AS REQUIRED.
  - E. SEE ANSI GUIDELINES FOR INFORMATION REGARDING ACCESSIBILITY REQUIREMENTS.
  - F. PROVIDE SEALANT AT INTERSECTIONS OF ALL DISSIMILAR MATERIALS.
  - G. COORDINATE ALL PLUMBING FIXTURES WITH THE PLUMBING DRAWINGS. IN CASE OF ANY DISCREPANCY, NOTIFY ARCHITECT AND ENGINEER PRIOR TO ROUGH-IN OF INSTALLATION.
  - H. PROVIDE WATER RESISTANT GYPSUM BOARD AT ALL WET LOCATIONS.
  - I. FURNISH AND INSTALL 5/8" ABUSE RESISTANT GYP. BOARD TO 8'-0" AFF AT ALL CORRIDOR AND VESTIBULE WALL LOCATIONS.
  - J. SEE A-601 FOR DOOR AND WINDOW SCHEDULE AND A-602/603 FOR DOOR AND WINDOW FRAME ELEVATIONS.
  - K. SEE PARTITION TYPES A-501.
  - L. SEAL ALL EXISTING PENETRATIONS, HOLES OR OTHER UNUSED DAMAGED EXISTING INTERIOR OR EXTERIOR WALL ASSEMBLIES.

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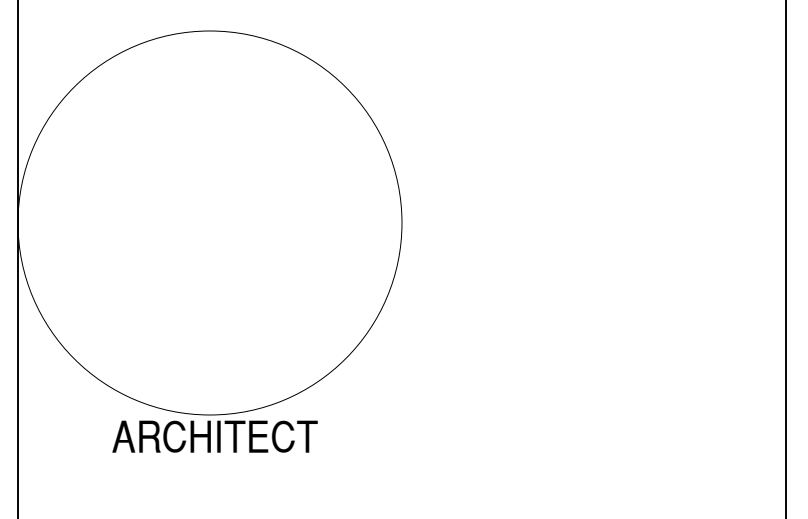
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**A1 FLOOR PLAN**  
1/4" = 1'-0"



**AG MOD PHASE 3: NEALE HALL DEMO**

**95% CONSTRUCTION DOCUMENTS**

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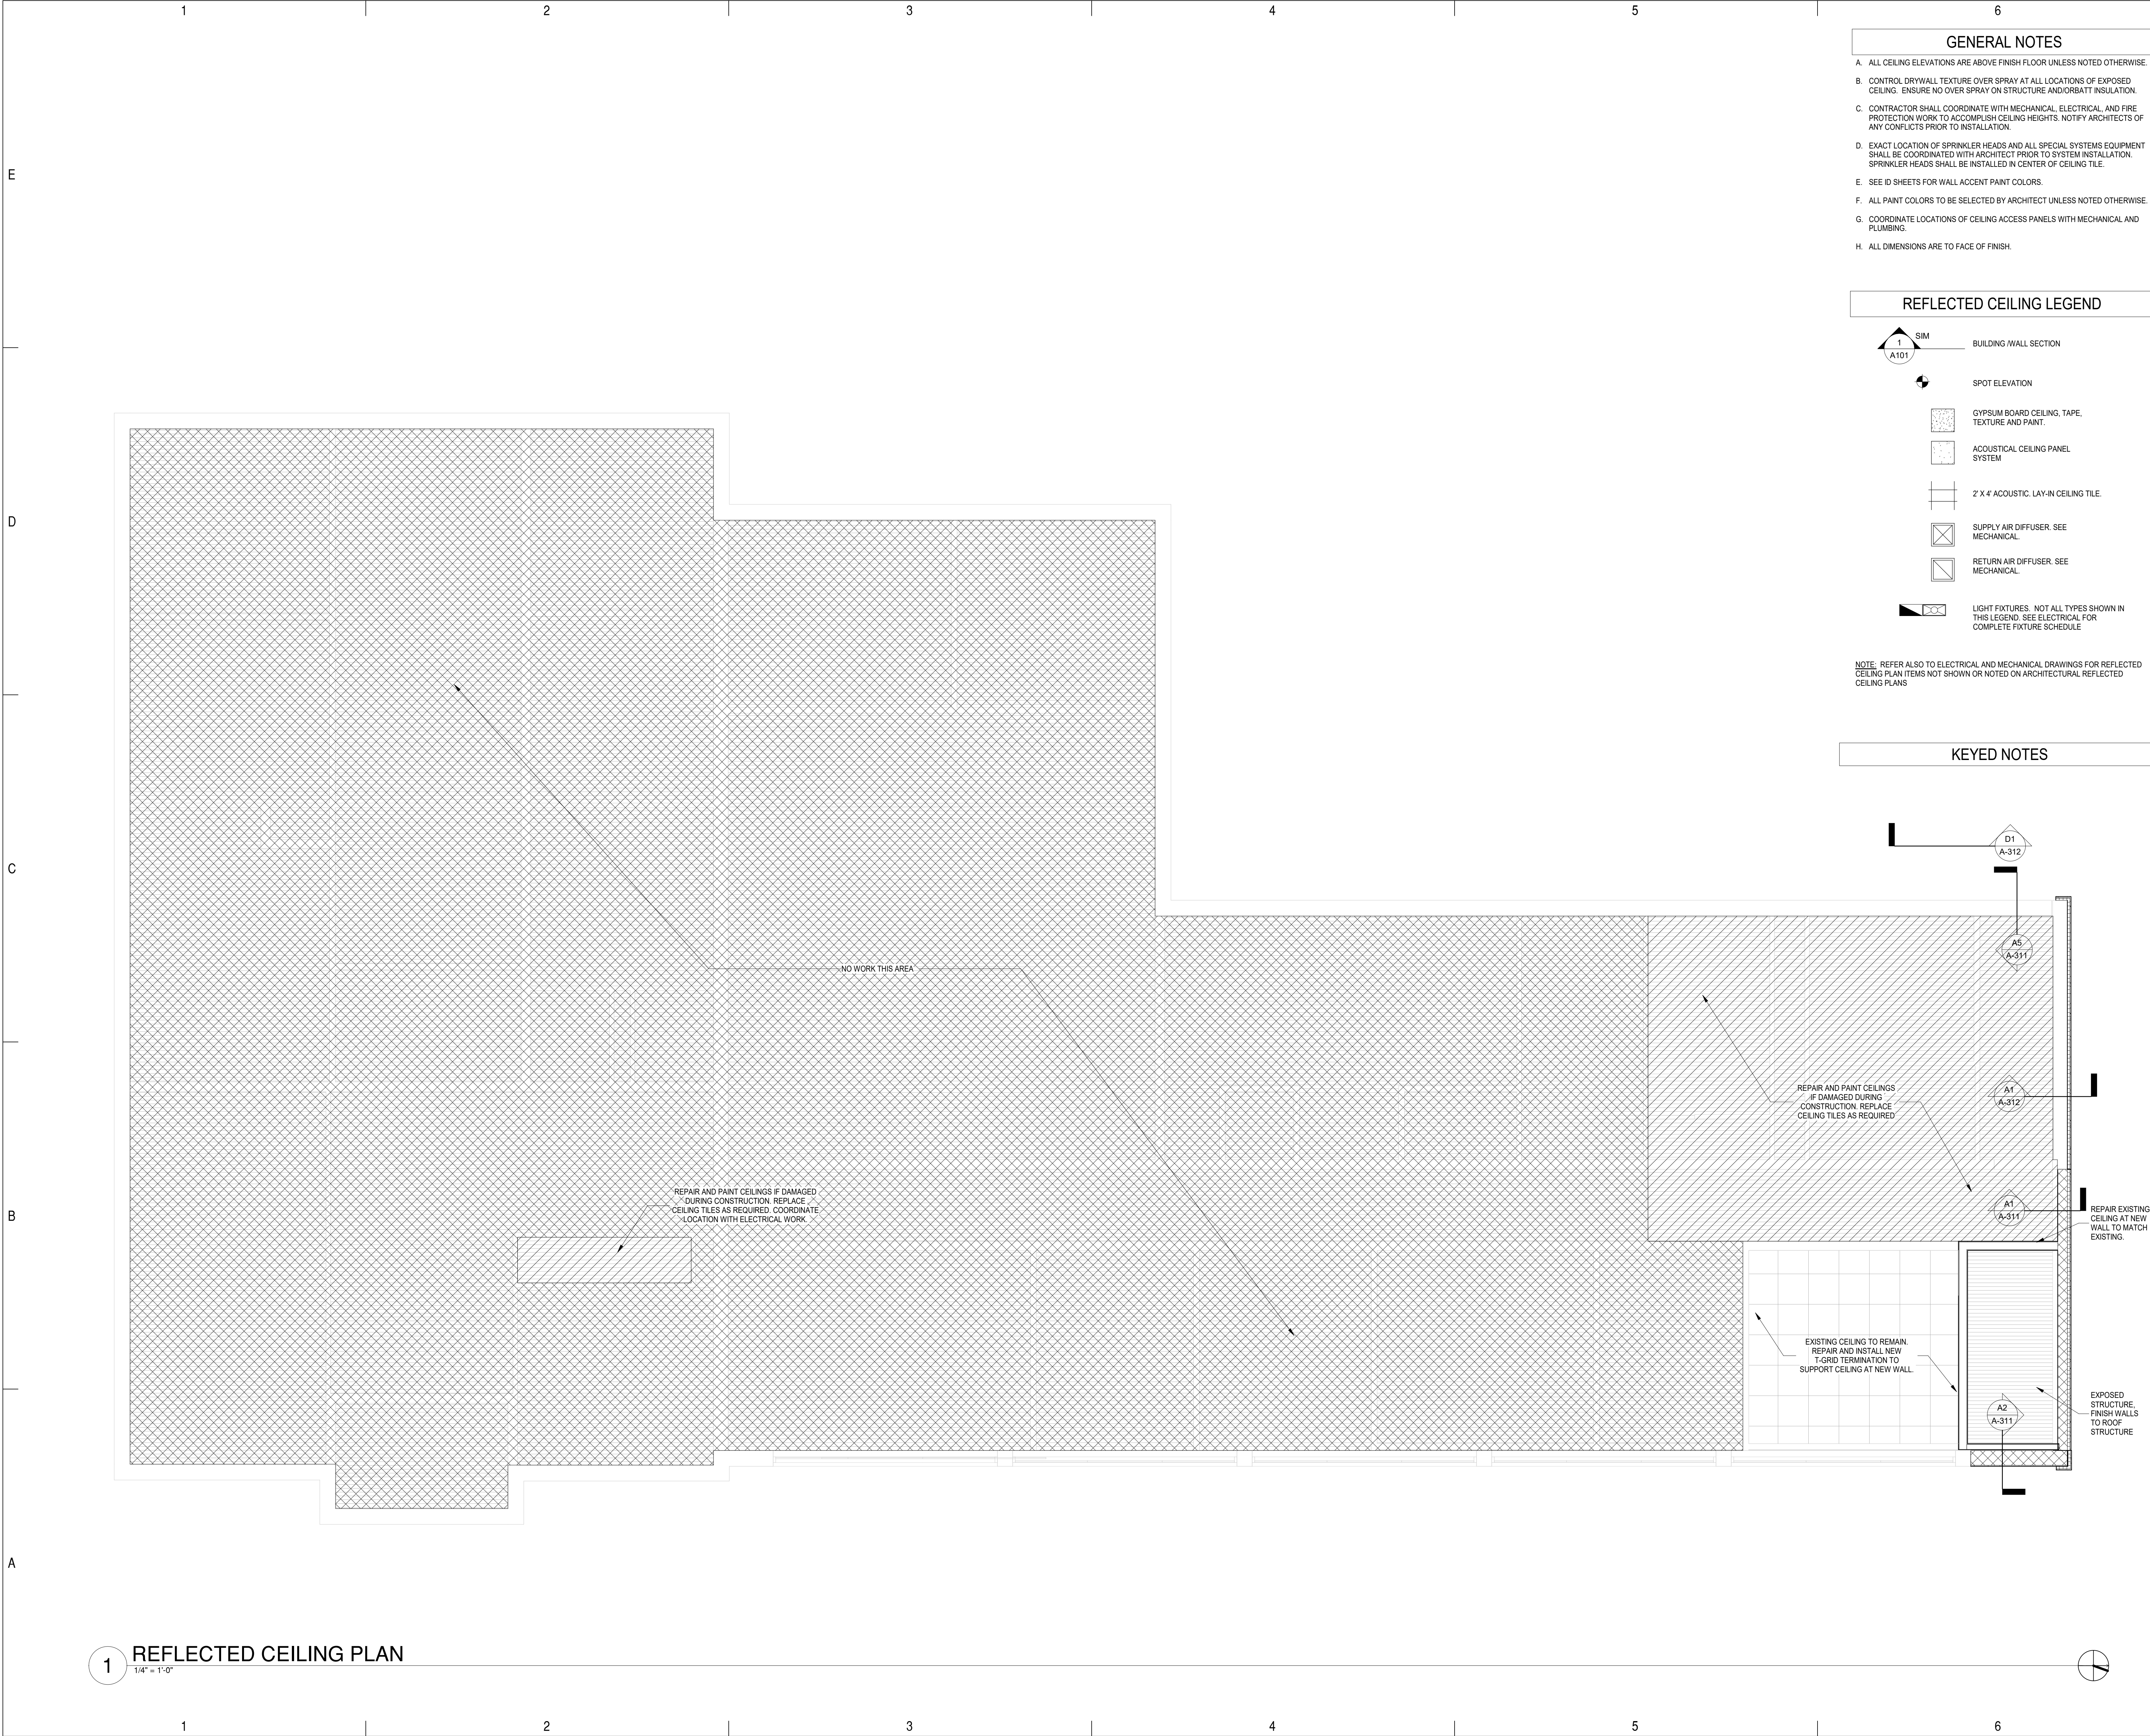
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SHEET TITLE  
FLOOR PLAN

**A-101**

School Information



- GENERAL NOTES**
- A. ALL CEILING ELEVATIONS ARE ABOVE FINISH FLOOR UNLESS NOTED OTHERWISE.
  - B. CONTROL DRYWALL TEXTURE OVER SPRAY AT ALL LOCATIONS OF EXPOSED CEILING. ENSURE NO OVER SPRAY ON STRUCTURE AND/OR BATT INSULATION.
  - C. CONTRACTOR SHALL COORDINATE WITH MECHANICAL, ELECTRICAL, AND FIRE PROTECTION WORK TO ACCOMPLISH CEILING HEIGHTS. NOTIFY ARCHITECTS OF ANY CONFLICTS PRIOR TO INSTALLATION.
  - D. EXACT LOCATION OF SPRINKLER HEADS AND ALL SPECIAL SYSTEMS EQUIPMENT SHALL BE COORDINATED WITH ARCHITECT PRIOR TO SYSTEM INSTALLATION. SPRINKLER HEADS SHALL BE INSTALLED IN CENTER OF CEILING TILE.
  - E. SEE ID SHEETS FOR WALL ACCENT PAINT COLORS.
  - F. ALL PAINT COLORS TO BE SELECTED BY ARCHITECT UNLESS NOTED OTHERWISE.
  - G. COORDINATE LOCATIONS OF CEILING ACCESS PANELS WITH MECHANICAL AND PLUMBING.
  - H. ALL DIMENSIONS ARE TO FACE OF FINISH.

- REFLECTED CEILING LEGEND**
- BUILDING/WALL SECTION
  - SPOT ELEVATION
  - GYPSUM BOARD CEILING, TAPE, TEXTURE AND PAINT
  - ACOUSTICAL CEILING PANEL SYSTEM
  - 2 X 4 ACOUSTIC LAY-IN CEILING TILE
  - SUPPLY AIR DIFFUSER. SEE MECHANICAL
  - RETURN AIR DIFFUSER. SEE MECHANICAL
  - LIGHT FIXTURES. NOT ALL TYPES SHOWN IN THIS LEGEND. SEE ELECTRICAL FOR COMPLETE FIXTURE SCHEDULE

NOTE: REFER ALSO TO ELECTRICAL AND MECHANICAL DRAWINGS FOR REFLECTED CEILING PLAN ITEMS NOT SHOWN OR NOTED ON ARCHITECTURAL REFLECTED CEILING PLANS



**KEYED NOTES**

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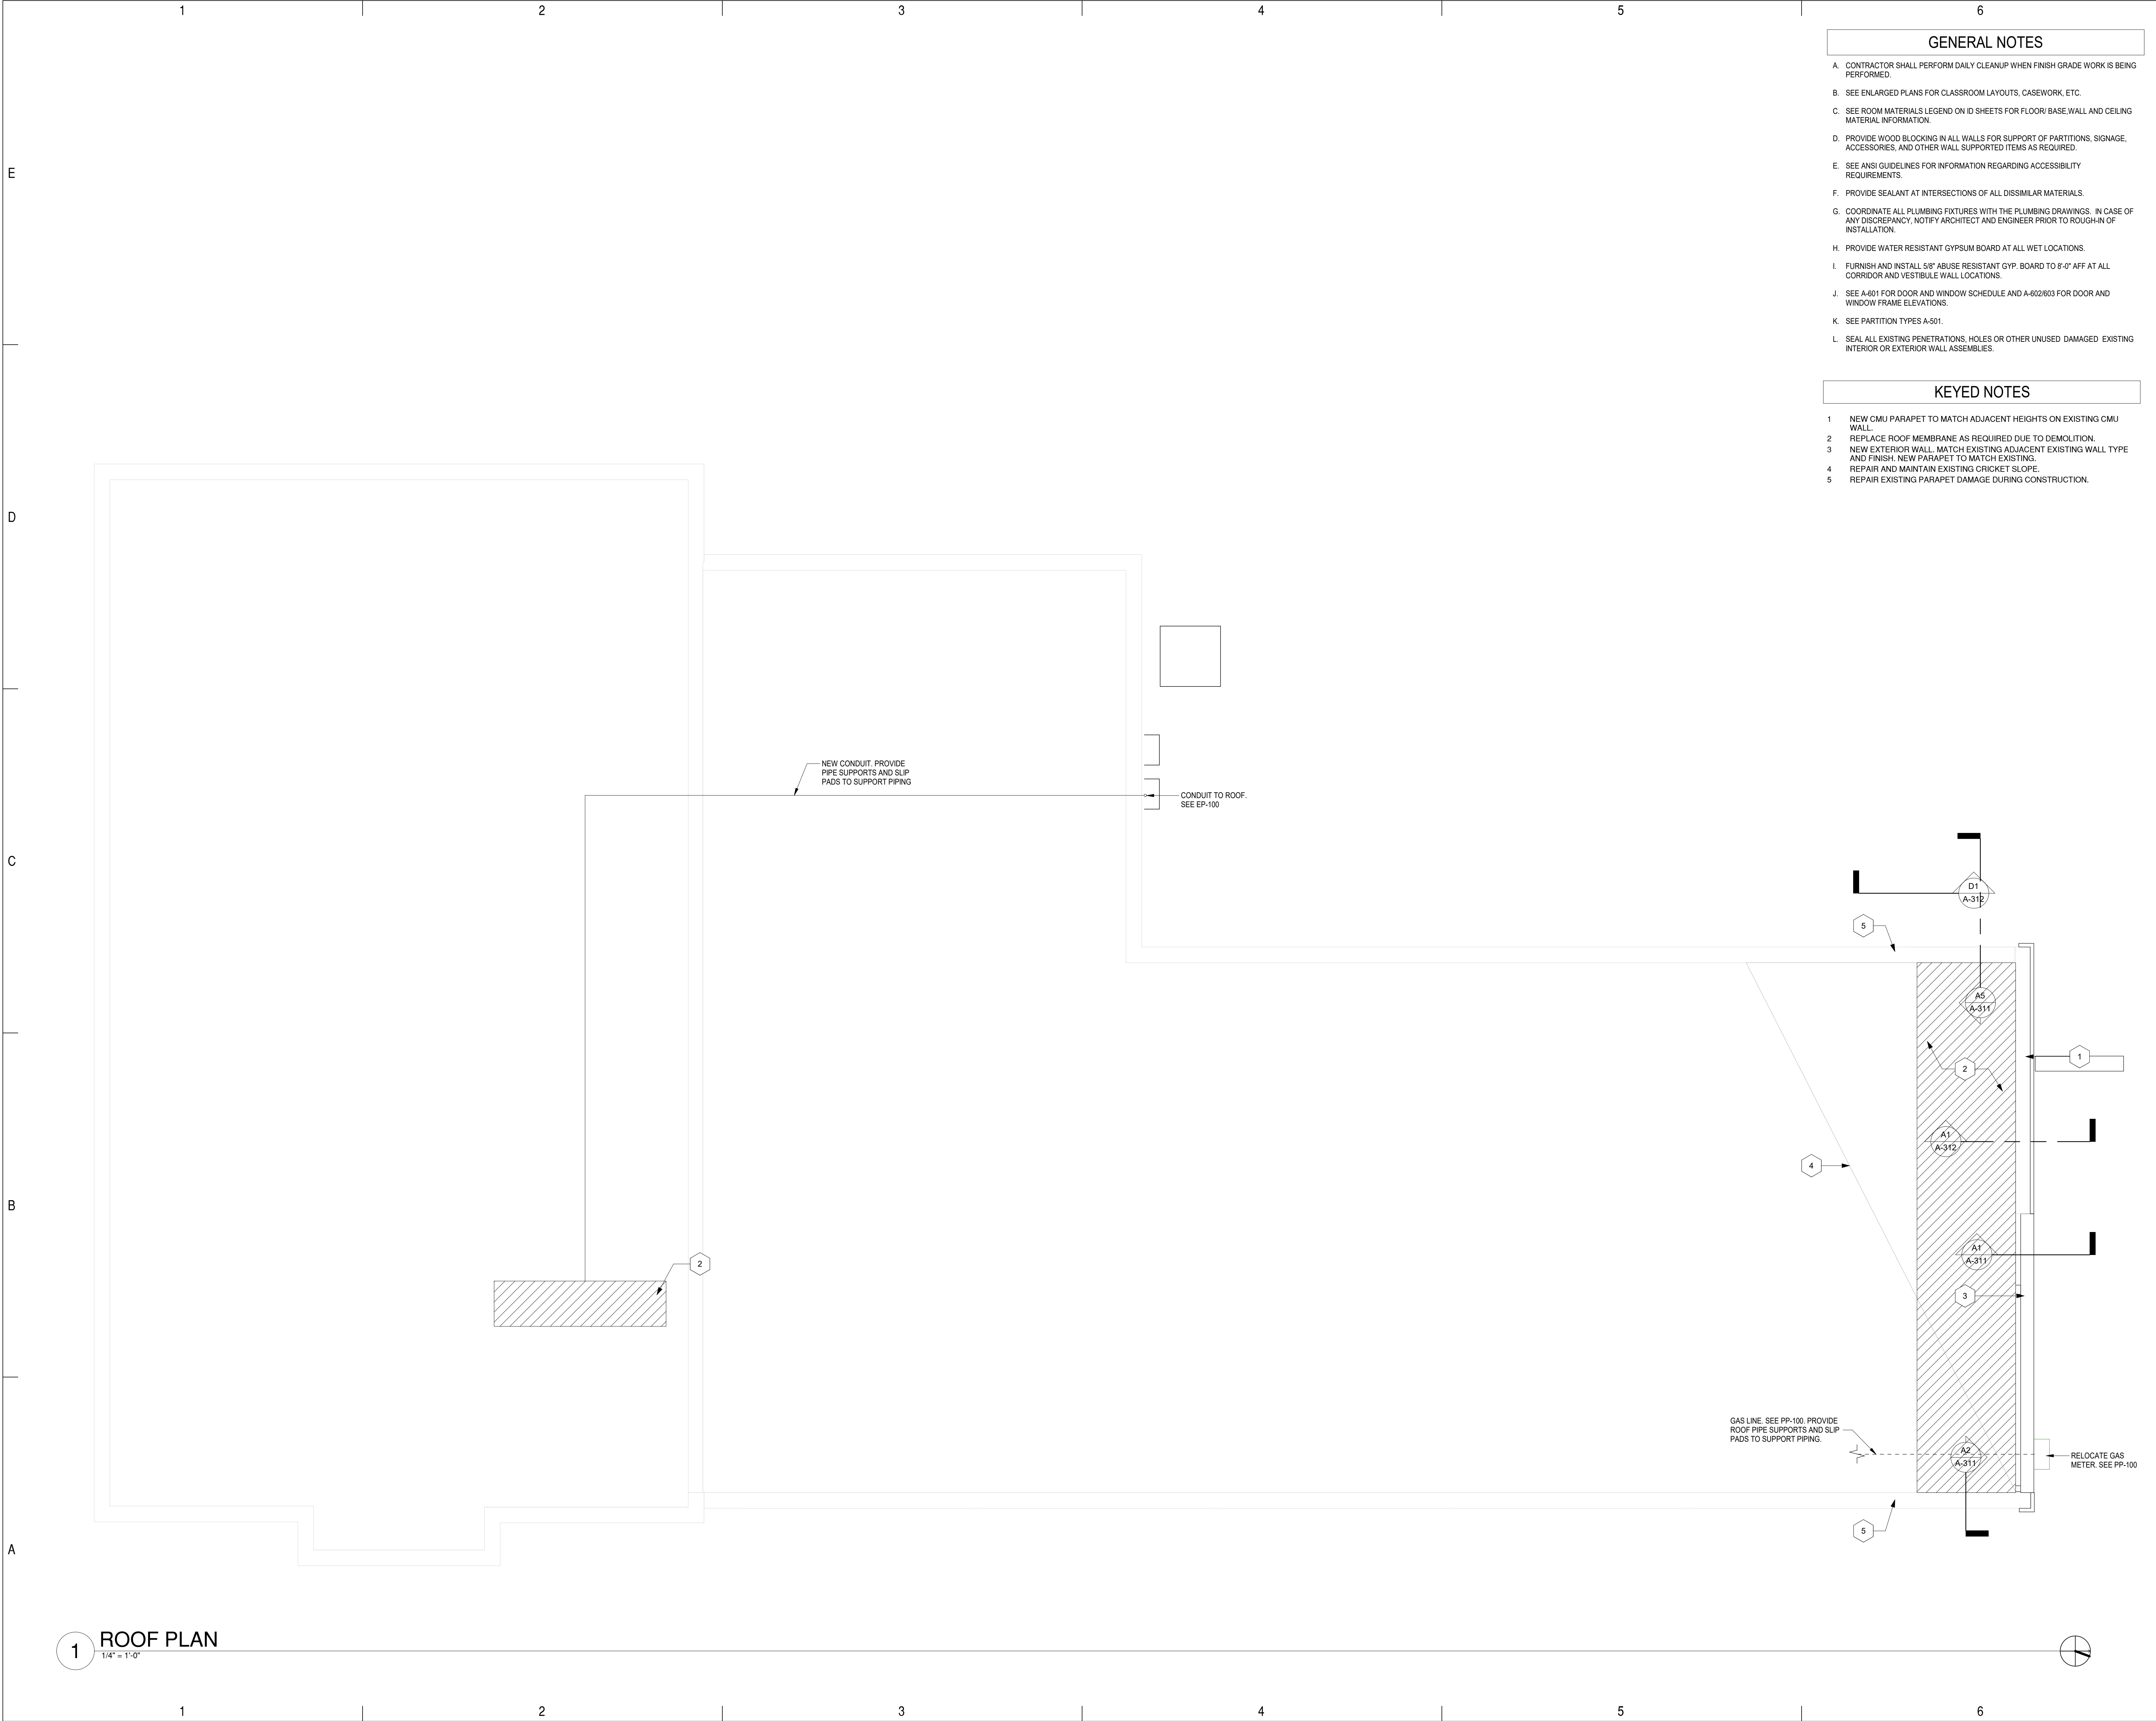
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 REFLECTED CEILING PLANS

**1 REFLECTED CEILING PLAN**  
 1/4" = 1'-0"



AG MOD PHASE 3: NEALE HALL DEMO

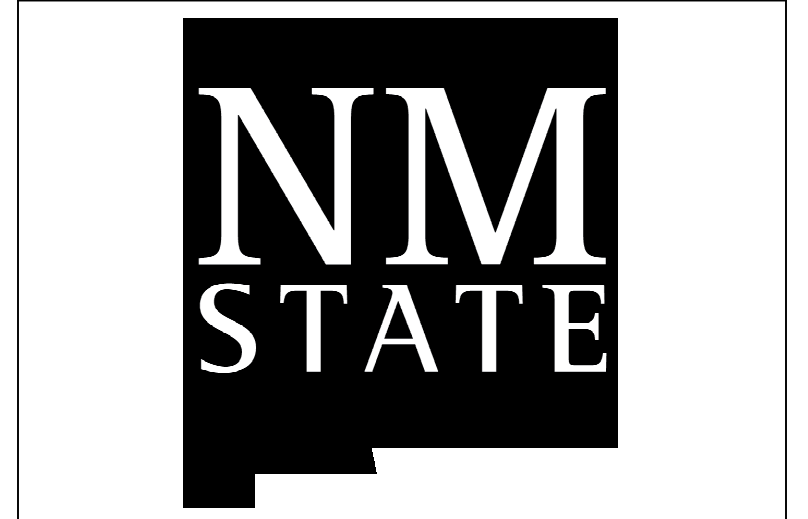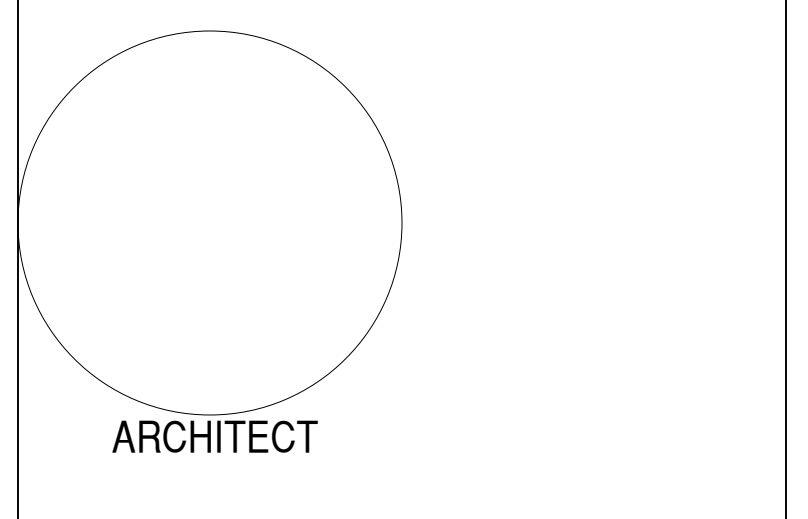3/14/2024 4:59:48 PM



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  - K. SEE PARTITION TYPES A-501.
  - L. SEAL ALL EXISTING PENETRATIONS, HOLES OR OTHER UNUSED DAMAGED EXISTING INTERIOR OR EXTERIOR WALL ASSEMBLIES.

- KEYED NOTES**
- 1 NEW CMU PARAPET TO MATCH ADJACENT HEIGHTS ON EXISTING CMU WALL.
  - 2 REPLACE ROOF MEMBRANE AS REQUIRED DUE TO DEMOLITION.
  - 3 NEW EXTERIOR WALL. MATCH EXISTING ADJACENT EXISTING WALL TYPE AND FINISH. NEW PARAPET TO MATCH EXISTING.
  - 4 REPAIR AND MAINTAIN EXISTING CRICKET SLOPE.
  - 5 REPAIR EXISTING PARAPET DAMAGE DURING CONSTRUCTION.

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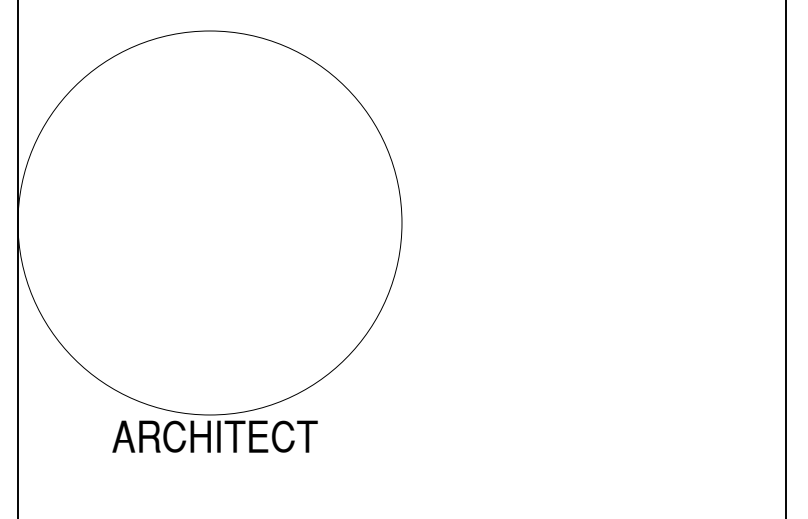
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**NM STATE**

**AG MOD PHASE 3: NEALE HALL DEMO**

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SHEET TITLE  
ROOF PLAN

**1 ROOF PLAN**  
1/4" = 1'-0"

**A-131**

School Information

KEYED NOTES

- 1 NEW PARAPET. MATCH EXISTING. SEE DETAIL A4/A-311
- 2 NEW STUCCO TO MATCH EXISTING. PROVIDE STRUCTURAL SUPPORT DURING CONSTRUCTION FOR INFILL OF WINDOW.
- 3 NEW STUCCO FINISH SYSTEM ON EXISTING CMU WALL. MATCH EXISTING.
- 4 NEW STUCCO FINISH SYSTEM ON EXISTING CMU WALL. MATCH EXISTING.
- 5 NEW STAIR AND RAILING. SEE DETAIL D3/A-201
- 6 DOOR TO REMAIN. PROTECT DURING CONSTRUCTION. TYPICAL FOR ALL EXISTING DOORS NOT NOTED FOR DEMO.
- 7 GLASS BLOCK WINDOW TO REMAIN. PROTECT DURING CONSTRUCTION.
- 8 PATCH AND REPAIR EXISTING STUCCO DAMAGE DURING CANOPY DEMO.
- 9 MODIFY END CAP TO MATCH EXISTING
- 10 WRAP NEW EIFS FINISH AROUND CORNER AND TERMINATE AT EXISTING STUCCO.

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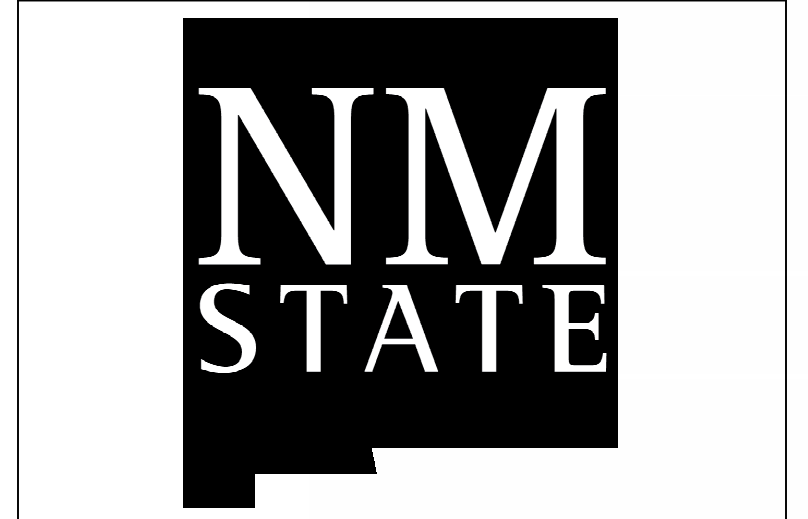
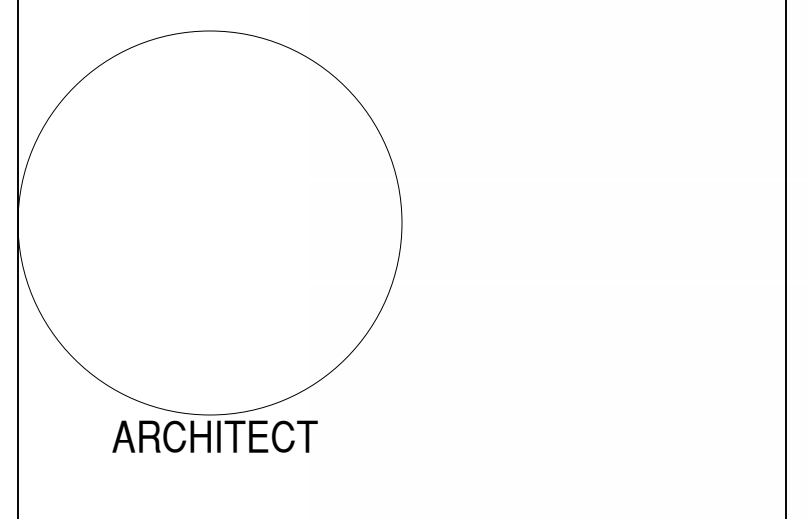
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**AG MOD PHASE 3: NEALE HALL DEMO**

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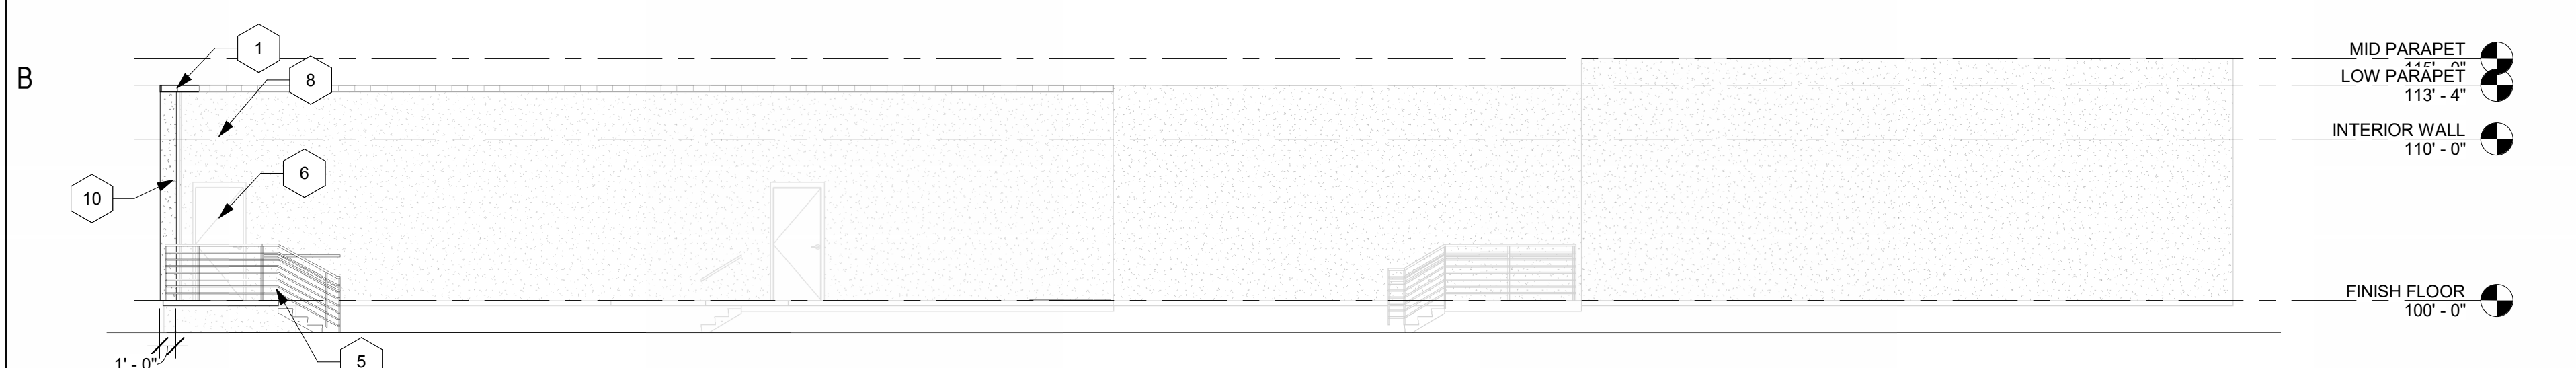
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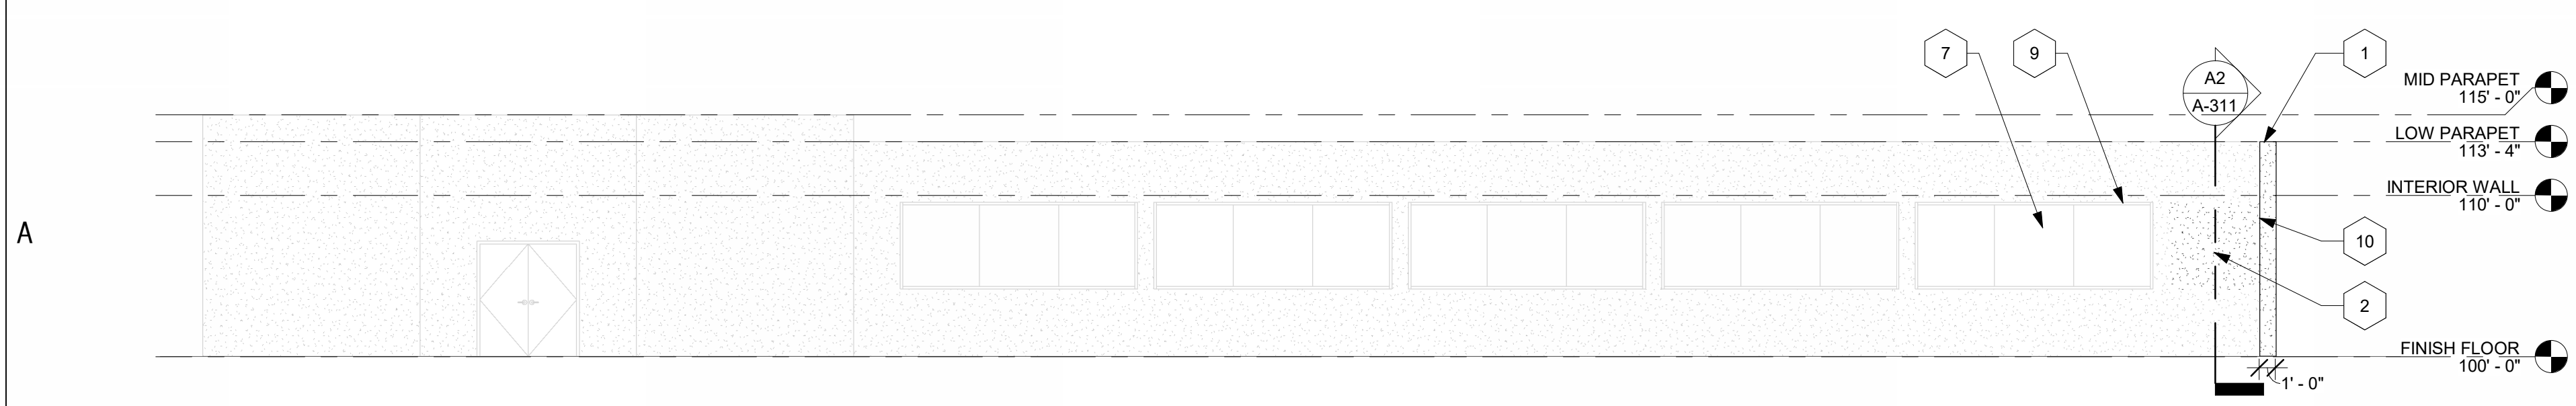
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SHEET TITLE  
BUILDING ELEVATION


**A-201**




**B1** ELEVATION - WEST  
1/8" = 1'-0"



**A1** ELEVATION - EAST  
1/8" = 1'-0"

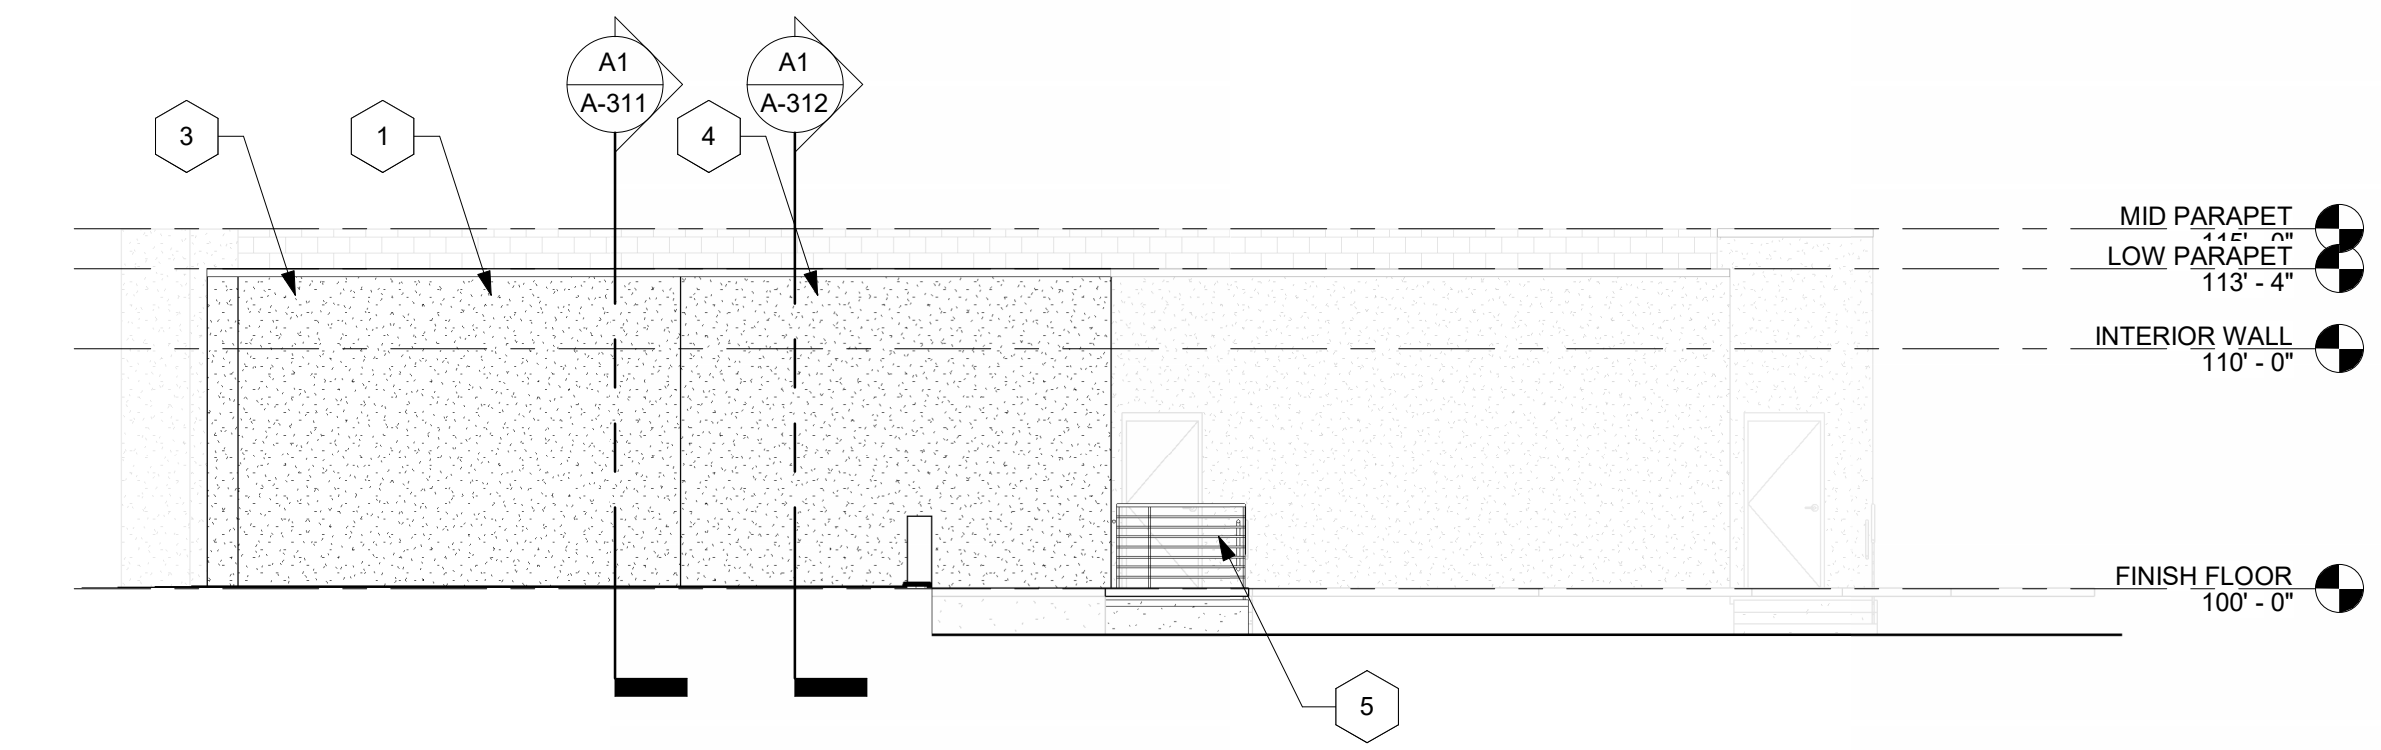

**A4** ELEVATION - NORTH  
1/8" = 1'-0"

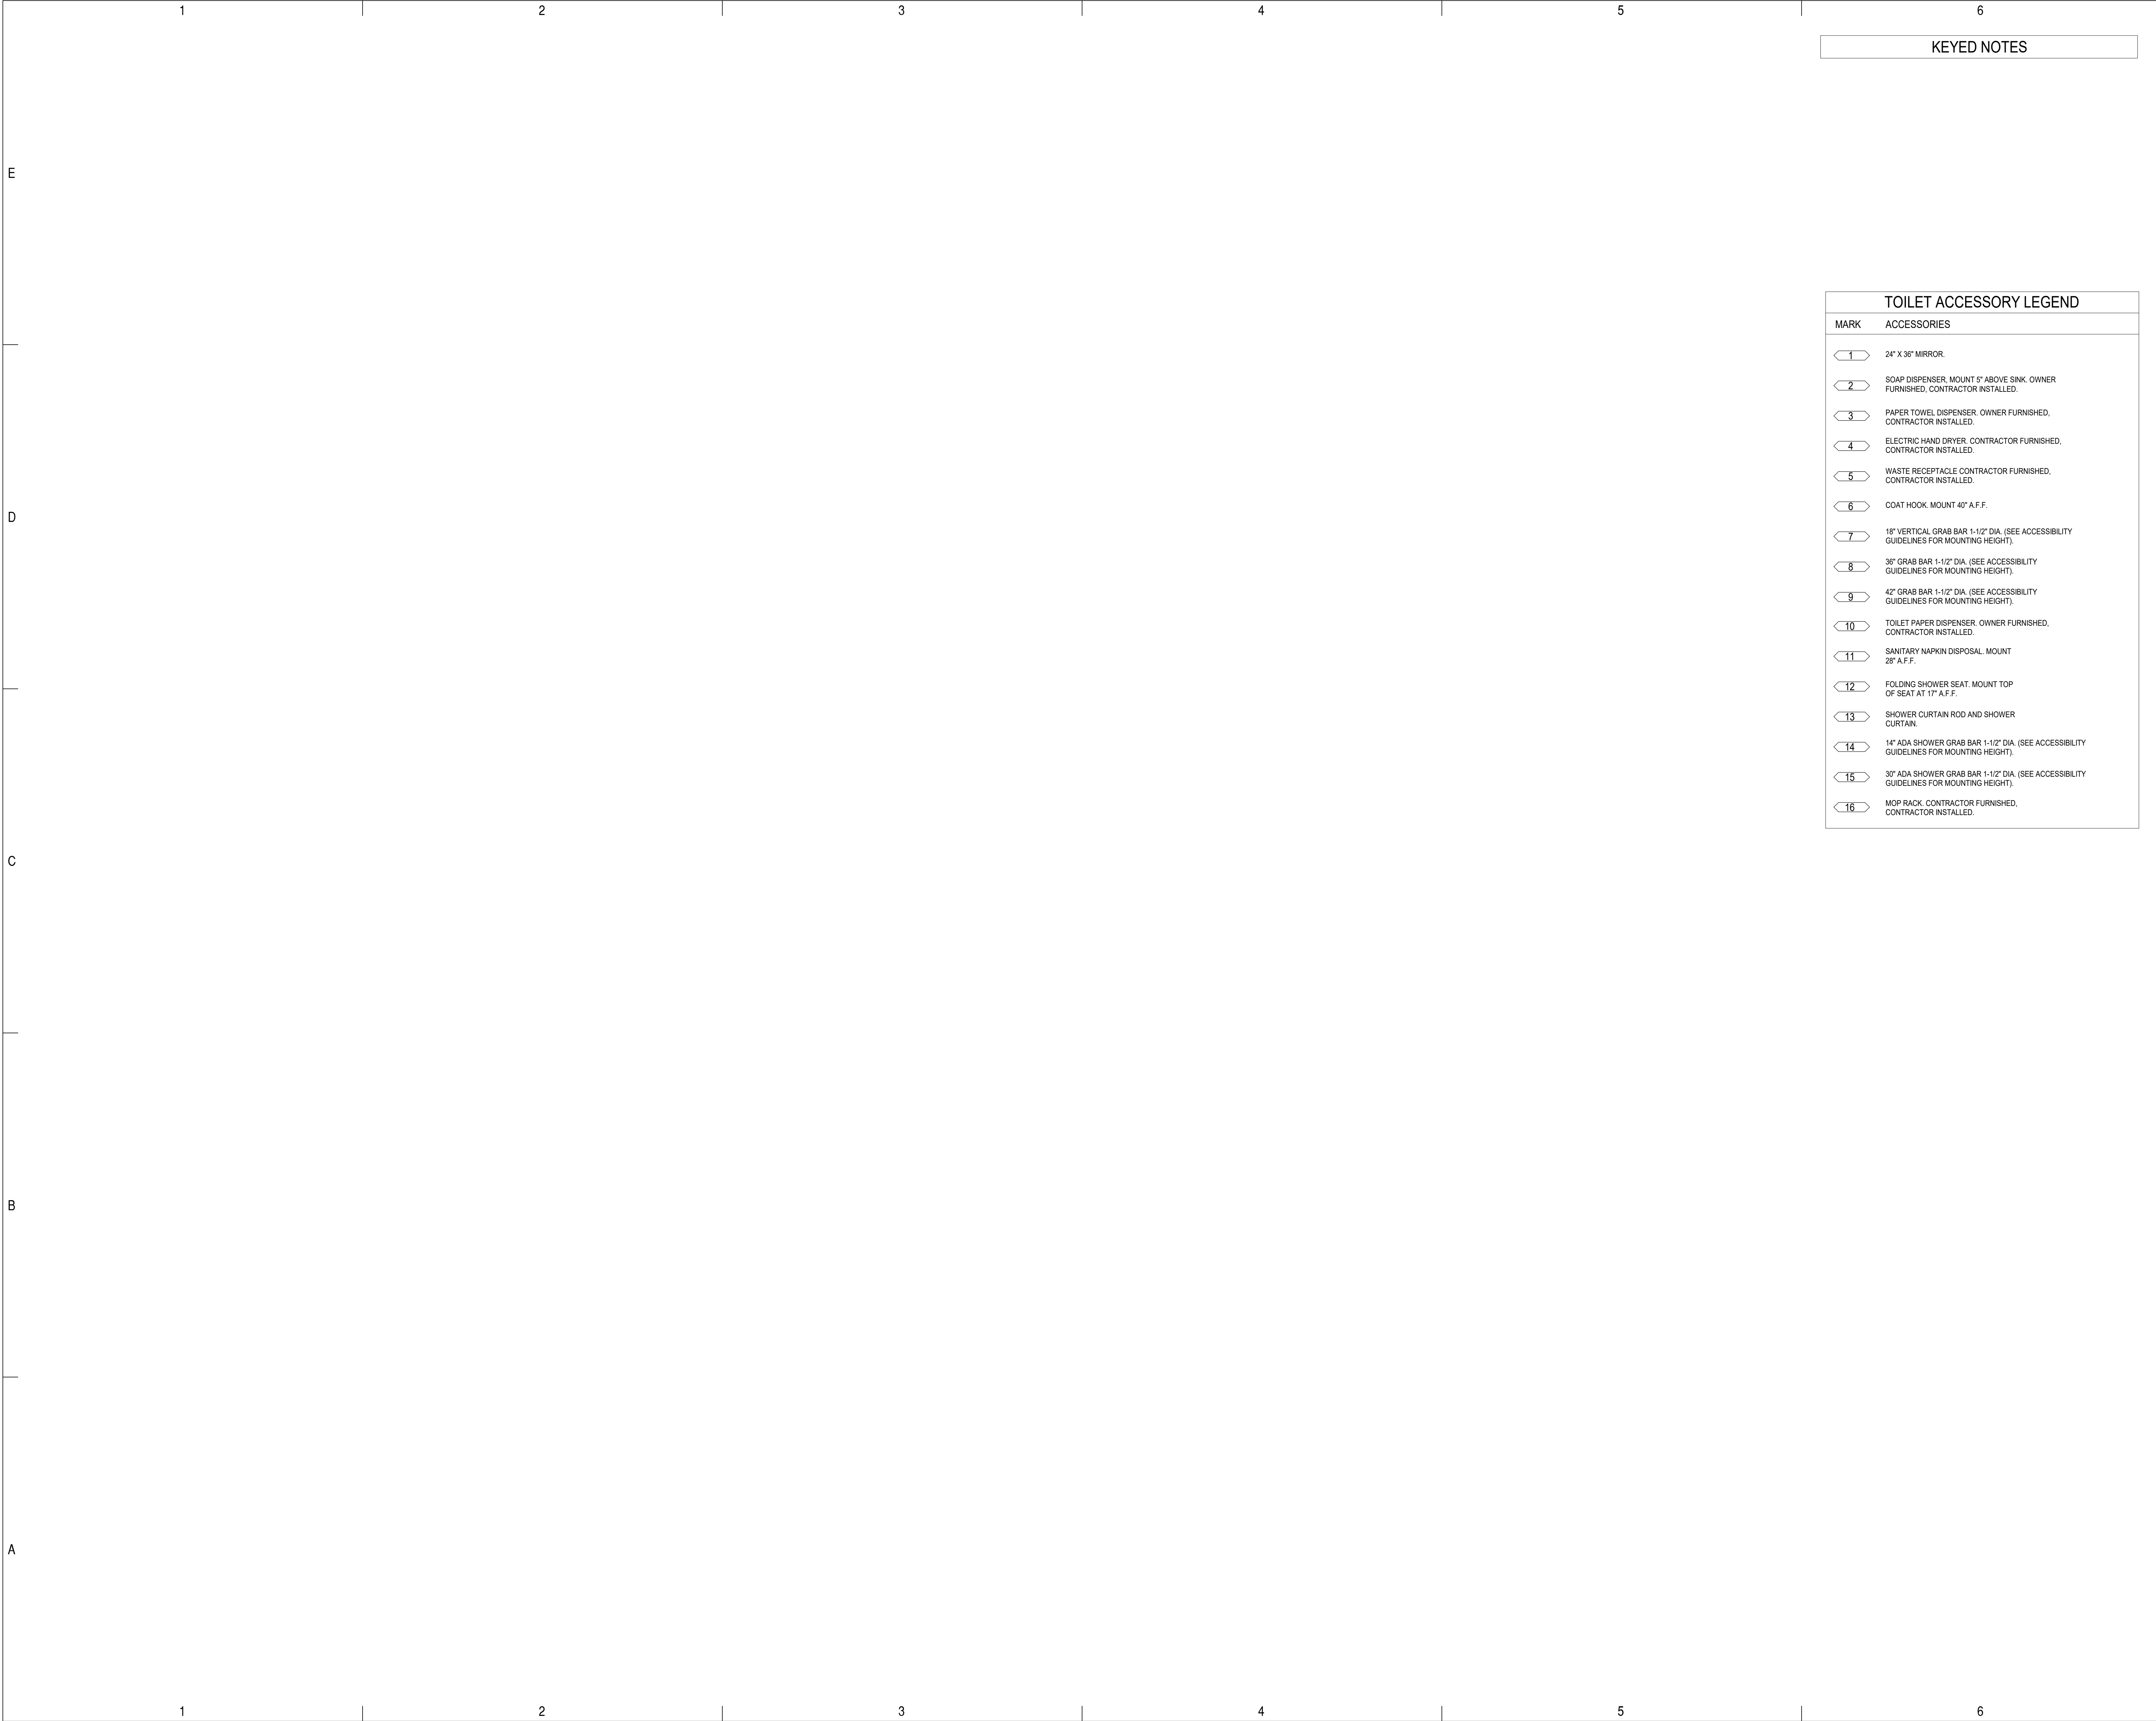

KEYED NOTES

TOILET ACCESSORY LEGEND

| MARK | ACCESSORIES   |
|------|---|
| 1    | 24" X 36" MIRROR.   |
| 2    | SOAP DISPENSER, MOUNT 5" ABOVE SINK. OWNER FURNISHED, CONTRACTOR INSTALLED.             |
| 3    | PAPER TOWEL DISPENSER, OWNER FURNISHED, CONTRACTOR INSTALLED.                           |
| 4    | ELECTRIC HAND DRYER, CONTRACTOR FURNISHED, CONTRACTOR INSTALLED.                        |
| 5    | WASTE RECEPTACLE CONTRACTOR FURNISHED, CONTRACTOR INSTALLED.                            |
| 6    | COAT HOOK, MOUNT 40" A.F.F.   |
| 7    | 18" VERTICAL GRAB BAR 1-1/2" DIA. (SEE ACCESSIBILITY GUIDELINES FOR MOUNTING HEIGHT).   |
| 8    | 36" GRAB BAR 1-1/2" DIA. (SEE ACCESSIBILITY GUIDELINES FOR MOUNTING HEIGHT).            |
| 9    | 42" GRAB BAR 1-1/2" DIA. (SEE ACCESSIBILITY GUIDELINES FOR MOUNTING HEIGHT).            |
| 10   | TOILET PAPER DISPENSER, OWNER FURNISHED, CONTRACTOR INSTALLED.                          |
| 11   | SANITARY NAPKIN DISPOSAL MOUNT 28" A.F.F.   |
| 12   | FOLDING SHOWER SEAT, MOUNT TOP OF SEAT AT 17" A.F.F.                                    |
| 13   | SHOWER CURTAIN ROD AND SHOWER CURTAIN.  |
| 14   | 14" ADA SHOWER GRAB BAR 1-1/2" DIA. (SEE ACCESSIBILITY GUIDELINES FOR MOUNTING HEIGHT). |
| 15   | 30" ADA SHOWER GRAB BAR 1-1/2" DIA. (SEE ACCESSIBILITY GUIDELINES FOR MOUNTING HEIGHT). |
| 16   | MOP RACK, CONTRACTOR FURNISHED, CONTRACTOR INSTALLED.                                   |

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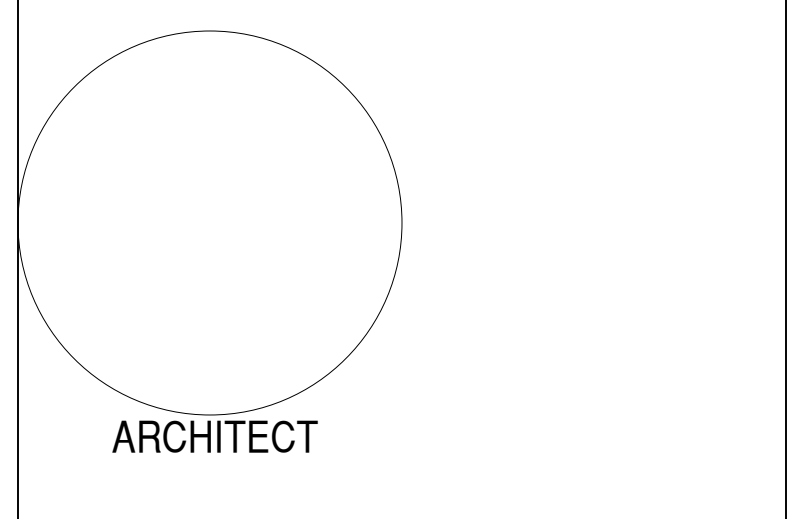
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**AG MOD PHASE 3: NEALE HALL DEMO**

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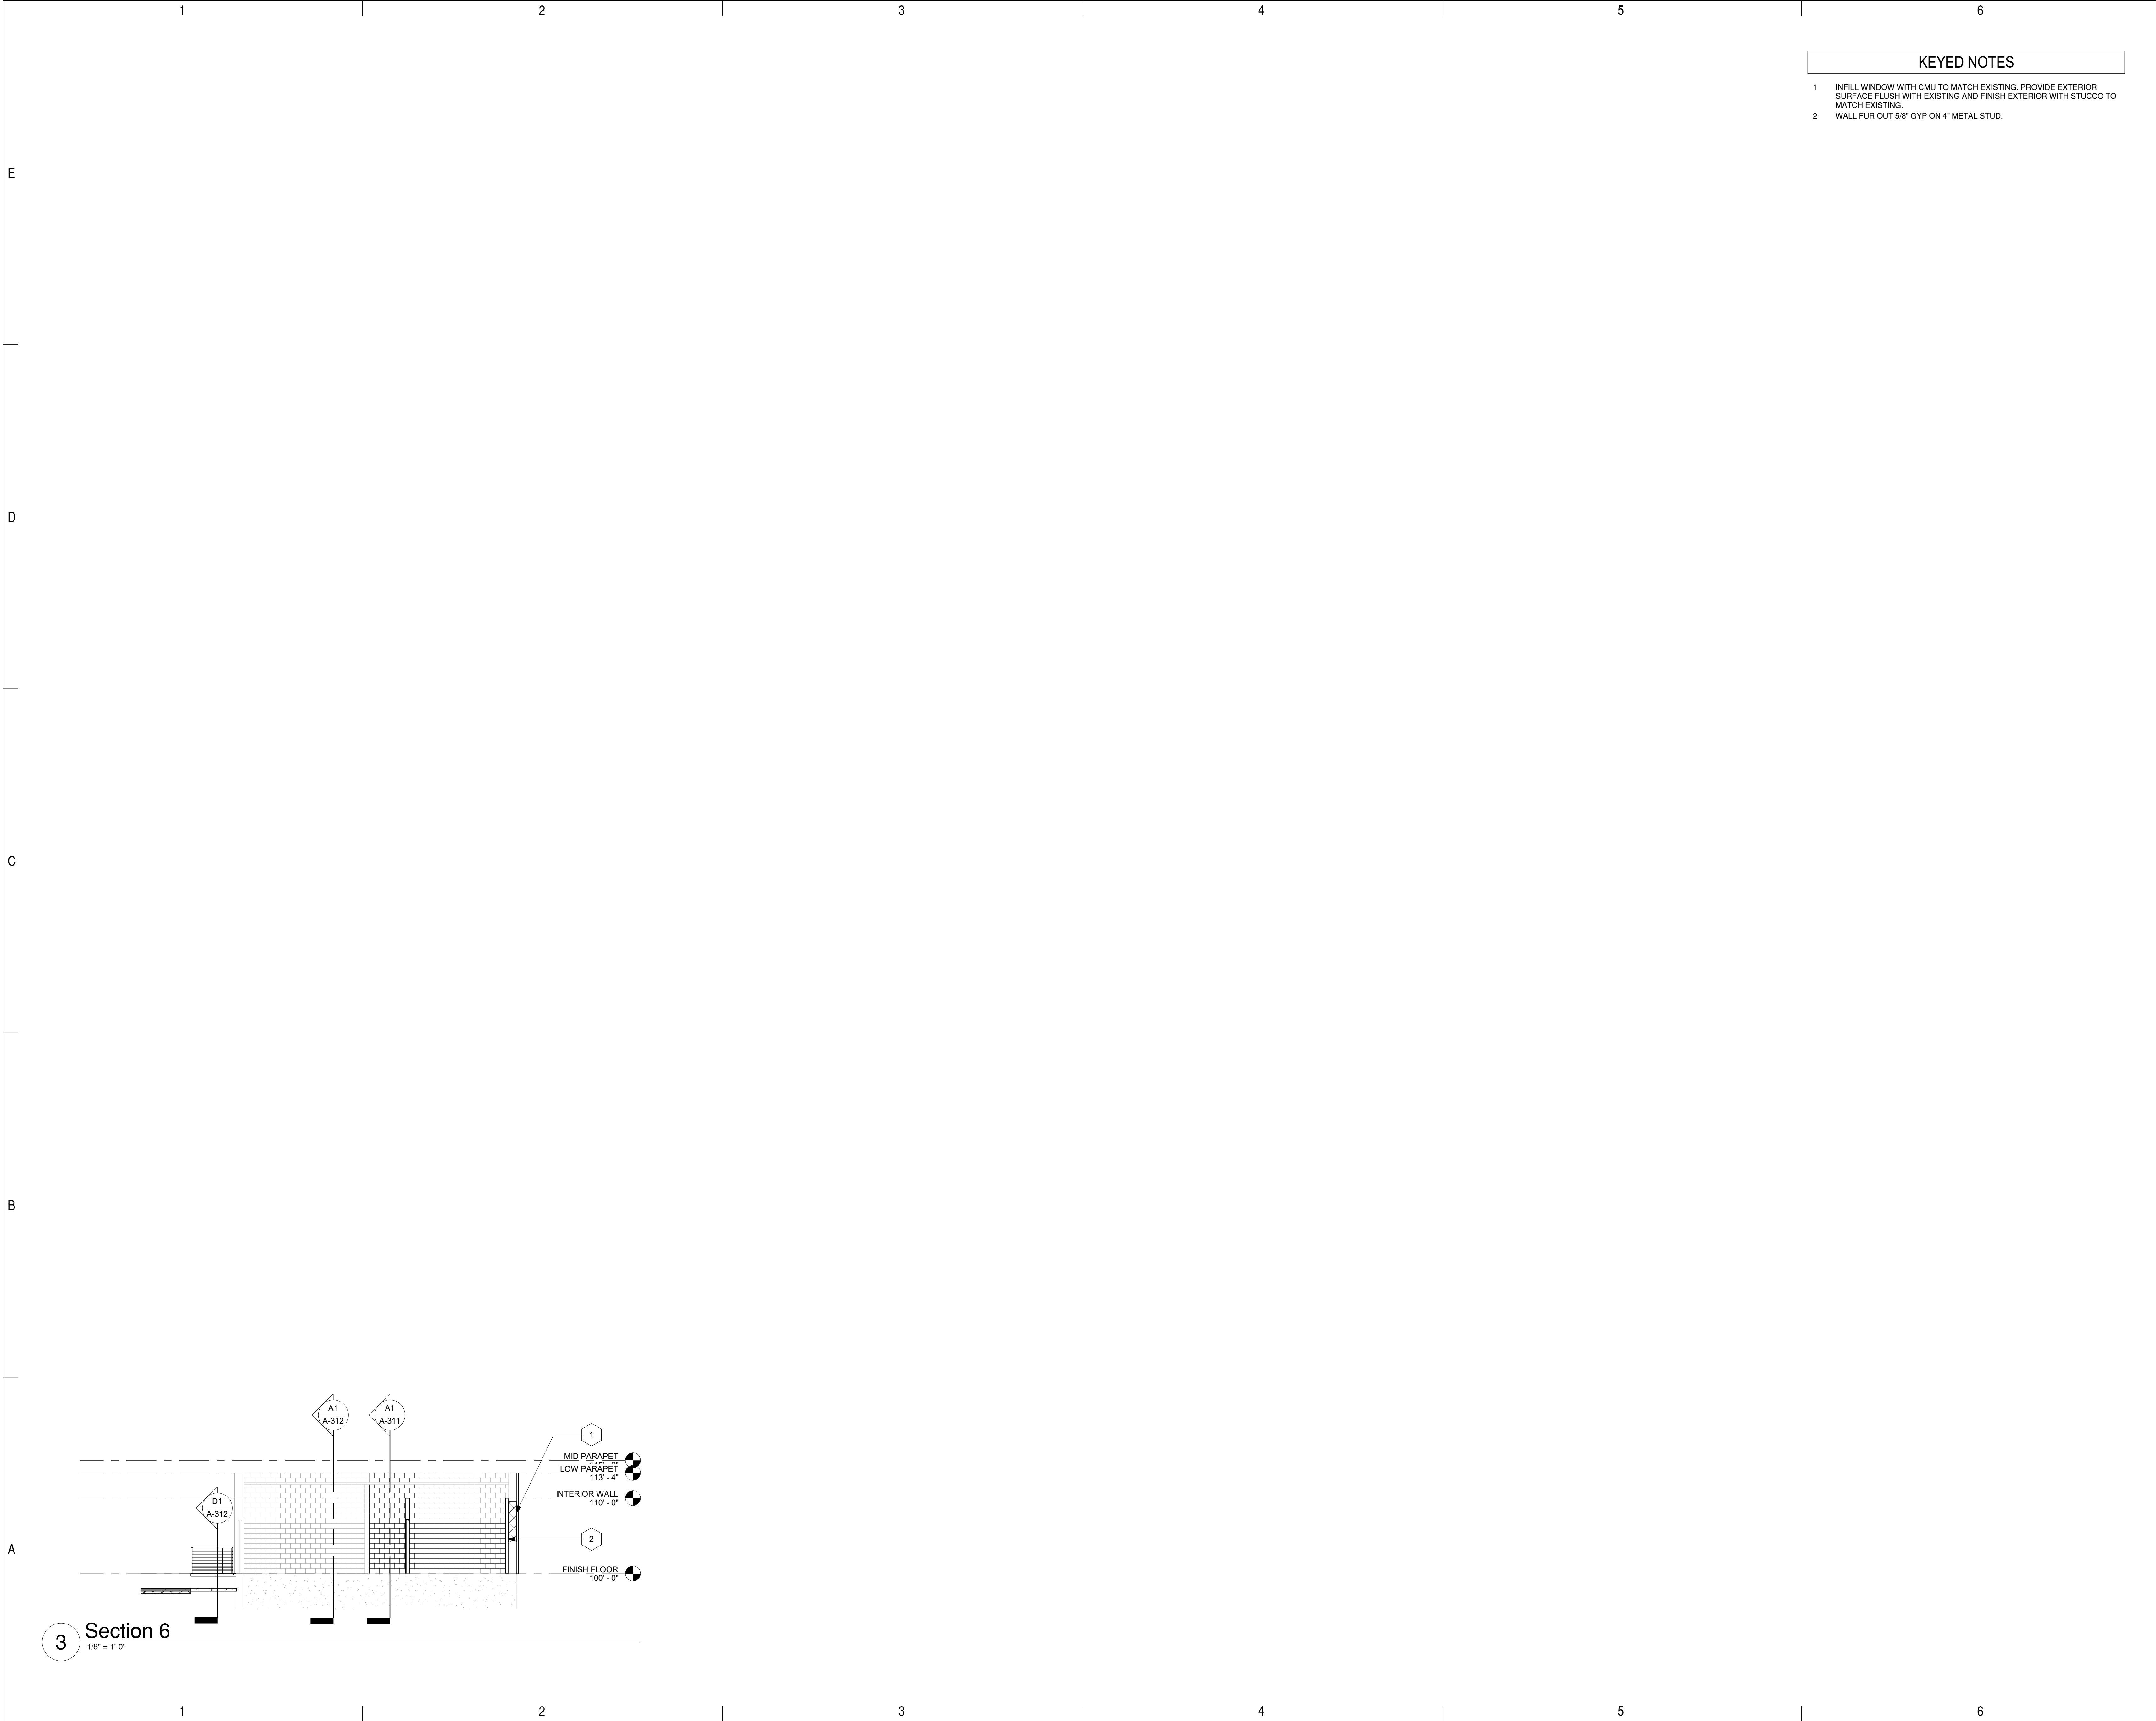
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SHEET TITLE  
INTERIOR ELEVATIONS

**A-211**



3 Section 6  
1/8" = 1'-0"

KEYED NOTES

- 1 INFILL WINDOW WITH CMU TO MATCH EXISTING. PROVIDE EXTERIOR SURFACE FLUSH WITH EXISTING AND FINISH EXTERIOR WITH STUCCO TO MATCH EXISTING.
- 2 WALL FUR OUT 5/8" GYP ON 4" METAL STUD.

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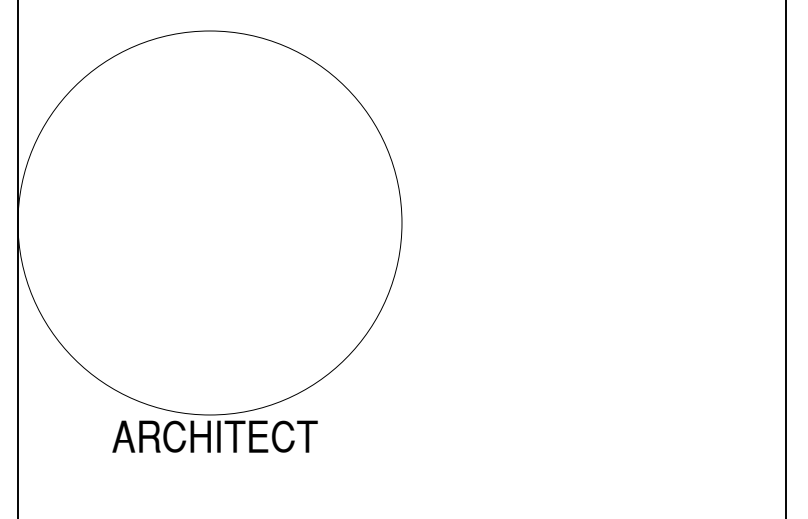
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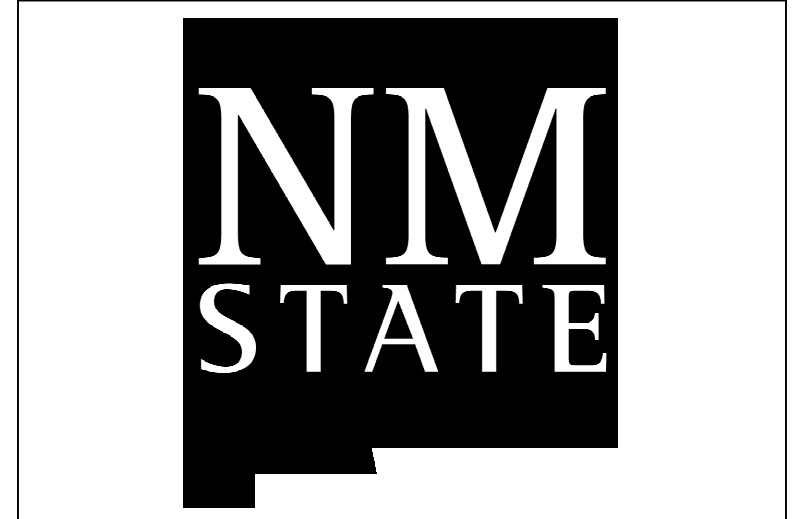
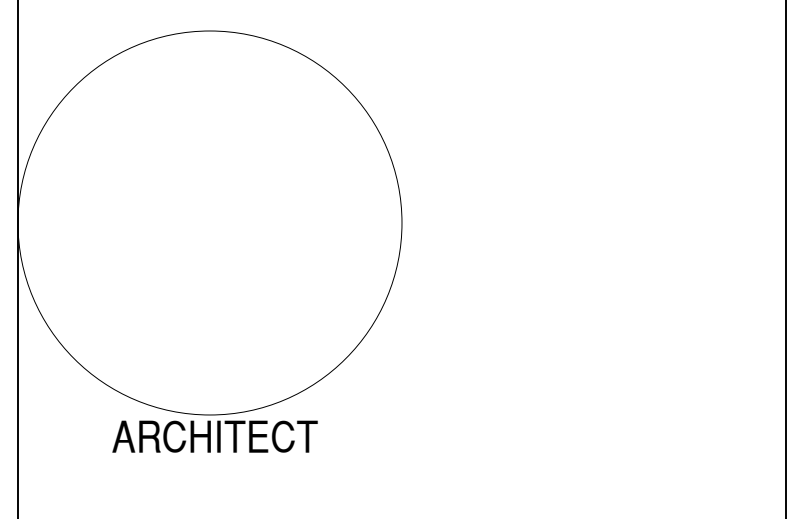
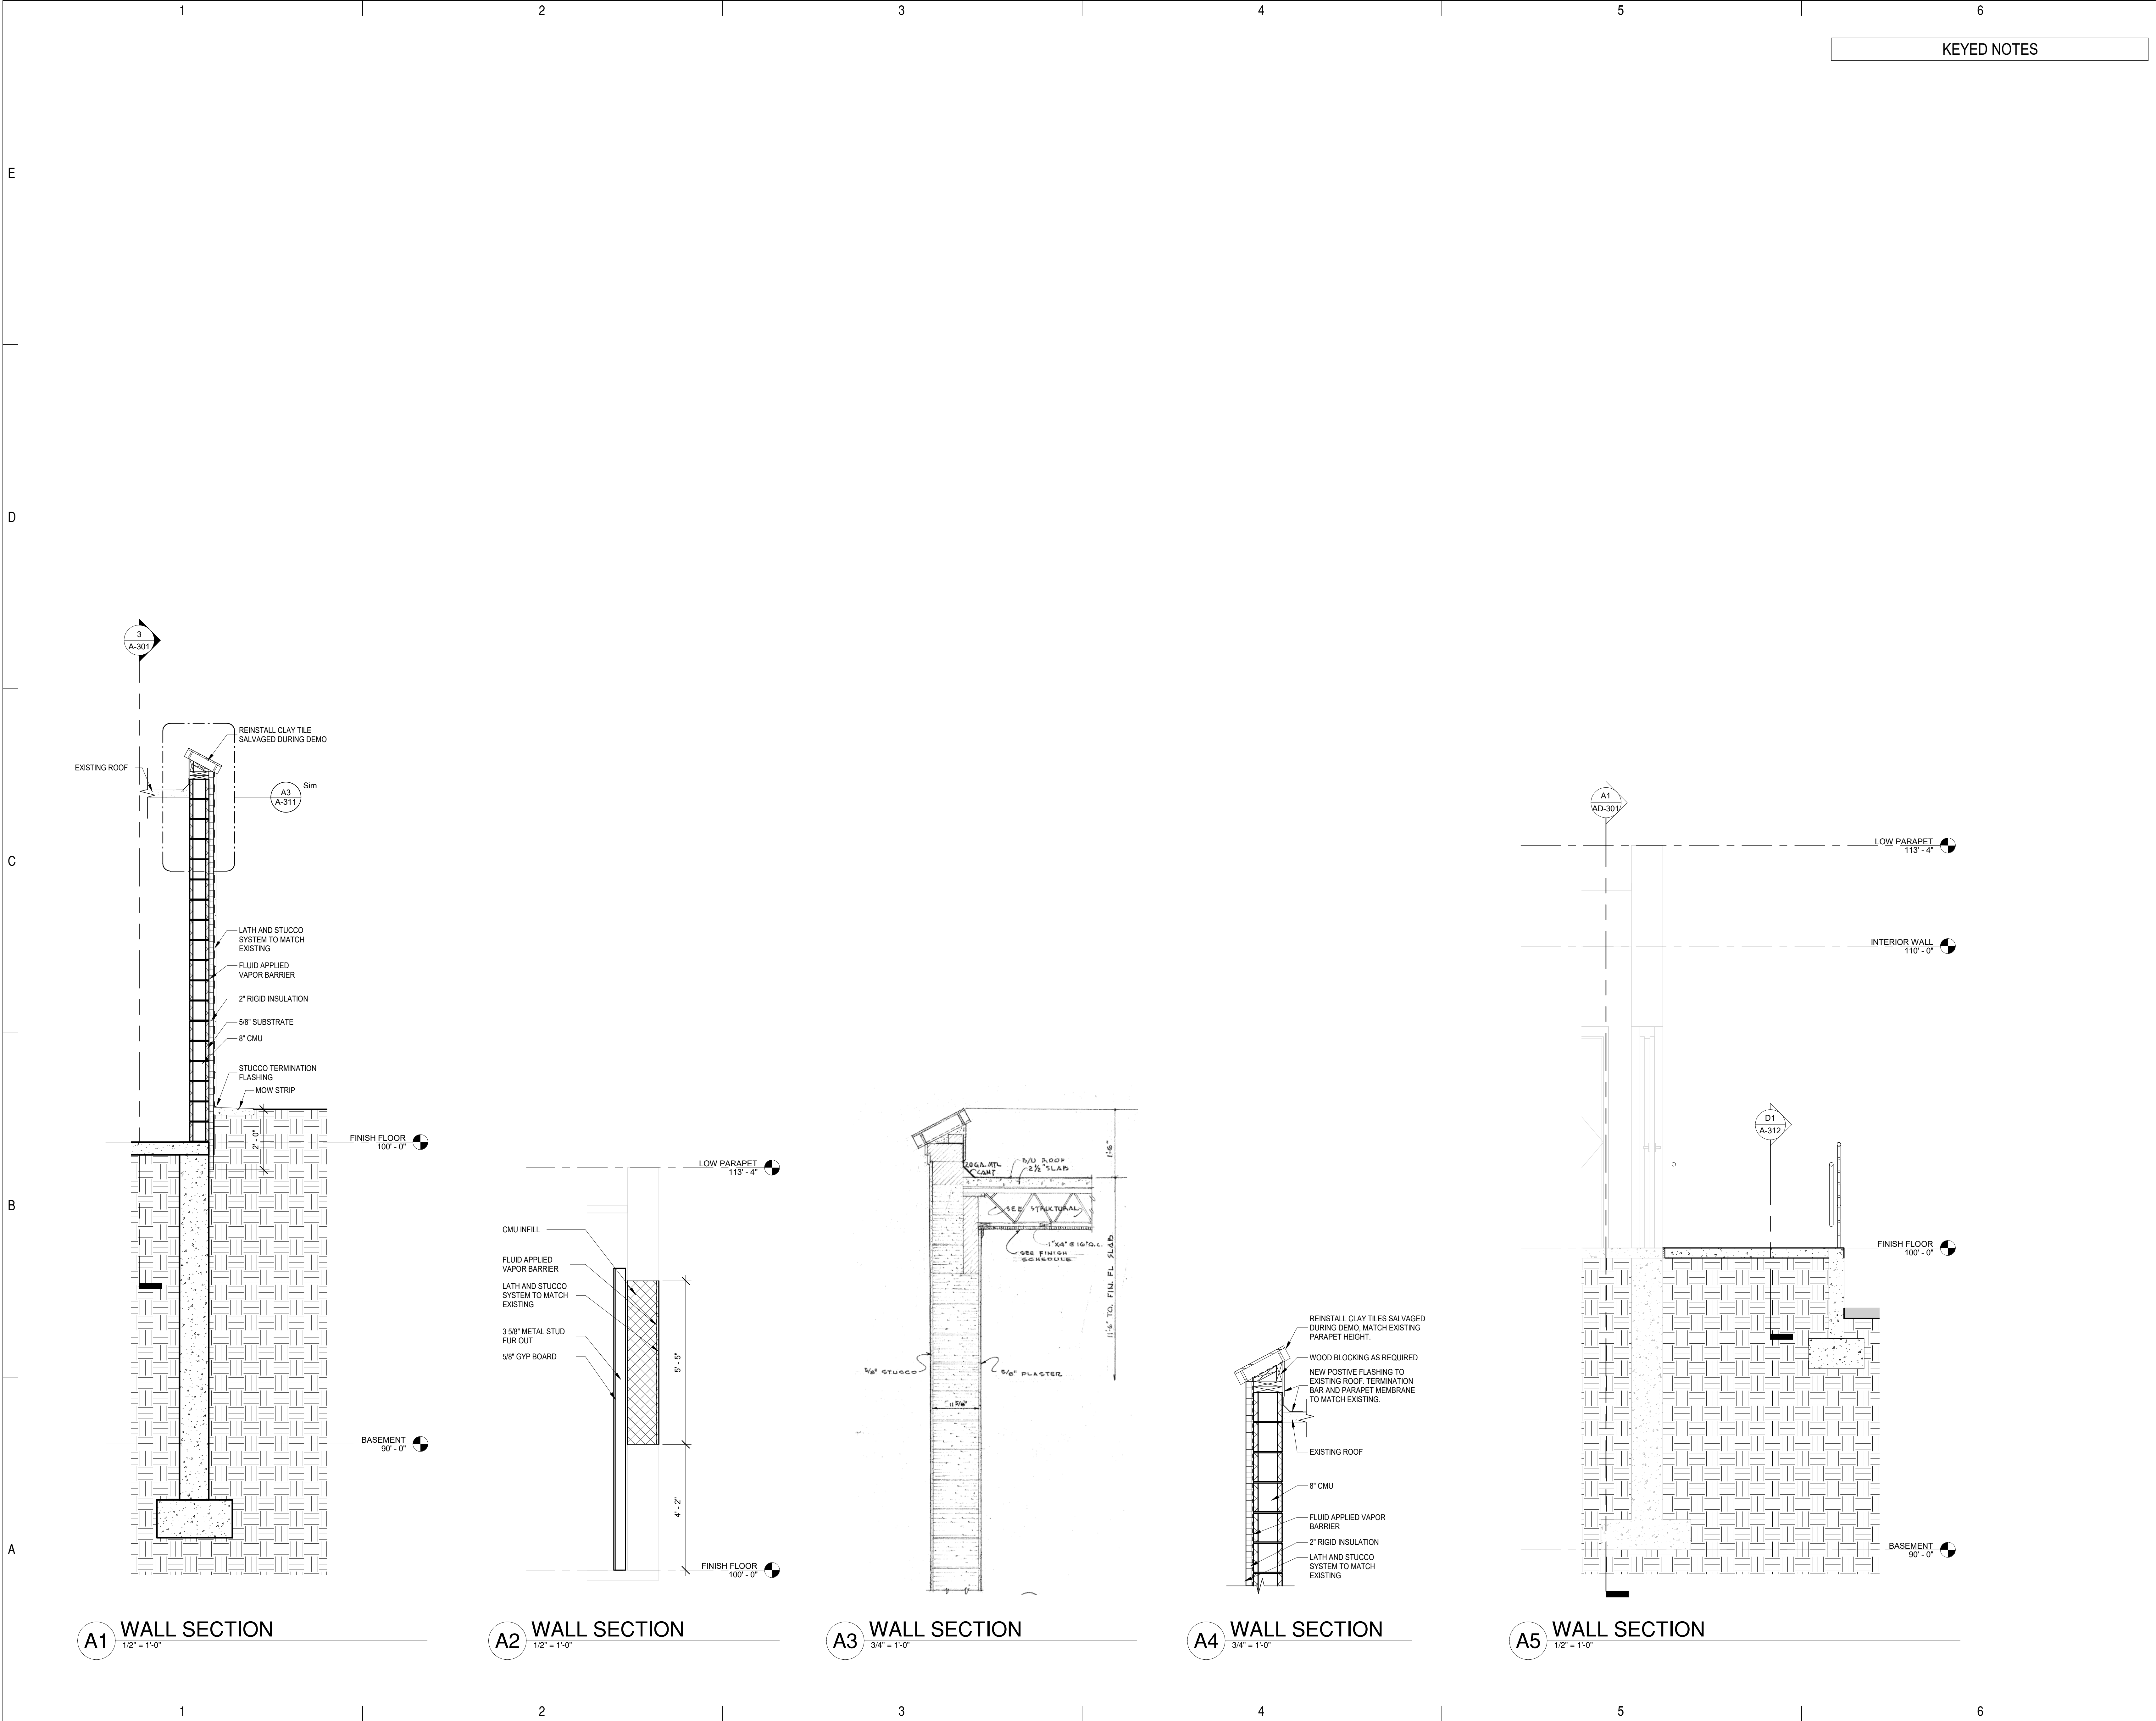
SHEET TITLE  
 BUILDING SECTIONS

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SHEET TITLE  
 WALL SECTIONS

**A-311**

KEYED NOTES

- 2 ROOF ASSEMBLY. SEE ROOF PLAN.
- 7 EXTERIOR INSULATION AND FINISH SYSTEM, OVER STEEL STUD FRAMING.
- 8 LOUVER, SEE SPECIFICATIONS.
- 9 PARAPET WITH PRE-FINISHED COPING SYSTEM. SEE ROOF PLAN AND DETAILS.
- 10 STRUCTURE. PAINT P2 AT EXPOSED AREAS UNLESS OTHERWISE INDICATED. SEE STRUCTURAL DRAWINGS AND FINISH SCHEDULE.
- 13 GYPSUM BOARD WALL. TAPE, TEXTURE AND PAINT. SEE FINISH PLAN AND SCHEDULE.
- 14 MECHANICAL EQUIPMENT. SEE MECHANICAL ROOF PLAN.
- 15 CONCRETE SLAB OVER STRUCTURAL METAL DECK.

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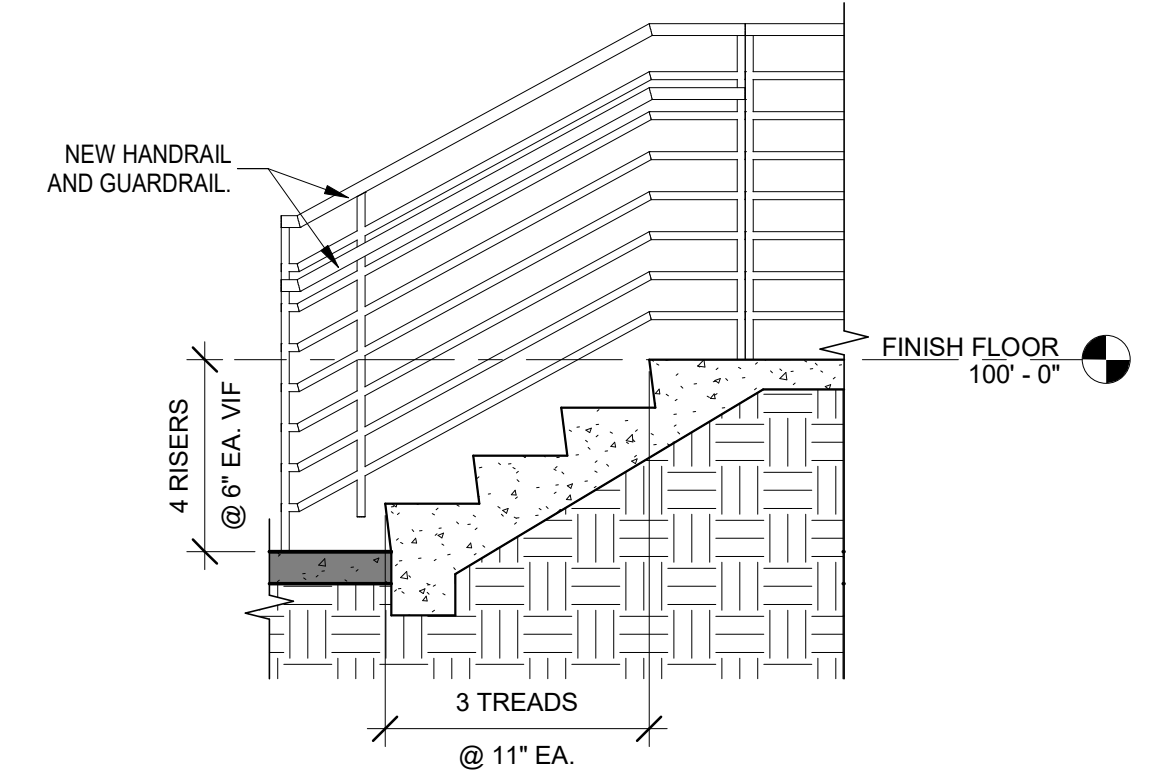
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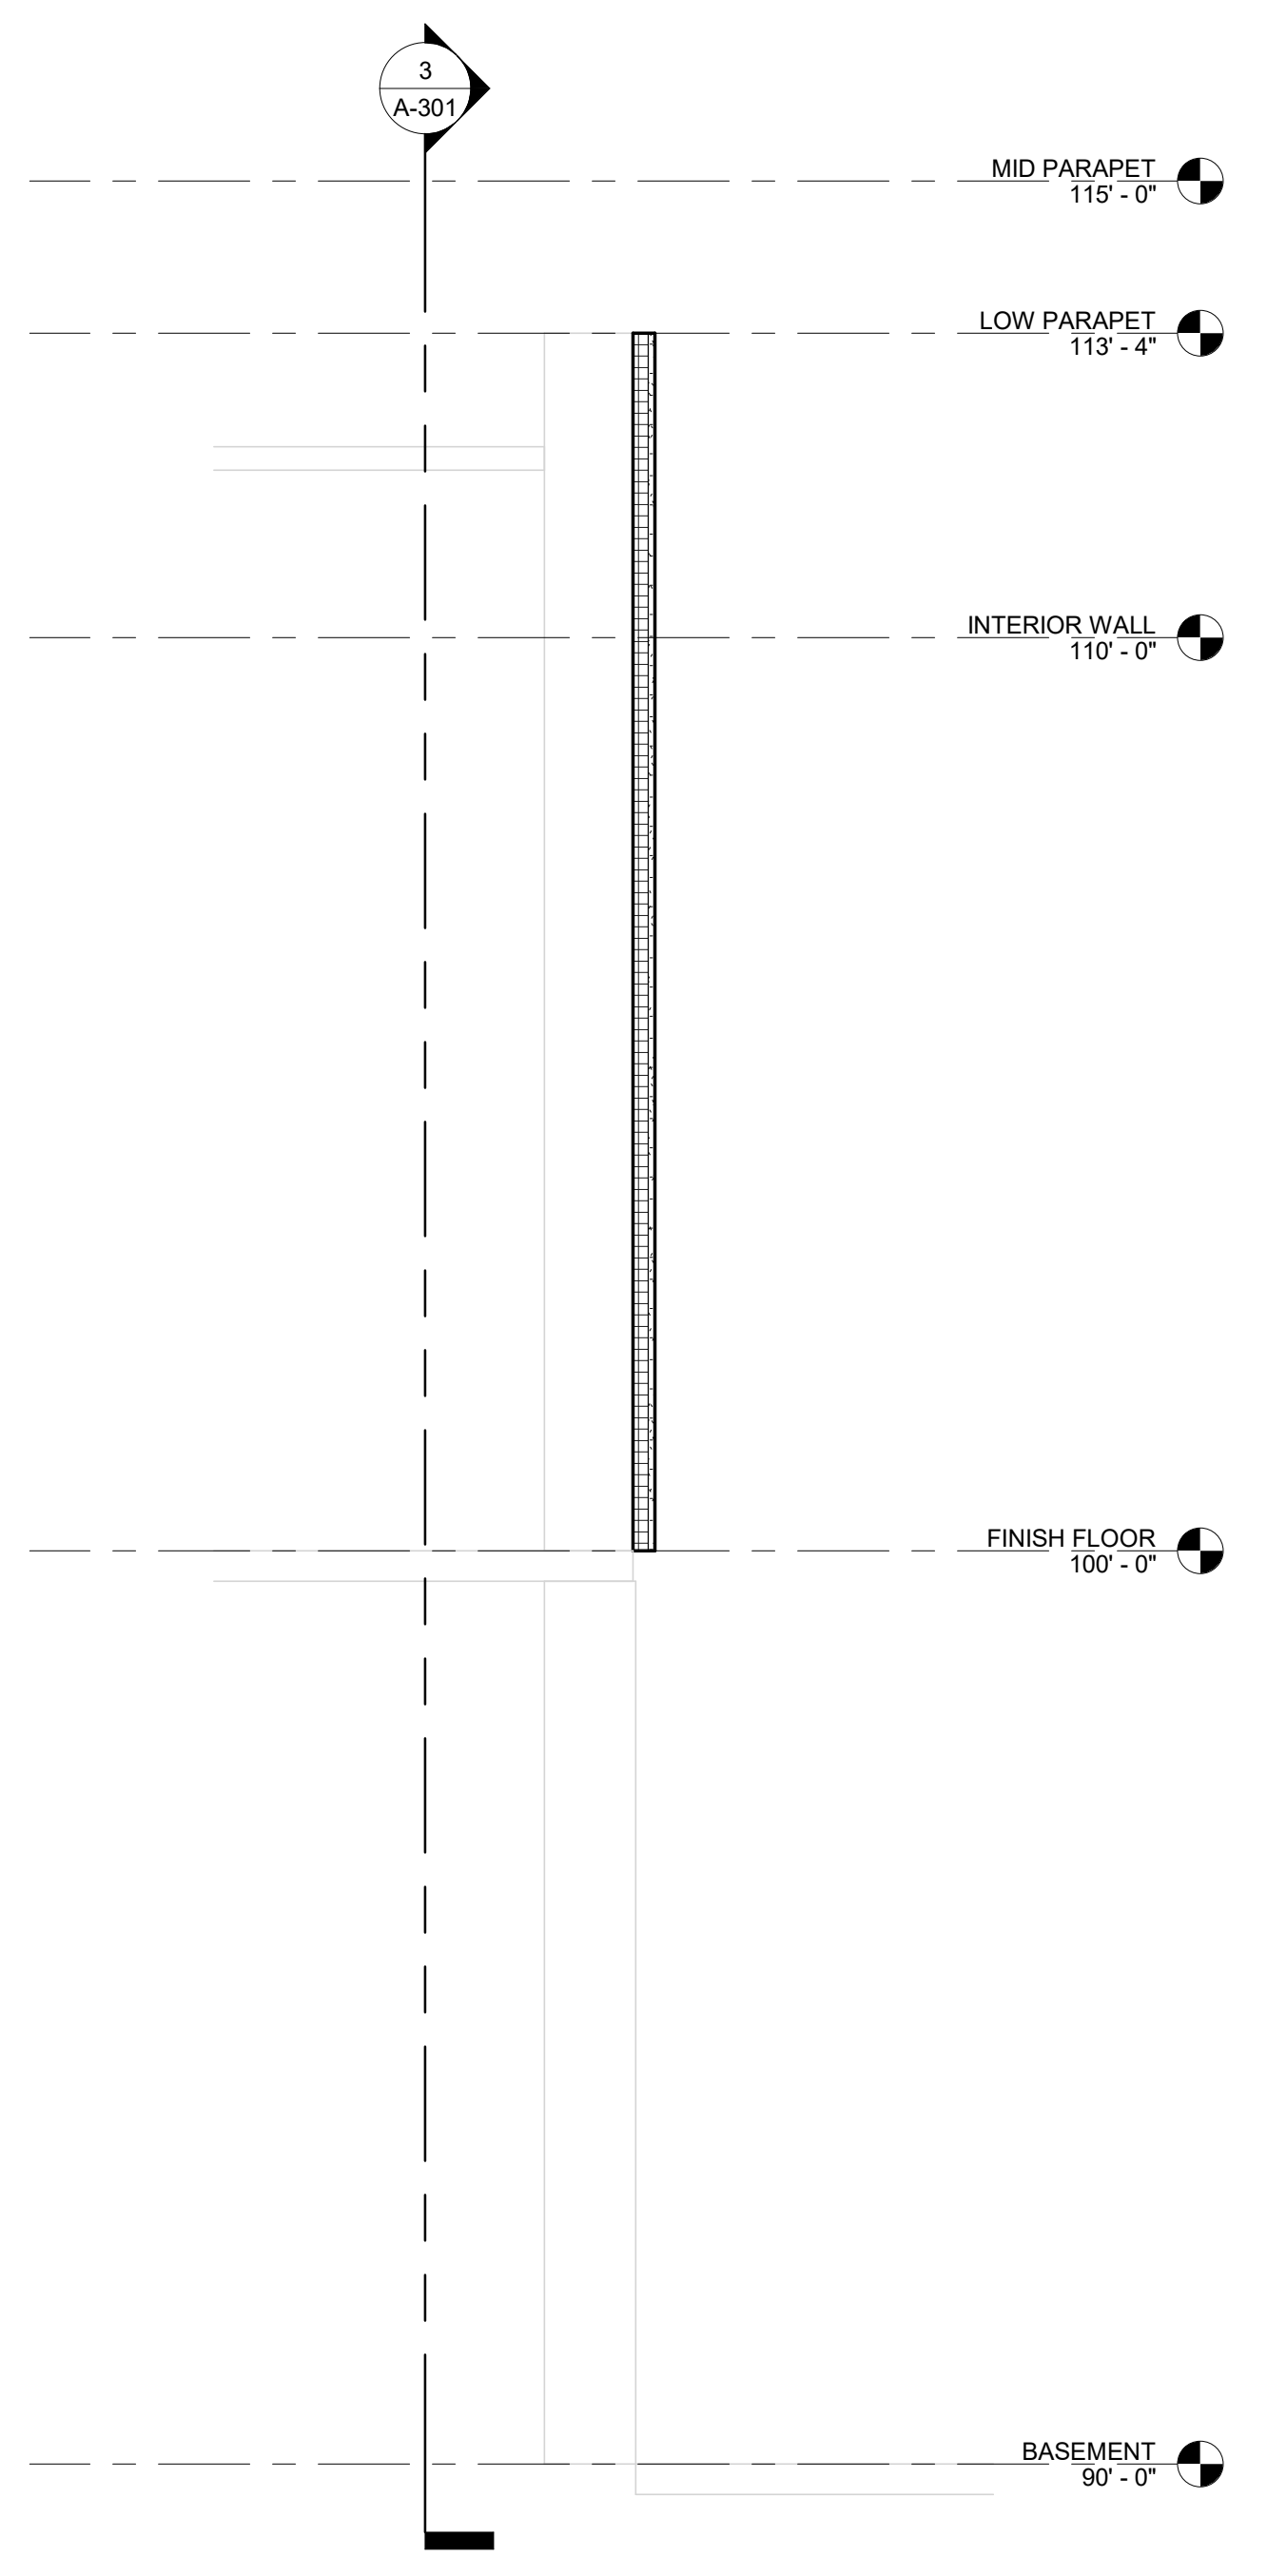
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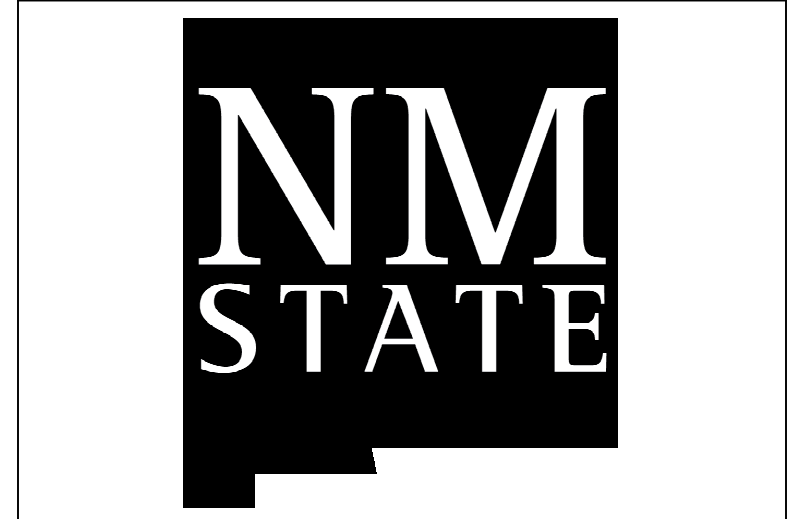
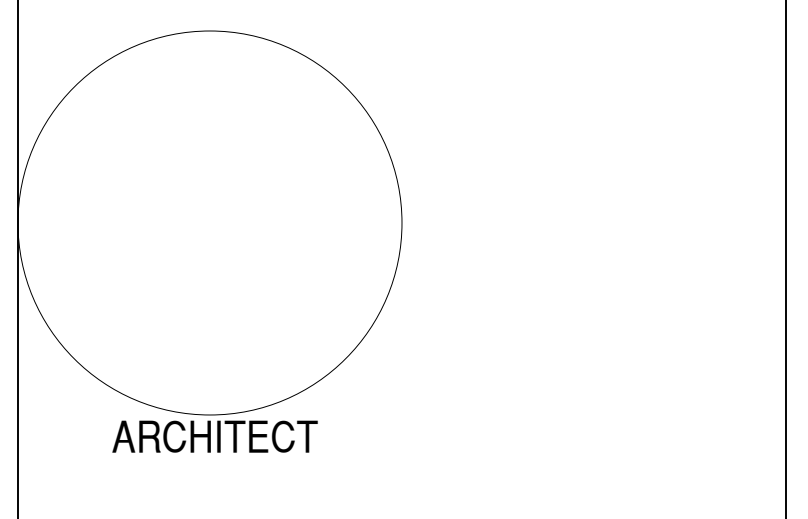
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D1 SECTION STAIRS  
1/2" = 1'-0"



A1 WALL SECTION  
1/2" = 1'-0"



**AG MOD PHASE 3: NEALE HALL DEMO**

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SHEET TITLE  
WALL SECTIONS

A-312

AG MOD PHASE 3: NEALE HALL DEMO

| Door & Frame Schedule |           |        |           |                |            |         |             |                       |                       |                       |         |
|-----------------------|-----------|--------|-----------|----------------|------------|---------|-------------|-----------------------|-----------------------|-----------------------|---------|
| DOOR NUMBER           | DOOR SIZE |        | DOOR TYPE | FACING/ FINISH | FRAME TYPE | GLAZING | FIRE RATING | DETAIL REFERENCE HEAD | DETAIL REFERENCE JAMB | DETAIL REFERENCE SILL | REMARKS |
|                       | WIDTH     | HEIGHT |           |                |            |         |             |                       |                       |                       |         |
| 120                   | 4'-0"     | 7'-0"  | HM        | PAINT          | HM         | -       | -           | A1/A-S21              | A1/A-S21              | -                     |         |

**GENERAL NOTES**

A. PACK ALL HOLLOW METAL DOOR FRAMES WITH MINERAL WOOL.  
 B. FINISH AND INSTALL PAINTABLE SEALANT AT INTERSECTION OF ALL DISSIMILAR MATERIALS.  
 C. ALL FRAME DIMENSIONS AND PROFILES ARE TO BE FIELD VERIFIED BEFORE FABRICATION.  
 D. PAINT ALL HOLLOW METAL DOORS AND FRAMES. COLOR TO BE SELECTED BY ARCHITECT.

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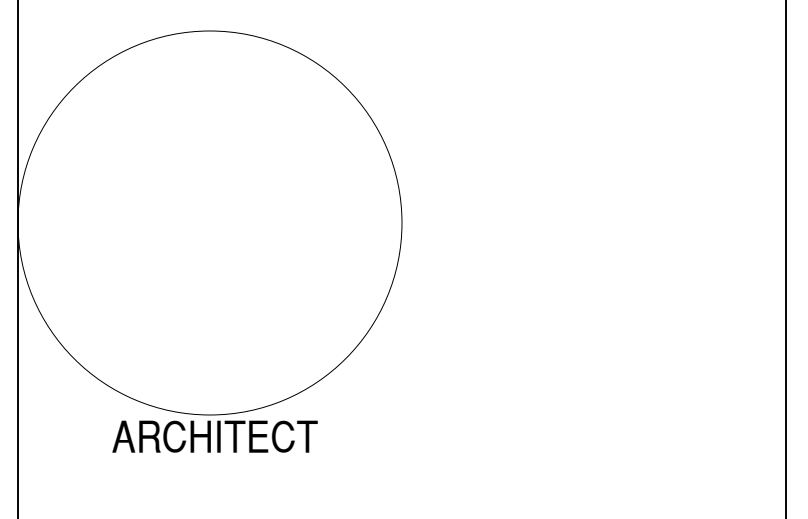
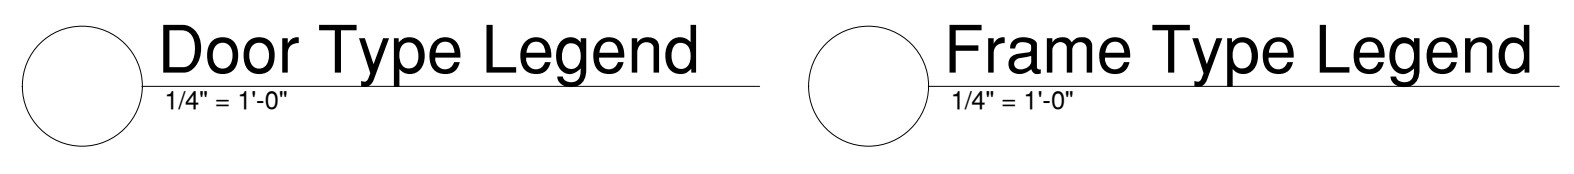
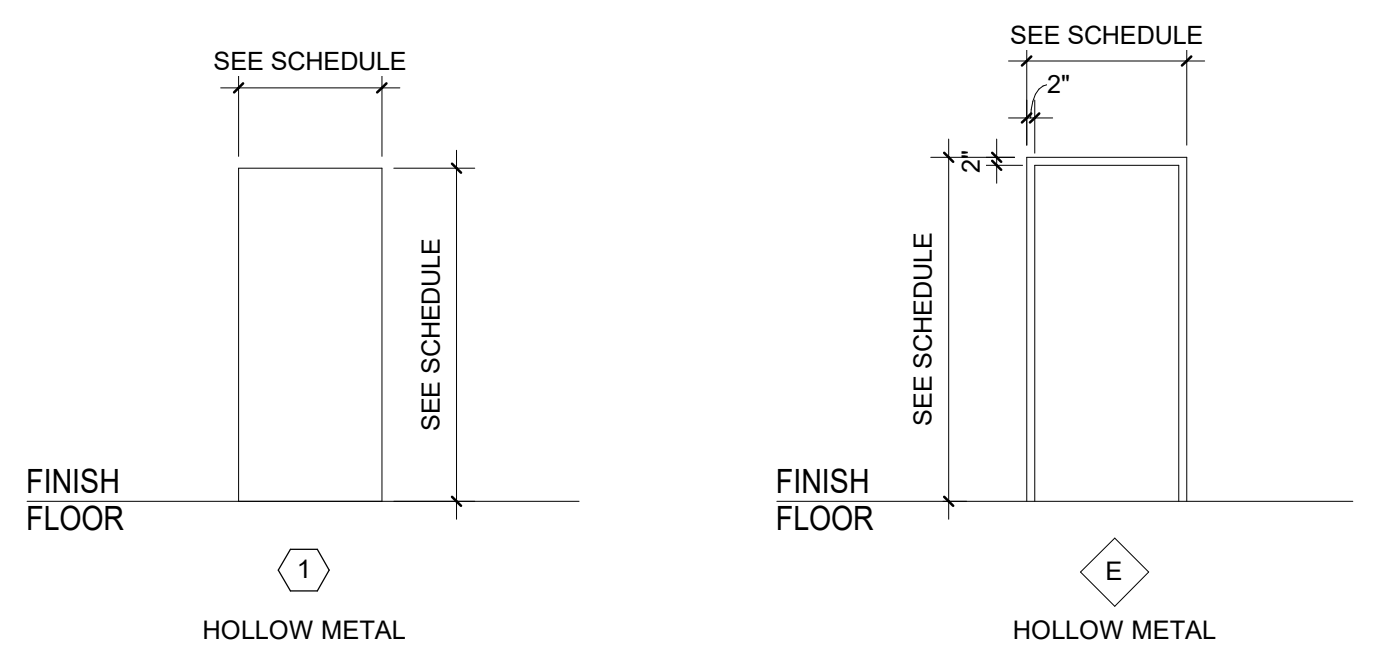
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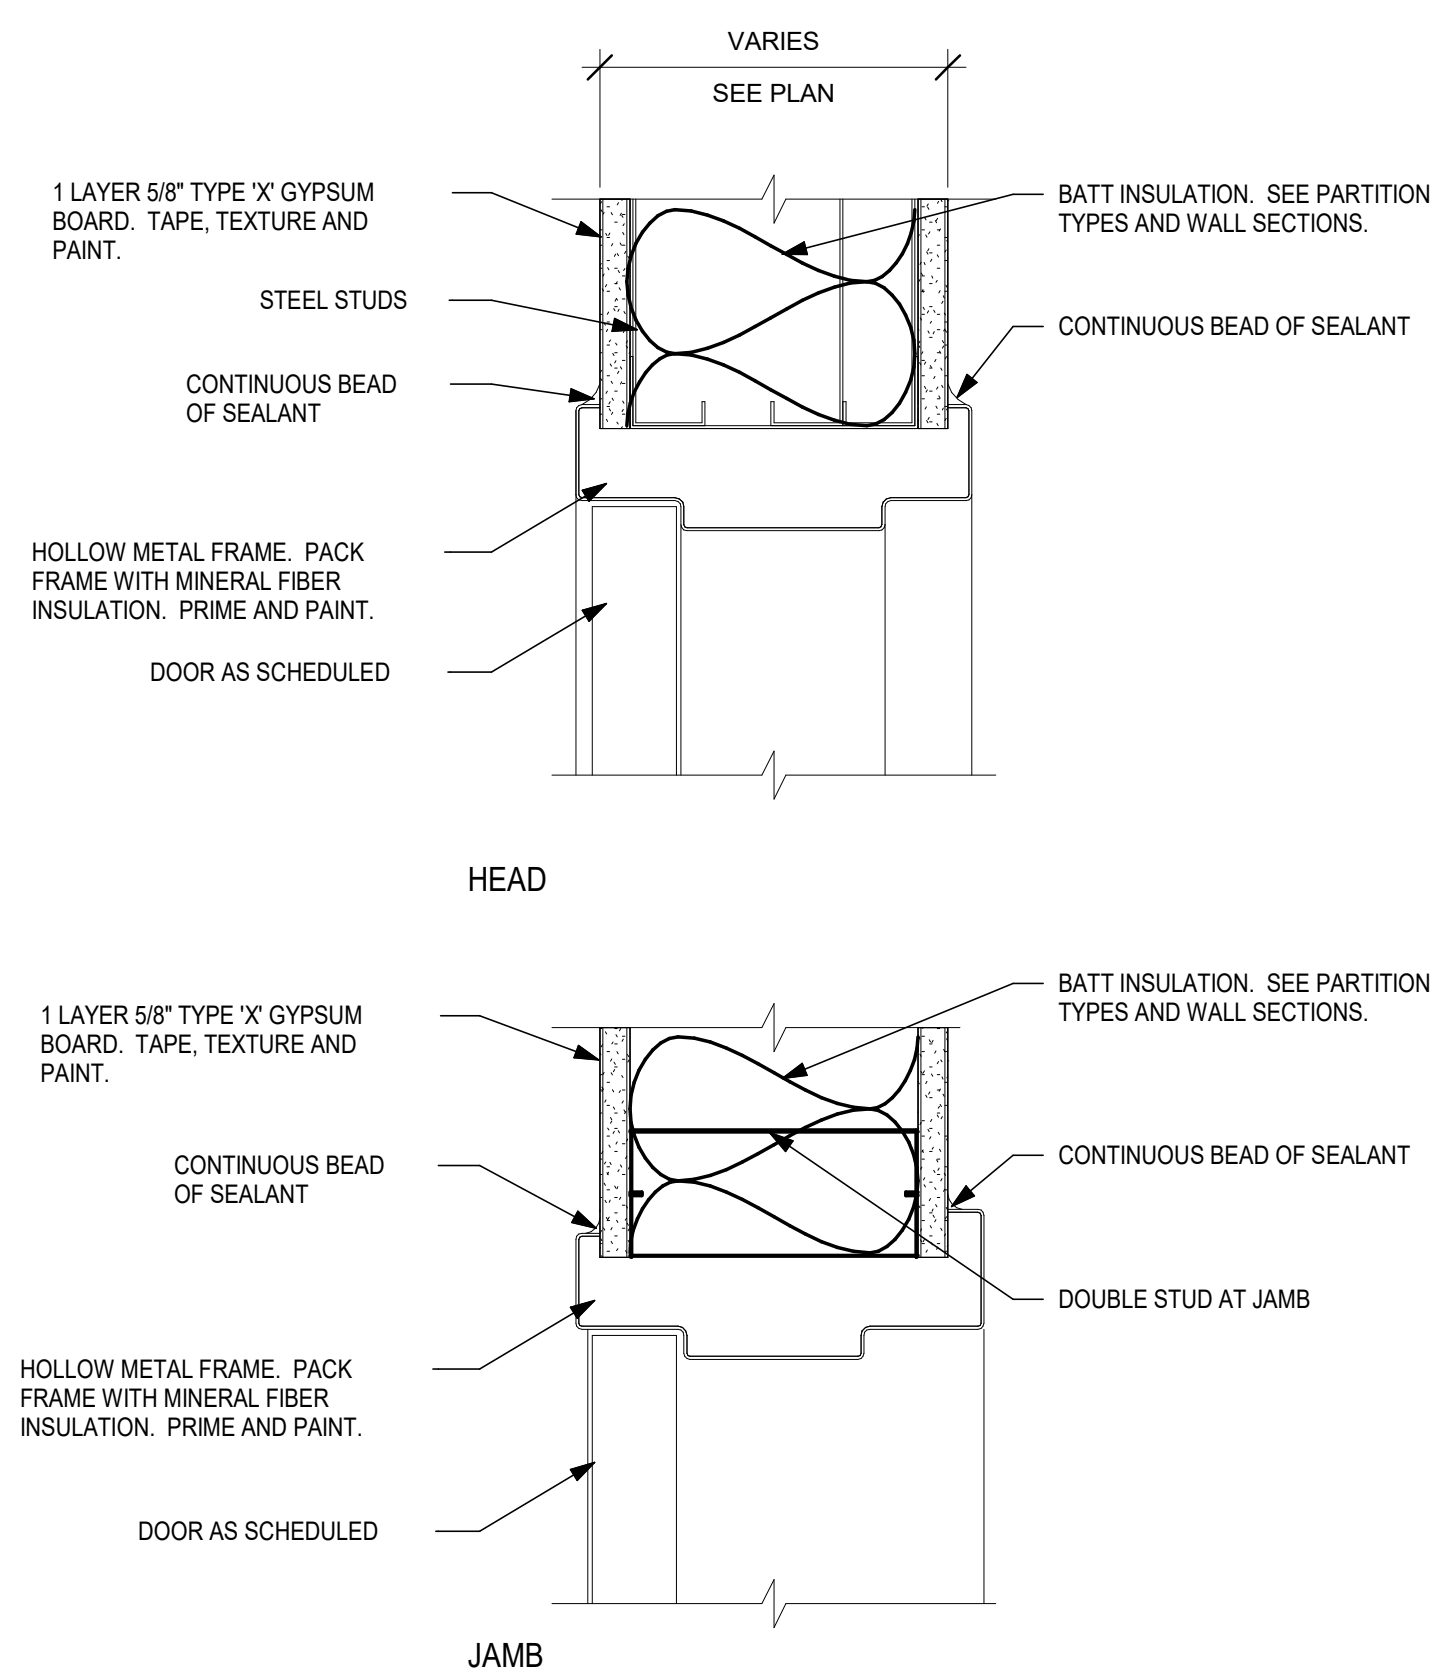
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**AG MOD PHASE 3: NEALE HALL DEMO**


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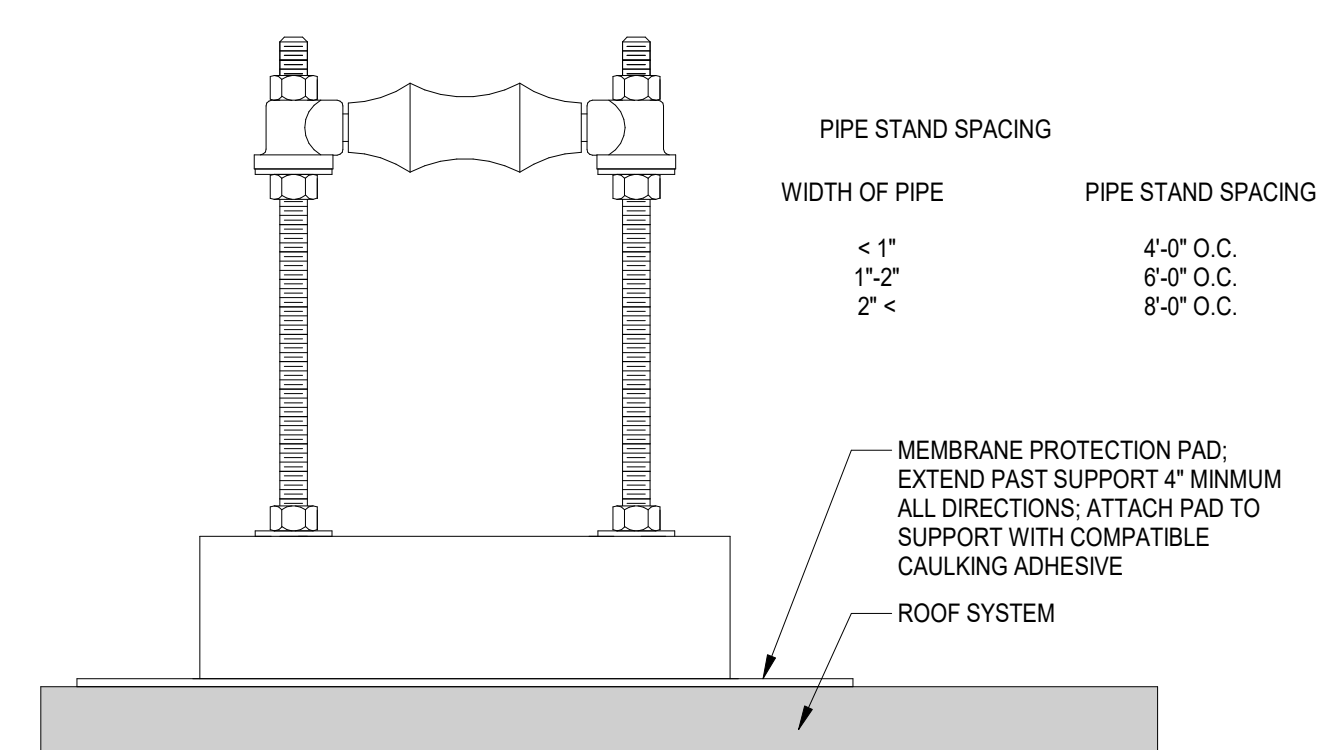
MARCH 12, 2024



**A1 DR INTERIOR HOLLOW METAL DOOR**  
3" = 1'-0"



**A2 RF TPO TERMINATION BAR**  
3" = 1'-0"

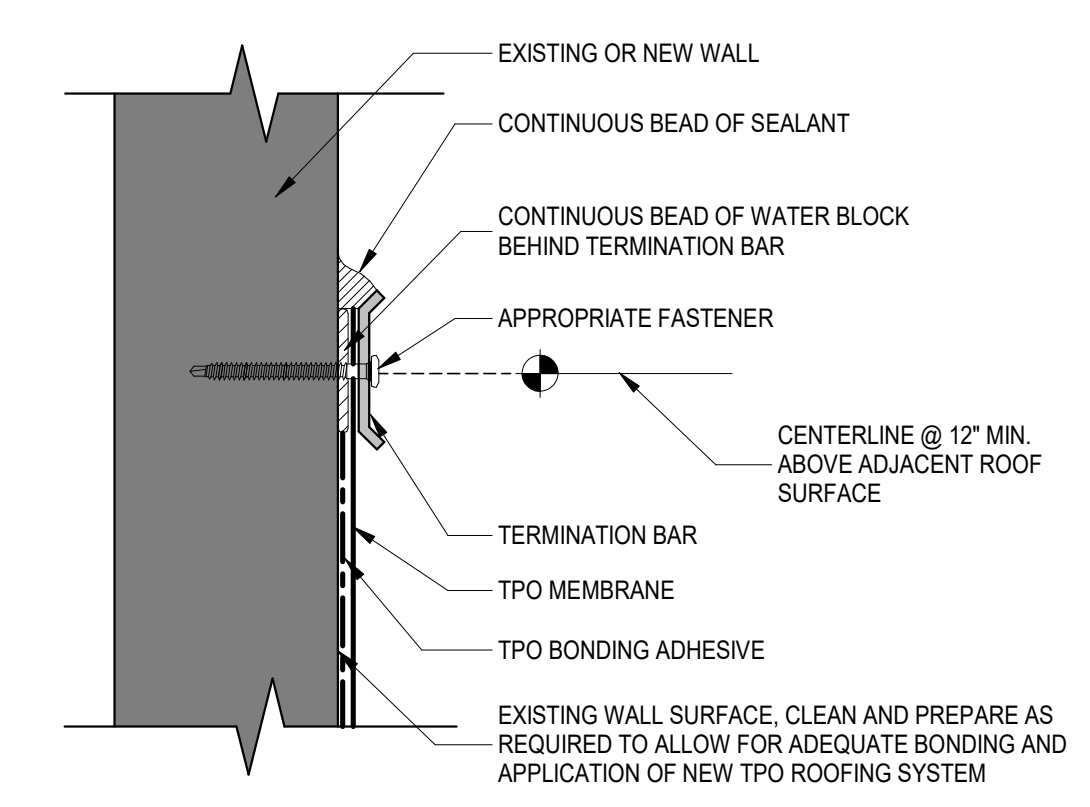

**A4 RF PIPE STAND**  
1" = 1'-0"

| MARK | DATE | DESCRIPTION |
|------|------|-------------|
|      |      |             |

ISSUE:  
 DATE:  
 PROJECT NO: 773B  
 DRAWN BY: JRC  
 CHECKED BY: SBJ

SHEET TITLE  
 DETAILS

**A-601**

3/14/2024 4:59:52 PM

School Information

PLUMBING SYMBOL LEGEND

MEDICAL GAS SYMBOLS

Table with 3 columns: SYMBOL, ABBREVIATION, DESCRIPTION. Includes MA (Medical Air), N (Nitrogen), NO (Nitrogen Oxide), O (Oxygen), MV (Medical Vacuum), IA (Instrument Air), WAGD (Waste Anesthesia Gas Disposal), DA (Dental Air), DV (Dental Vacuum), and Medical Valve Box/Drop symbols.

PROCESS GASES


Table with 3 columns: SYMBOL, ABBREVIATION, DESCRIPTION. Includes CDA (Compressed Dry Air), CO2 (Carbon Dioxide), AR (Argon), AC (Acetylene), HE (Helium), H (Hydrogen), LN (Liquid Nitrogen), LOX (Liquid Oxygen), and O (Oxygen).

PLUMBING FIXTURE & EQUIPMENT SYMBOL


Table with 2 columns: SYMBOL, DESCRIPTION. Lists plumbing fixtures like P1 (Water Closets), P2 (Urinals), P3 (Lavatories), P4 (Sinks), P6 (Service Sinks), P7 (Water Coolers/Drinking Fountains), P8 (Showers/Bathrooms), P9 (Water Hammers/Shock Absorbers), P10 (Expansion Tank), P11 (Hose Bibbs), P12 (Hydrants), P13 (Supply Boxes), P14 (Washer Boxes), P15 (Eye Wash/Eye Wash Showers), P16 (Clinic Sinks), P17 (Trap Primer), F01 (Floor Drains), F02 (Roof Drains), F03 (Overflow Drains), F04 (Downspout Nozzles), AD1 (Area Drains), and DD1 (Deck Drains). Also lists equipment like TMV-1 (Thermostatic Mixing Valve), DWH-1 (Domestic Water Heater), EWH-1 (Electric Water Heater), IWH-1 (Instantaneous Water Heater), RCP-1 (Recirculation Pump), EXP-1 (Expansion Tank), RPZ-1 (Reduced Pressure Zone Backflow), BFP-1 (Double Check Backflow), GGI-1 (Grease Interceptor), OI-1 (Oil Interceptor), OS-1 (Oil/Sand Interceptor), AN-1 (Acid Neutralizer), LI-1 (Lint Interceptor), GM-1 (Gas Meter), REG-1 (Regulator), WPRV-1 (Water Pressure Reducing Valve), and ETP-1 (Electronic Trap Primer).

NOTE: NOT ALL FIXTURE & EQUIPMENT SYMBOLS APPLY TO THIS PROJECT


SECTION SYMBOL

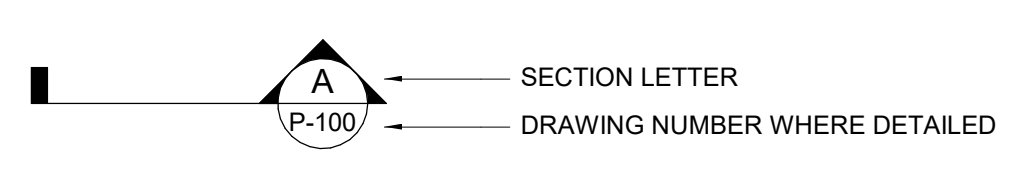

DETAIL SYMBOL

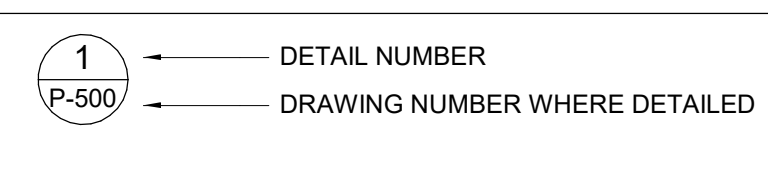

SECTION, ELEVATION, AND DETAIL TITLES

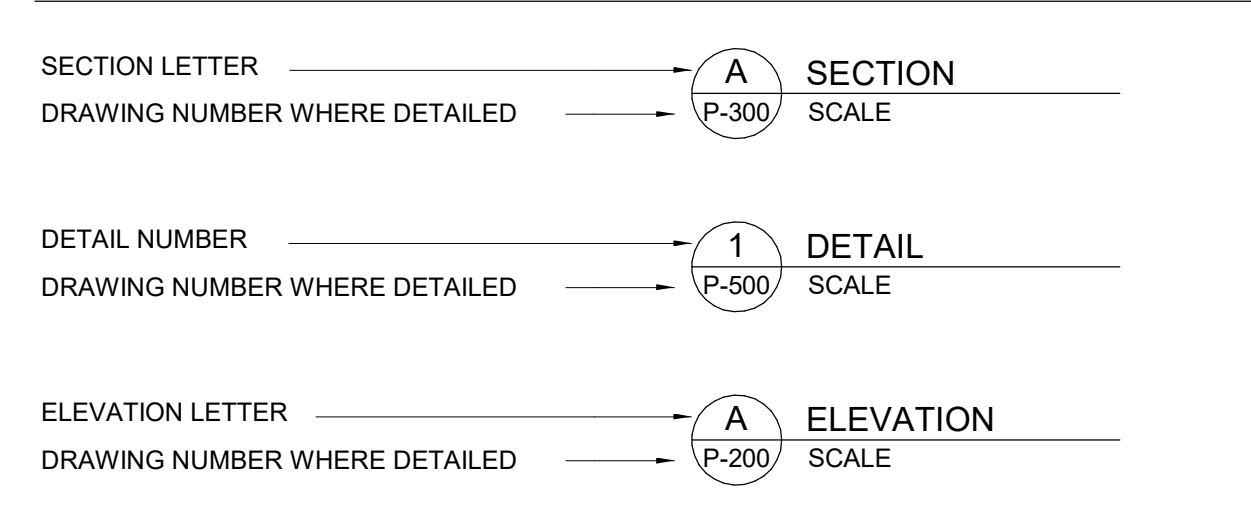

PIPING SYMBOLS

Table with 3 columns: SYMBOL, ABBREVIATION, DESCRIPTION. Lists various piping symbols like AV (Acid Vent), AW (Acid Waste), CA (Compressed Air), CND (Condensate Drain), DCW (Domestic Cold Water), DHW (Domestic Hot Water), DHWR (Domestic Hot Water Return), DHW 140°F (140° Domestic Hot Water), DHWR 140°F (140° Domestic Hot Water Return), ROS (Reverse Osmosis Supply), ROR (Reverse Osmosis Return), MU (Make-Up Water), NPW (Non-Potable Water), V (Vent), DIS (Deionized Water Supply), DIR (Deionized Water Return), SAN (Sanitary Sewer), GW (Grease Waste), GV (Grease Vent), RD (Storm/ROOF DRAIN), ORD (Over/LOW ROOF DRAIN), LPG (Liquefied Petroleum Gas), G @ 14"w.c. (Natural Gas-Low Pressure), G @ 2PSIG (Natural Gas-Medium Pressure), NGH (Natural Gas-High Pressure), IRR (Irrigation), SCW (Soft Cold Water), SHW (Soft Hot Water), SHWR (Soft Hot Water Return), TWR (Tempered Water Return), TW (Tempered Water), PD (Pumped Discharge Line), ICW (Industrial Cold Water), IHW (Industrial Hot Water), IHWR (Industrial Hot Water Return), INW (Industrial Waste), IA (Instrument Compressed Air), IW (Indirect Waste), and LA (Lab Compressed Air).

SITE UTILITY SYMBOLS

Table with 3 columns: DESCRIPTION, NEW, EXISTING. Lists symbols for Sanitary Sewer, Cold Water Supply, Fire Protection, Natural Gas, Storm Drain, Irrigation, Valve with Valve Box, Fire Hydrant, Fire Department Inlet Connection, Construction, Thrust Block, Cleanout, Power Pole, Fencing, Light Pole, Water Meter, Natural Gas Meter, Gate Valve, Valve in Riser, Post Indicator Valve, Reduced Pressure Backflow Preventer, Sanitary Manhole, and Slope and Lineal Footage.

VALVE SYMBOLS

Table with 2 columns: SYMBOL, DESCRIPTION. Lists symbols for Gate Valve, Globe Valve, Solenoid Valve, OS&Y Valve, Butterfly Valve, Ball Valve, Check Valve, Plug Valve, Balancing Valve/Circuit Setter Device, Pressure Reducing Valve, Regulating/Sustaining Valve, 2-Way Control Valve, 3-Way Modulating Control Valve, Fuel Gas Pressure Regulator, Pressure Relief Valve, Temperature and Pressure Relief Valve, Drain Valve, Valve in Vertical, Flow Switch, Diaphragm (Process Systems), Reduced Pressure Backflow Preventer (RPZ), Atmospheric Vacuum Breaker, and Pressure Style Vacuum Breaker.

NOTE: NOT ALL ABBREVIATIONS OR SYMBOLS APPLY TO THIS PROJECT

ABBREVIATIONS

Table with 2 columns: ABBREVIATION, DESCRIPTION. Lists abbreviations like AFF (Above Finished Floor), AFG (Above Finished Grade), ANT (Acid Neutralizing Tank), AVTR (Acid Resistant Vent Through Roof), B.C. (Balancing Cock), BOP (Bottom of Pipe), BTU (British Thermal Unit), BTUH (BTU Per Hour), CWB (Clothes Washer Box), CFH (Cubic Feet Per Hour), CO (Cleanout), COTG (Cleanout to Grade), CP (Circulation Pump), CWV (Combination Waste and Vent), DCO (Double Cleanout), DCOTG (Double Cleanout to Grade), DF (Drinking Fountain Down), DN (Downspout), DSN (Downspout Nozzle), EL (Elevation), EWH (Electric Water Heater), EWC (Electric Water Cooler), EEW (Emergency Eye Wash), ES (Emergency Shower), ESEW (Emergency Shower Eye Wash), F (Degrees Fahrenheit), FCO (Floor Cleanout), FFE (Finished Floor Elevation), FEET (Feet), FOS (Fuel Oil Supply), FOR (Fuel Oil Return), FOV (Fuel Oil Vent), FV (Flush Valve), GD (Gutter Drain), GI (Grease Interceptor), GPH (Gallons Per Hour), GPM (Gallons Per Minute), GWH (Gas Water Heater), GVTR (Grease Vent Through Roof), HB (Hose Bibb), HD (Head), HP (Horsepower), IN (Inches), INV (Invert), KW (Kilowatt), MBh (1,000 BTUH), MV (Mixing Valve), NA (Not Applicable), NIC (Not in Contract), No. # (Number), N.C. (Normally Closed), N.O. (Normally Open), OS&Y (Outside Screw and Yoke), PH (Phase), PH (Powers of Hardness), PSIG (Pounds Per Square Inch Gauge), SP (Static Pressure), TD (Trench Drain), TYP (Typical), YB (Yard Box), YH (Yard Hydrant), WCO (Wall Cleanout), WC (Water Closet).

SCHEMATIC SYMBOLS

Table with 3 columns: SYMBOL, ABBREVIATION, DESCRIPTION. Lists schematic symbols like XX (Keyed Note), Point of Connection to Existing, Extent of Demolition, Existing Pipe to be Removed, New Piping, Existing Piping to Remain, New Pipe Connection to Existing Piping, Slope of Pipe, Direction of Flow, Drop in Pipe, Rise in Pipe, Top Connection, 45° or 90°, Bottom Connection, 45° or 90°, Capped Outlet, Side Connection, Union, Flanged Union, Orifice Union, Reducer or Increaser, Eccentric Reducer, Pipe Guide, Flexible Connection, Universal Temperature-Pressure Fitting (Pet's Plug), Strainer with Blowdown Valve & Hose Bibb, Thermometer, Pressure Gauge and Gauge Cock, Aquastat, Water Hammer Arrestor, Test Plug (Press/Temp), Penetration, Manual Air Vent (MAV), Automatic Air Vent (AAV), Floor Sink, Floor Drain, Area Drain, Floor Cleanout/Cleanout to Grade, Two Way or Double Cleanout to Grade, Roof Drain/Overflow Drain/Deck Drain, Trap Primer with Access Panel, Vent Through Roof, Air Gap Fitting, Wall Hydrant, Hose Bibb, Wall Cleanout.

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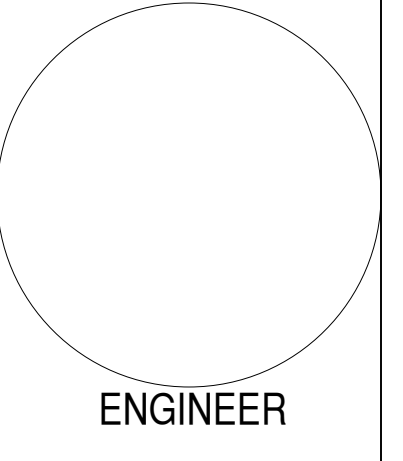
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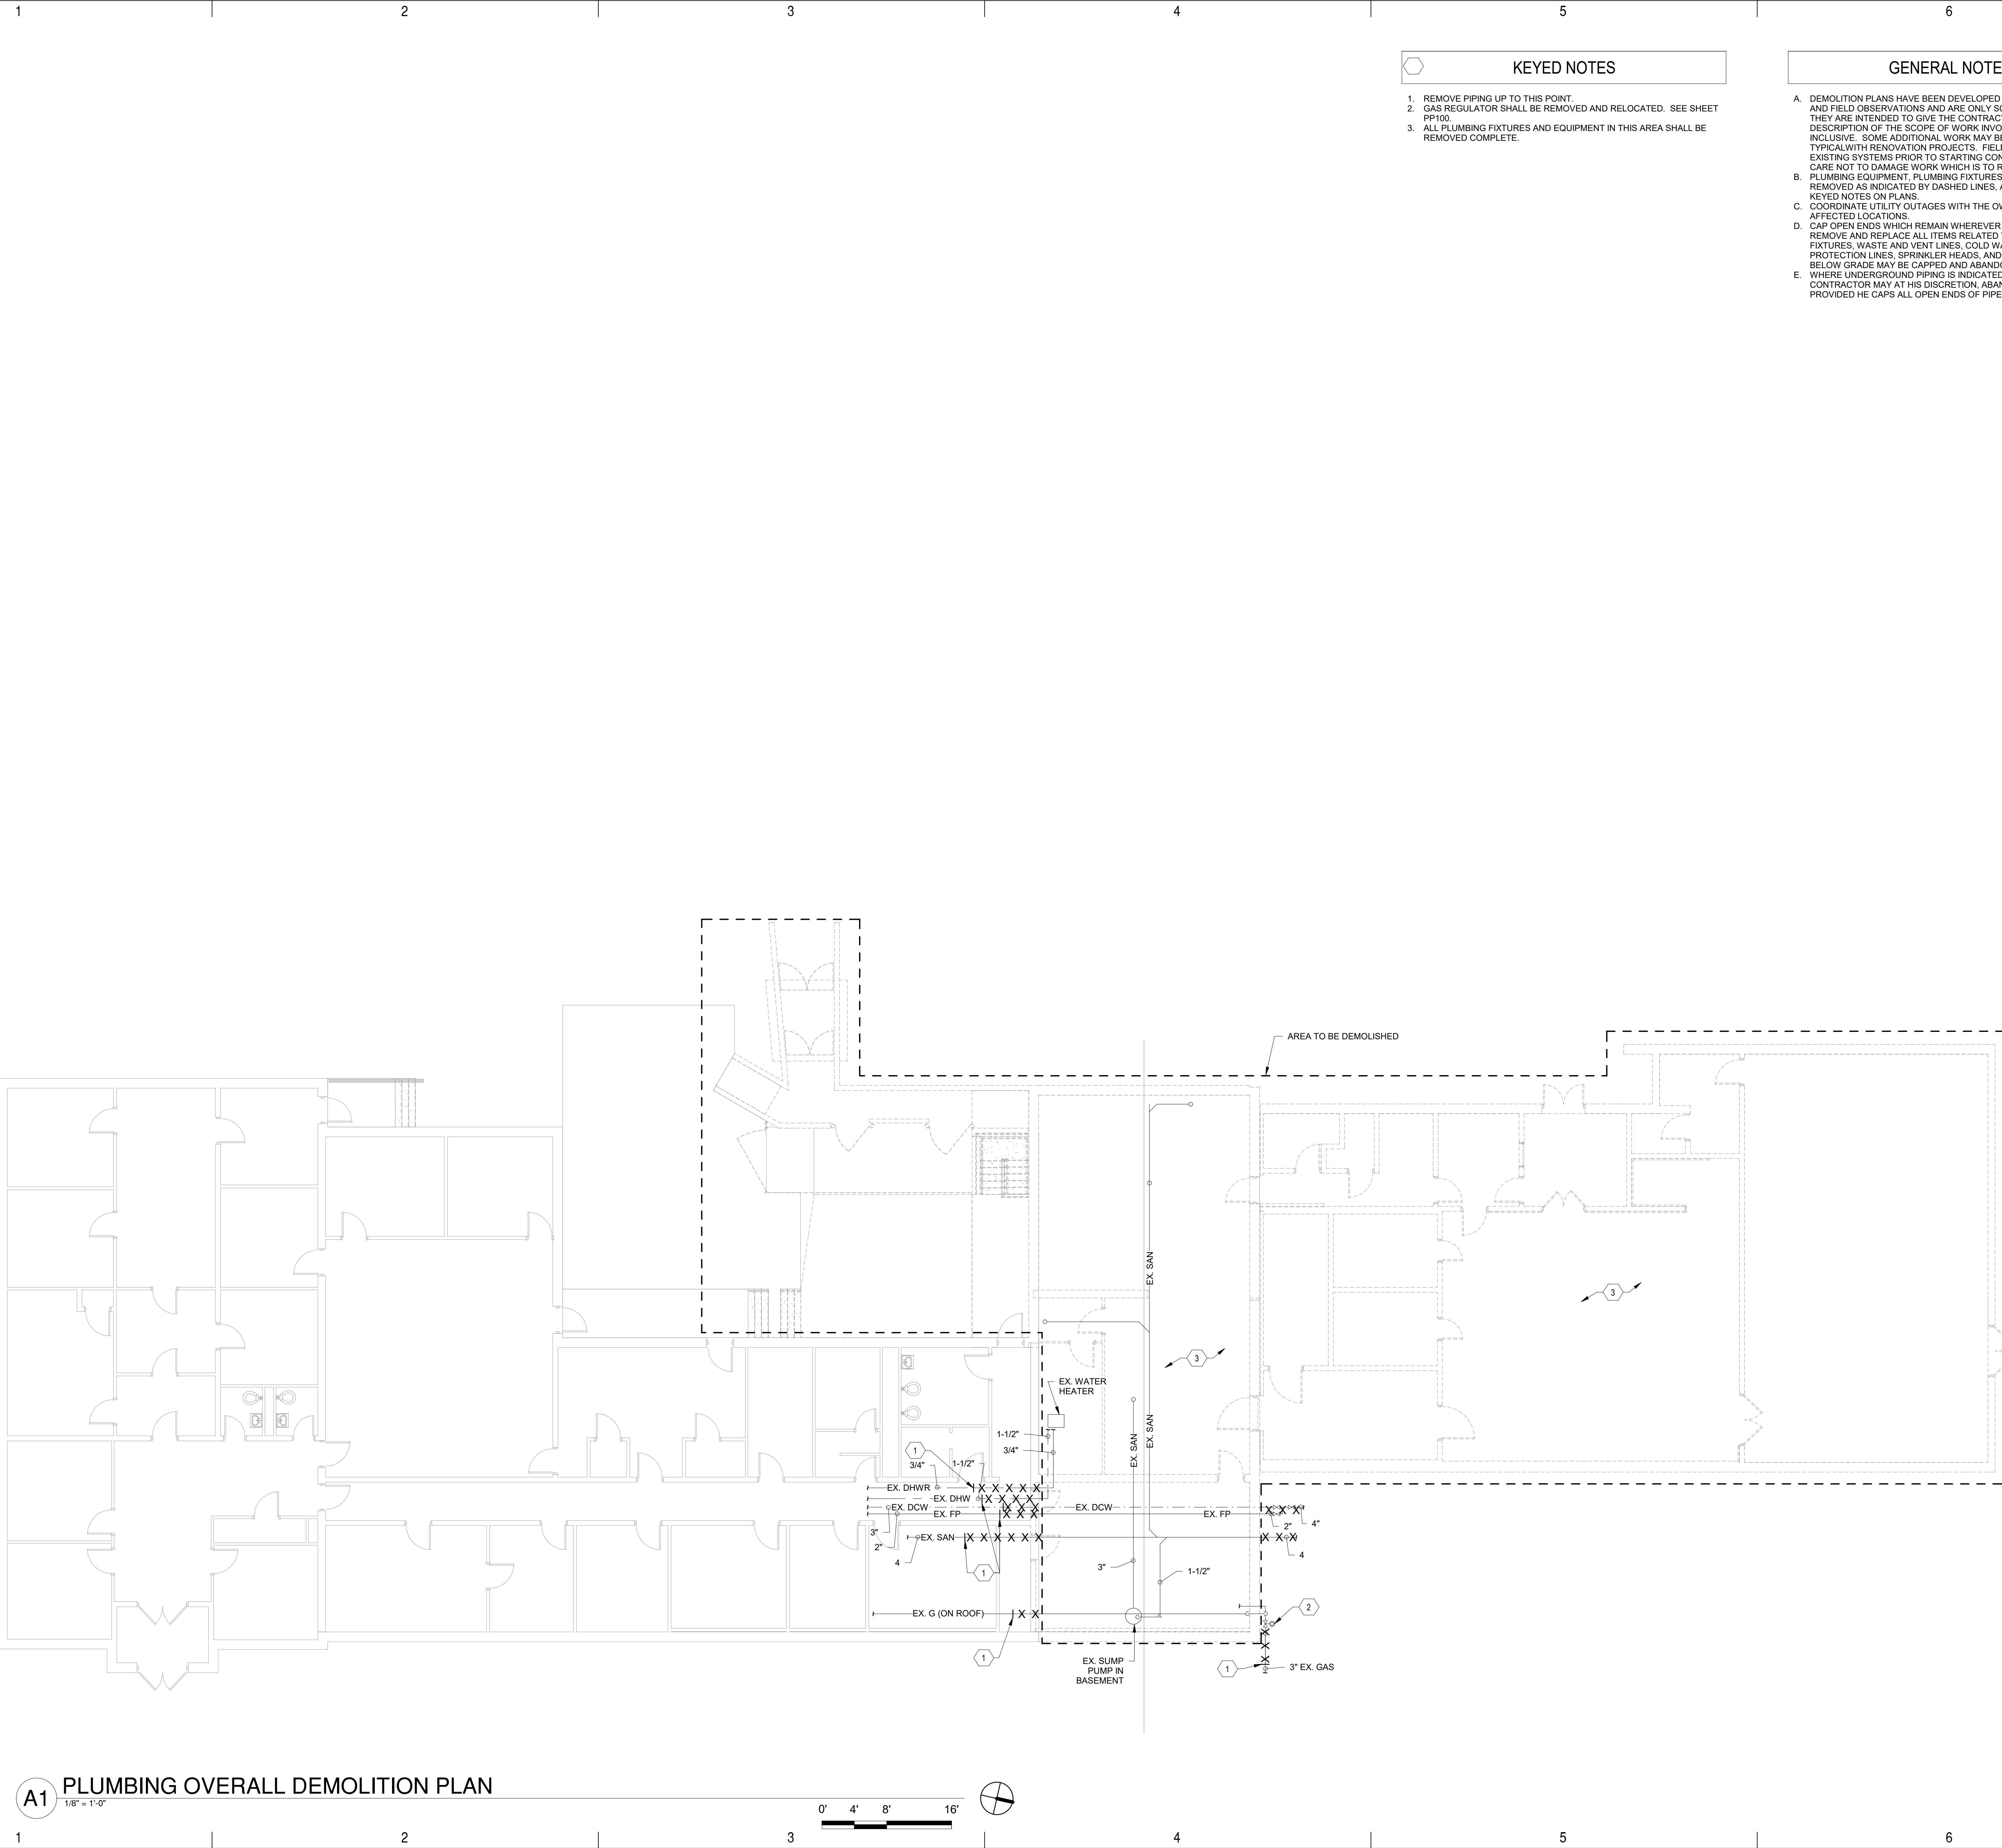
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MARCH 13, 2024

Table with 3 columns: MARK, DATE, DESCRIPTION.

ISSUE:  
DATE:  
PROJECT NO: 773B  
DRAWN BY: DCR  
CHECKED BY: IM

SHEET TITLE  
PLUMBING LEGEND





KEYED NOTES

1. REMOVE PIPING UP TO THIS POINT.
2. GAS REGULATOR SHALL BE REMOVED AND RELOCATED. SEE SHEET PP100.
3. ALL PLUMBING FIXTURES AND EQUIPMENT IN THIS AREA SHALL BE REMOVED COMPLETE.

GENERAL NOTES

- A. DEMOLITION PLANS HAVE BEEN DEVELOPED FROM EXISTING PLANS AND FIELD OBSERVATIONS AND ARE ONLY SCHEMATIC IN NATURE. THEY ARE INTENDED TO GIVE THE CONTRACTOR A GENERAL DESCRIPTION OF THE SCOPE OF WORK INVOLVED, BUT ARE NOT ALL INCLUSIVE. SOME ADDITIONAL WORK MAY BE REQUIRED AS TYPICAL WITH RENOVATION PROJECTS. FIELD VERIFY LOCATIONS OF EXISTING SYSTEMS PRIOR TO STARTING CONSTRUCTION. TAKE CARE NOT TO DAMAGE WORK WHICH IS TO REMAIN.
- B. PLUMBING EQUIPMENT, PLUMBING FIXTURES, PIPES, ETC., SHALL BE REMOVED AS INDICATED BY DASHED LINES, AND/OR "X'S" OR BY KEYED NOTES ON PLANS.
- C. COORDINATE UTILITY OUTAGES WITH THE OWNERS AND USERS AT AFFECTED LOCATIONS.
- D. CAP OPEN ENDS WHICH REMAIN WHEREVER PIPING REMOVED. REMOVE AND REPLACE ALL ITEMS RELATED TO PLUMBING FIXTURES, WASTE AND VENT LINES, COLD WATER, HOT WATER, FIRE PROTECTION LINES, SPRINKLER HEADS, AND GAS PIPING. PIPING BELOW GRADE MAY BE CAPPED AND ABANDONED IN PLACE.
- E. WHERE UNDERGROUND PIPING IS INDICATED TO BE REMOVED, CONTRACTOR MAY AT HIS DISCRETION, ABANDON IN PLACE PROVIDED HE CAPS ALL OPEN ENDS OF PIPE.

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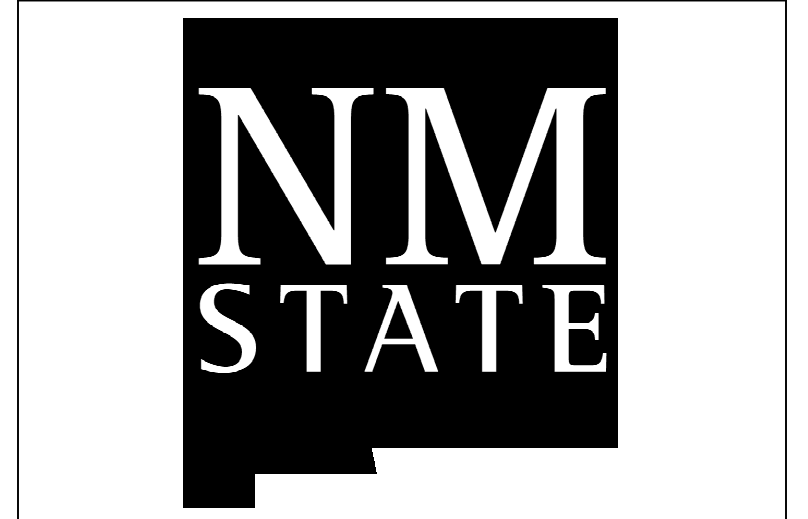
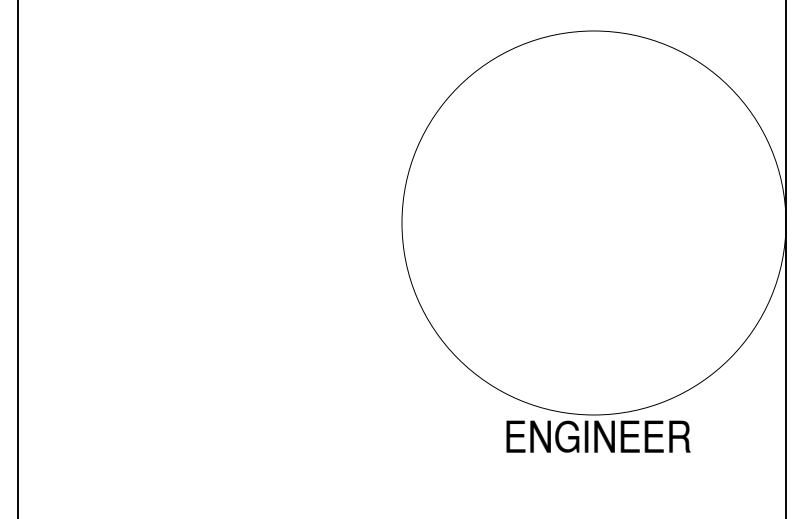
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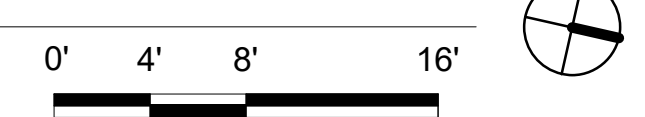
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SHEET TITLE

PLUMBING OVERALL DEMOLITION PLAN

**A1** PLUMBING OVERALL DEMOLITION PLAN

1/8" = 1'-0"



PD100



KEYED NOTES

- 1. ROUTE PIPING BELOW GRADE.
- 2. SEE CIVIL DRAWINGS FOR CONTINUATION.
- 3. INSTALL DOUBLE CLEANOUT TO GRADE IN ACCORDANCE WITH DETAIL B1/P-501.

GENERAL NOTES

- A. ALL NEW SANITARY SEWER PIPING (SAN) SHALL BE INSTALLED BELOW FLOOR UNLESS NOTED OTHERWISE.

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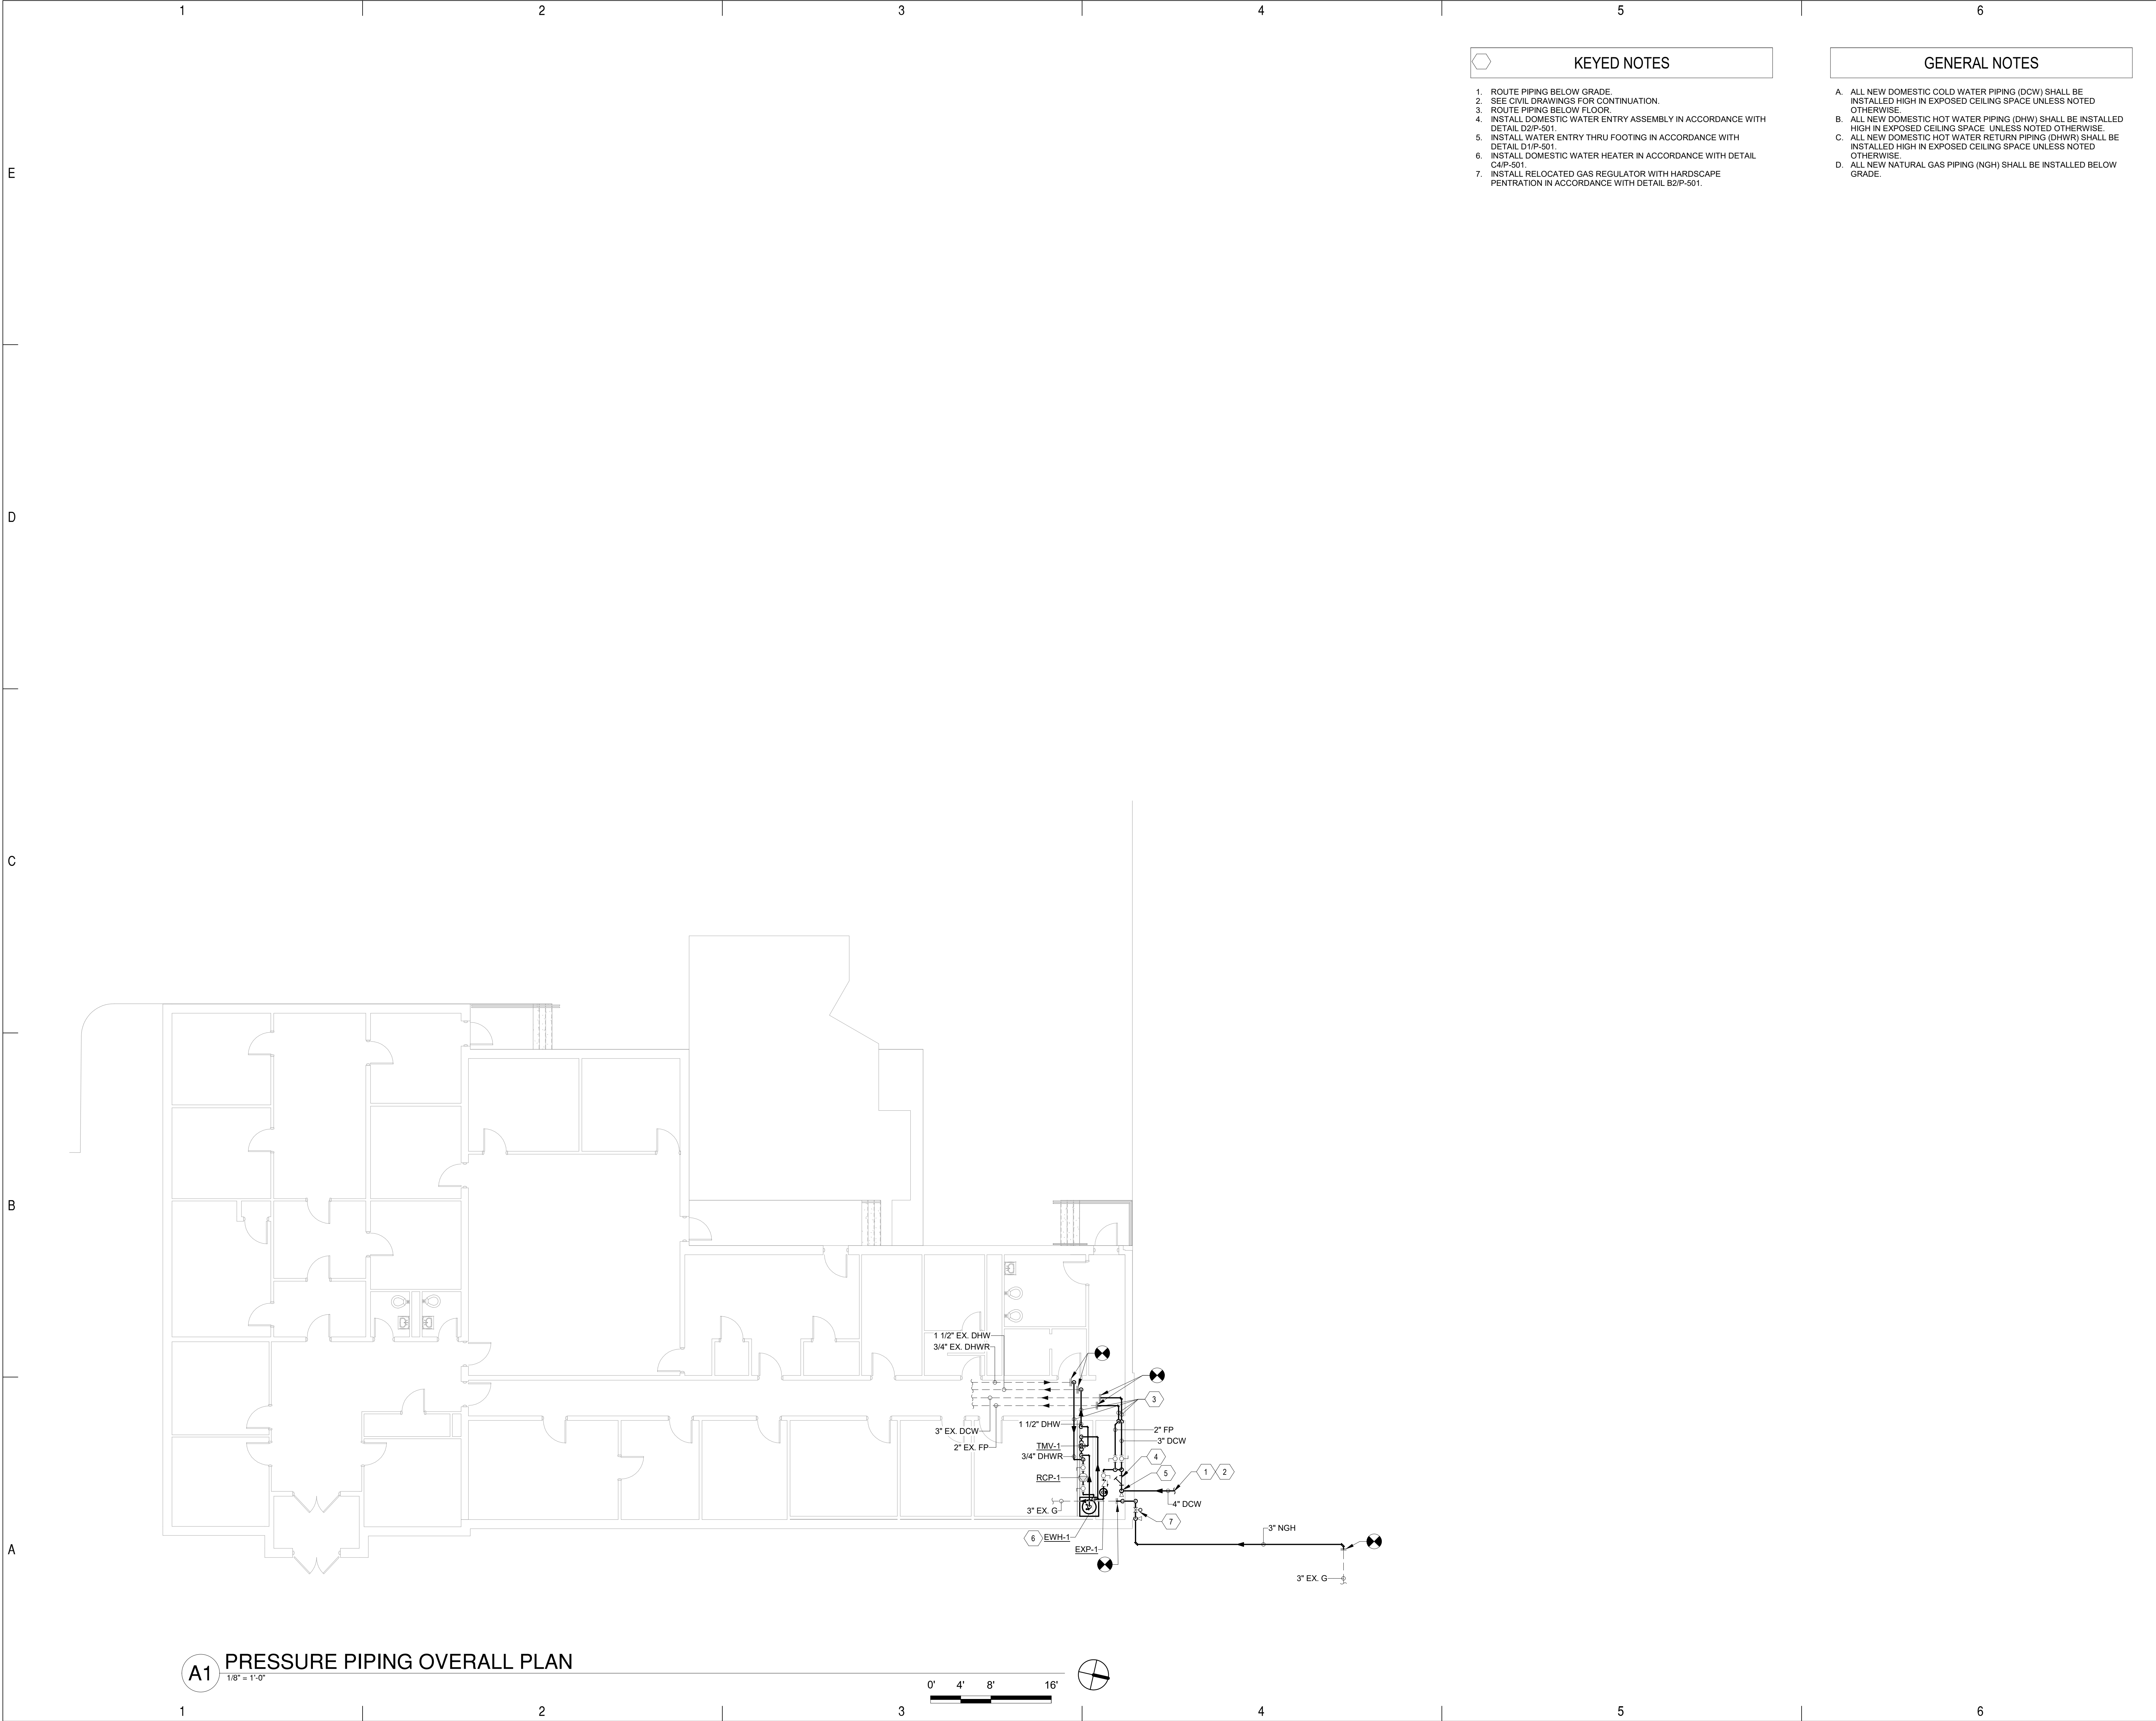
SHEET TITLE  
 WASTE & VENT OVERALL PLAN

PL100


**A1 WASTE & VENT OVERALL PLAN**

1/8" = 1'-0"





A1 PRESSURE PIPING OVERALL PLAN

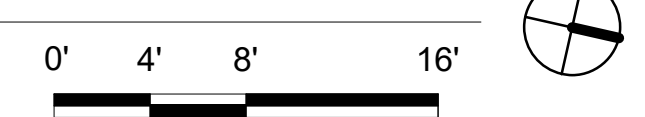

KEYED NOTES

1. ROUTE PIPING BELOW GRADE.
2. SEE CIVIL DRAWINGS FOR CONTINUATION.
3. ROUTE PIPING BELOW FLOOR.
4. INSTALL DOMESTIC WATER ENTRY ASSEMBLY IN ACCORDANCE WITH DETAIL D2/P-501.
5. INSTALL WATER ENTRY THRU FOOTING IN ACCORDANCE WITH DETAIL D1/P-501.
6. INSTALL DOMESTIC WATER HEATER IN ACCORDANCE WITH DETAIL C4/P-501.
7. INSTALL RELOCATED GAS REGULATOR WITH HARDSCAPE PENETRATION IN ACCORDANCE WITH DETAIL B2/P-501.

GENERAL NOTES

- A. ALL NEW DOMESTIC COLD WATER PIPING (DCW) SHALL BE INSTALLED HIGH IN EXPOSED CEILING SPACE UNLESS NOTED OTHERWISE.
- B. ALL NEW DOMESTIC HOT WATER PIPING (DHW) SHALL BE INSTALLED HIGH IN EXPOSED CEILING SPACE UNLESS NOTED OTHERWISE.
- C. ALL NEW DOMESTIC HOT WATER RETURN PIPING (DHW-R) SHALL BE INSTALLED HIGH IN EXPOSED CEILING SPACE UNLESS NOTED OTHERWISE.
- D. ALL NEW NATURAL GAS PIPING (NGH) SHALL BE INSTALLED BELOW GRADE.

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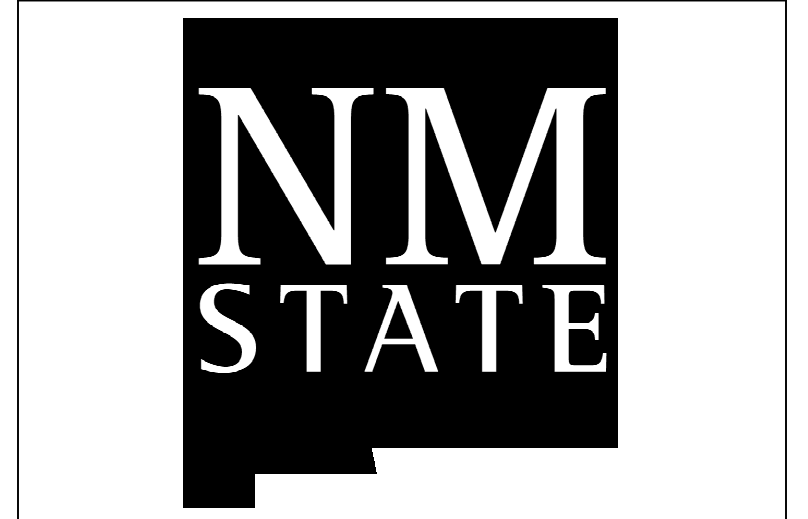
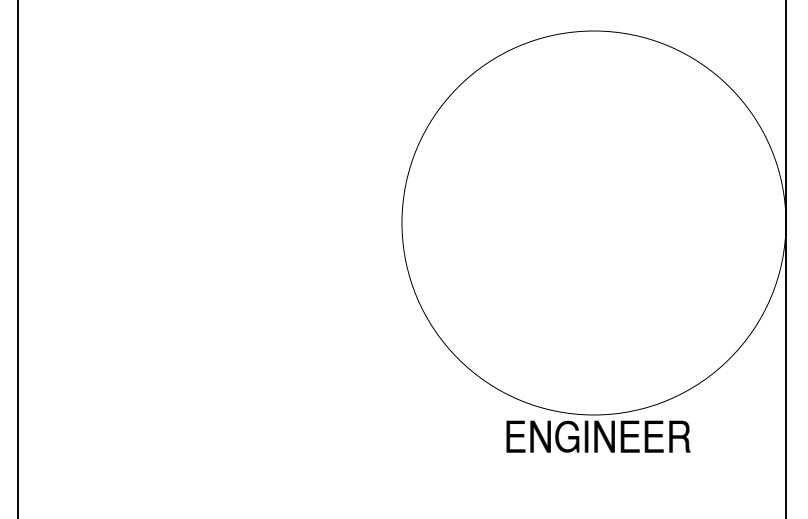
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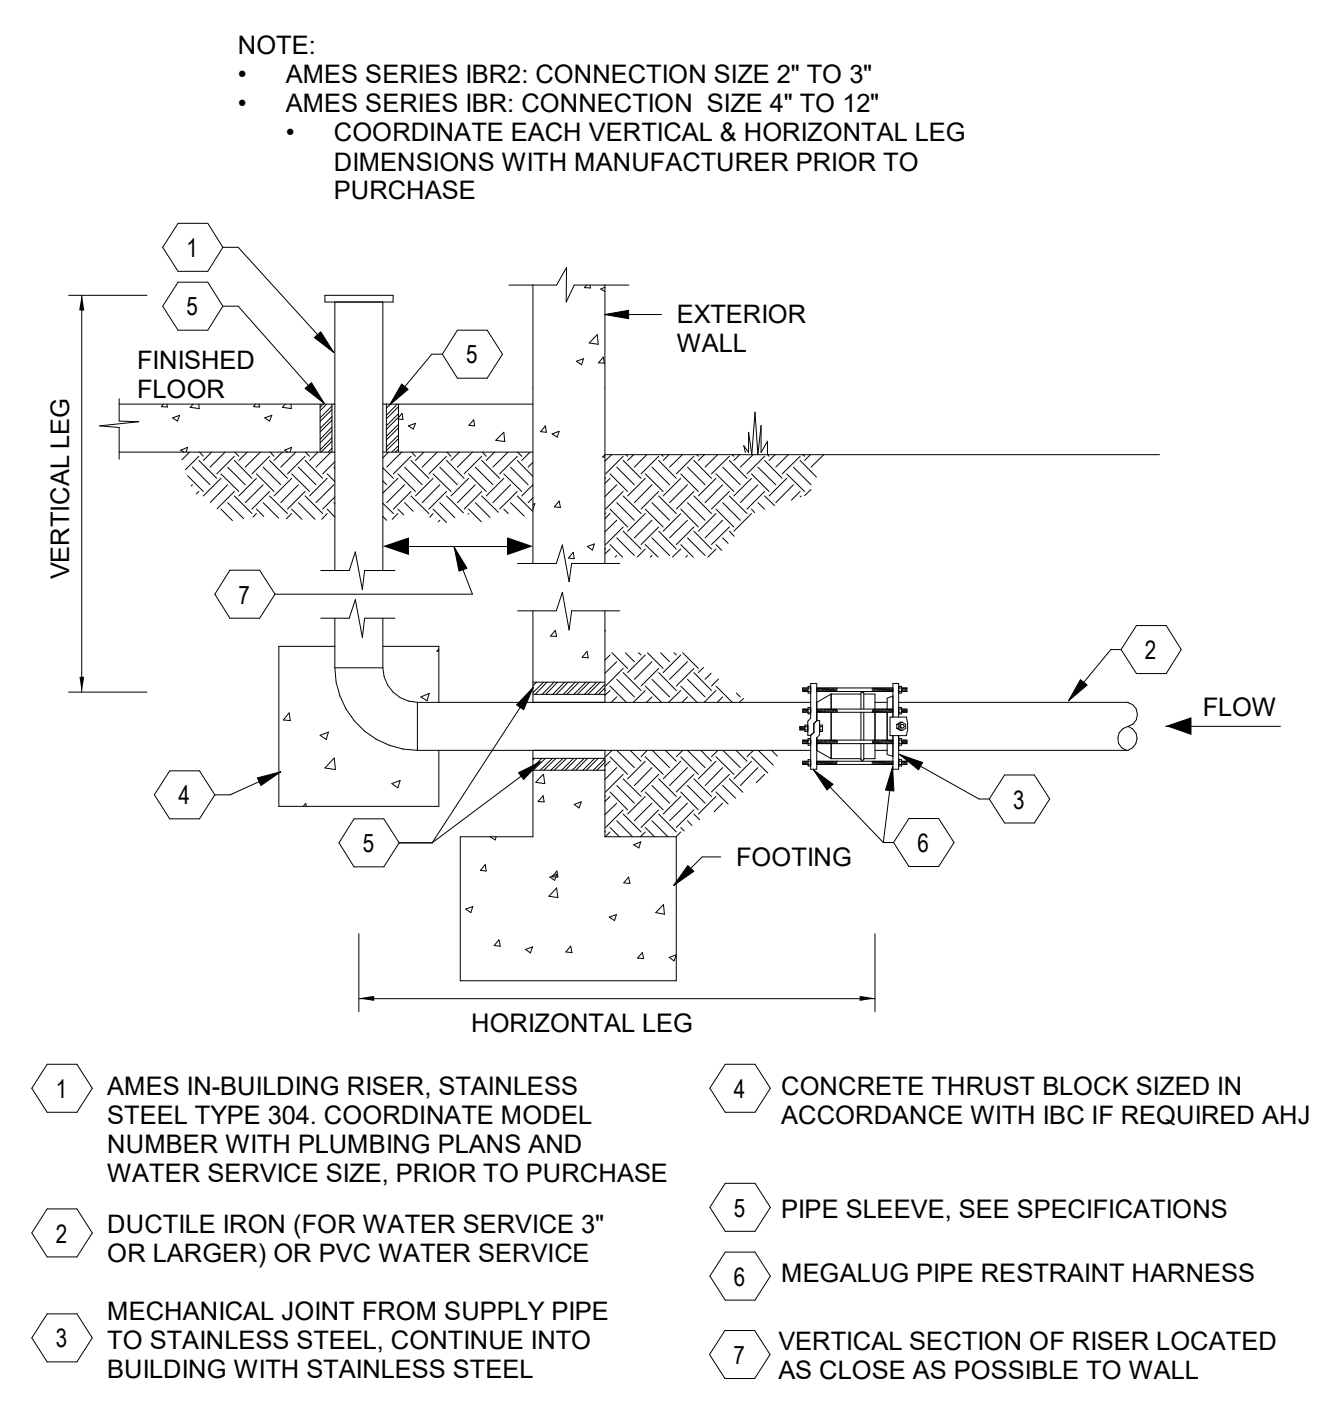
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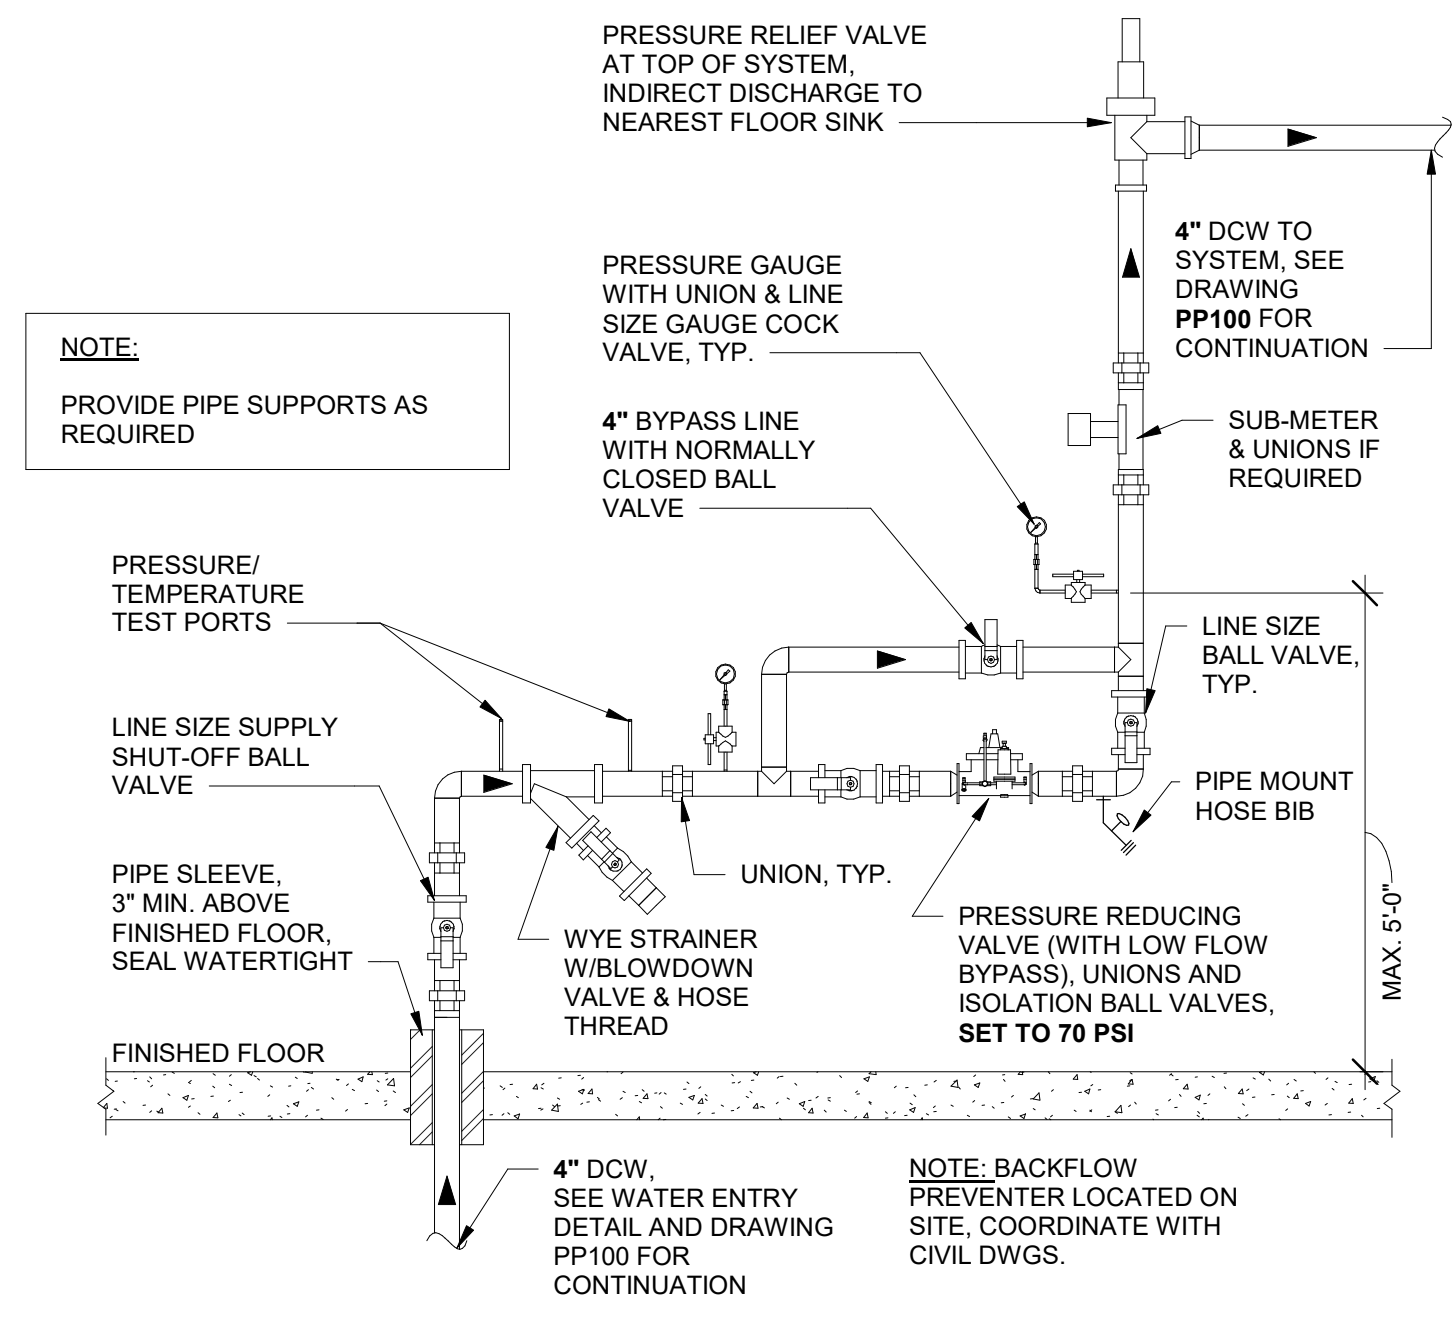
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SHEET TITLE  
 PRESSURE PIPING OVERALL PLAN


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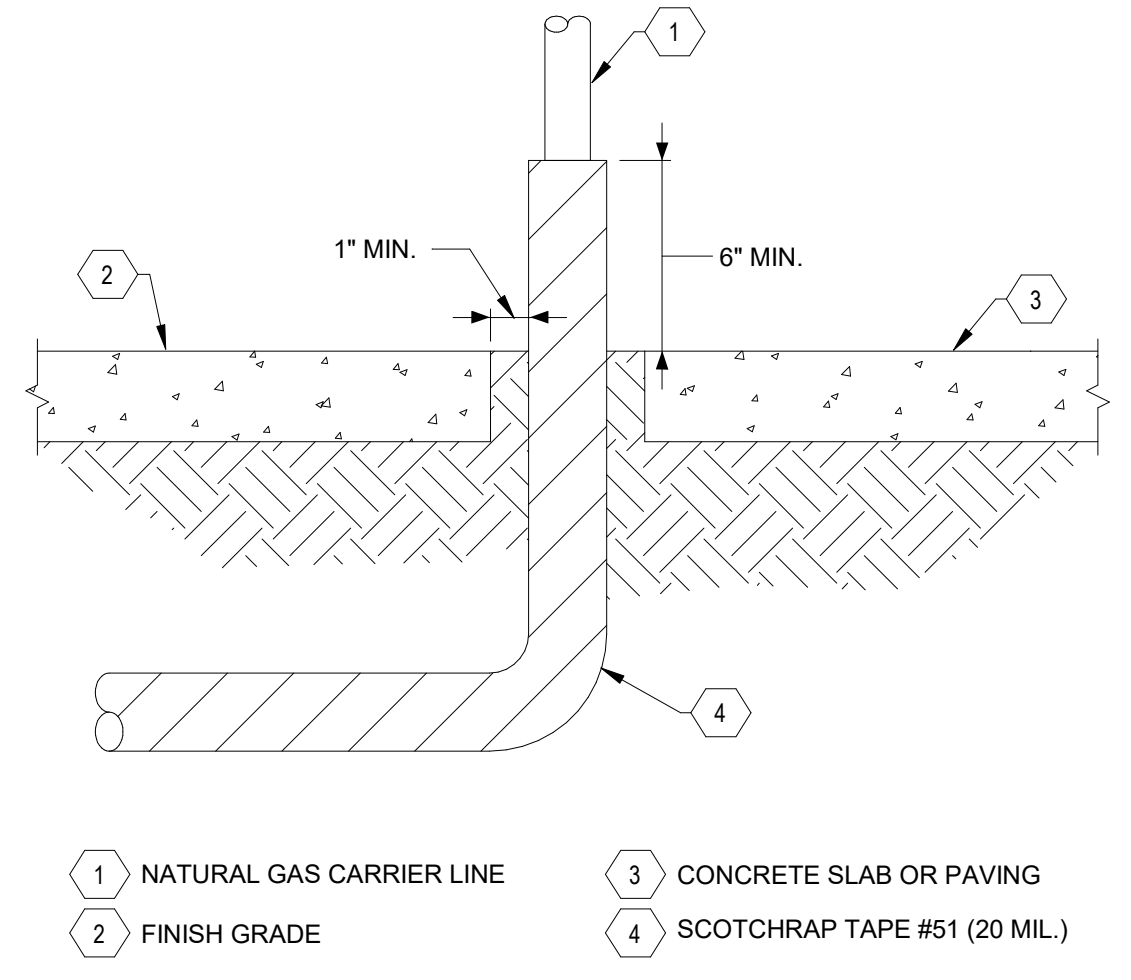
**D1 WATER ENTRY THRU FOOTING DETAIL**  
 SCALE: NOT TO SCALE




**D2 DOMESTIC WATER ENTRY ASSEMBLY**  
 SCALE: NOT TO SCALE



**B1 DOUBLE CLEANOUT TO GRADE DETAIL**  
 SCALE: NOT TO SCALE

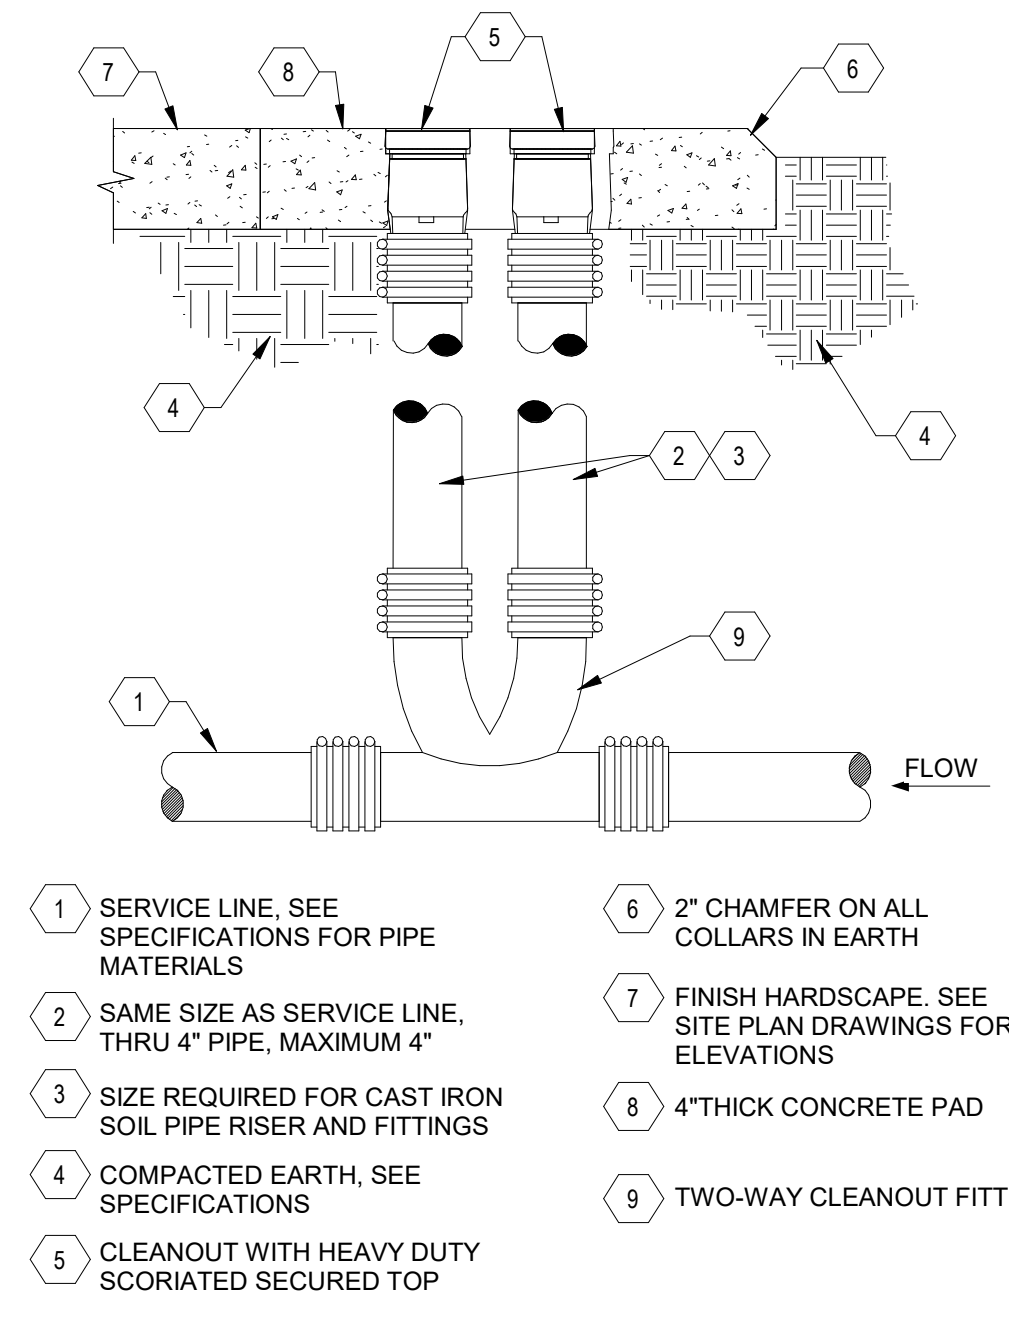

**B2 GAS HARDSCAPE PENETRATION DETAIL**  
 SCALE: NOT TO SCALE

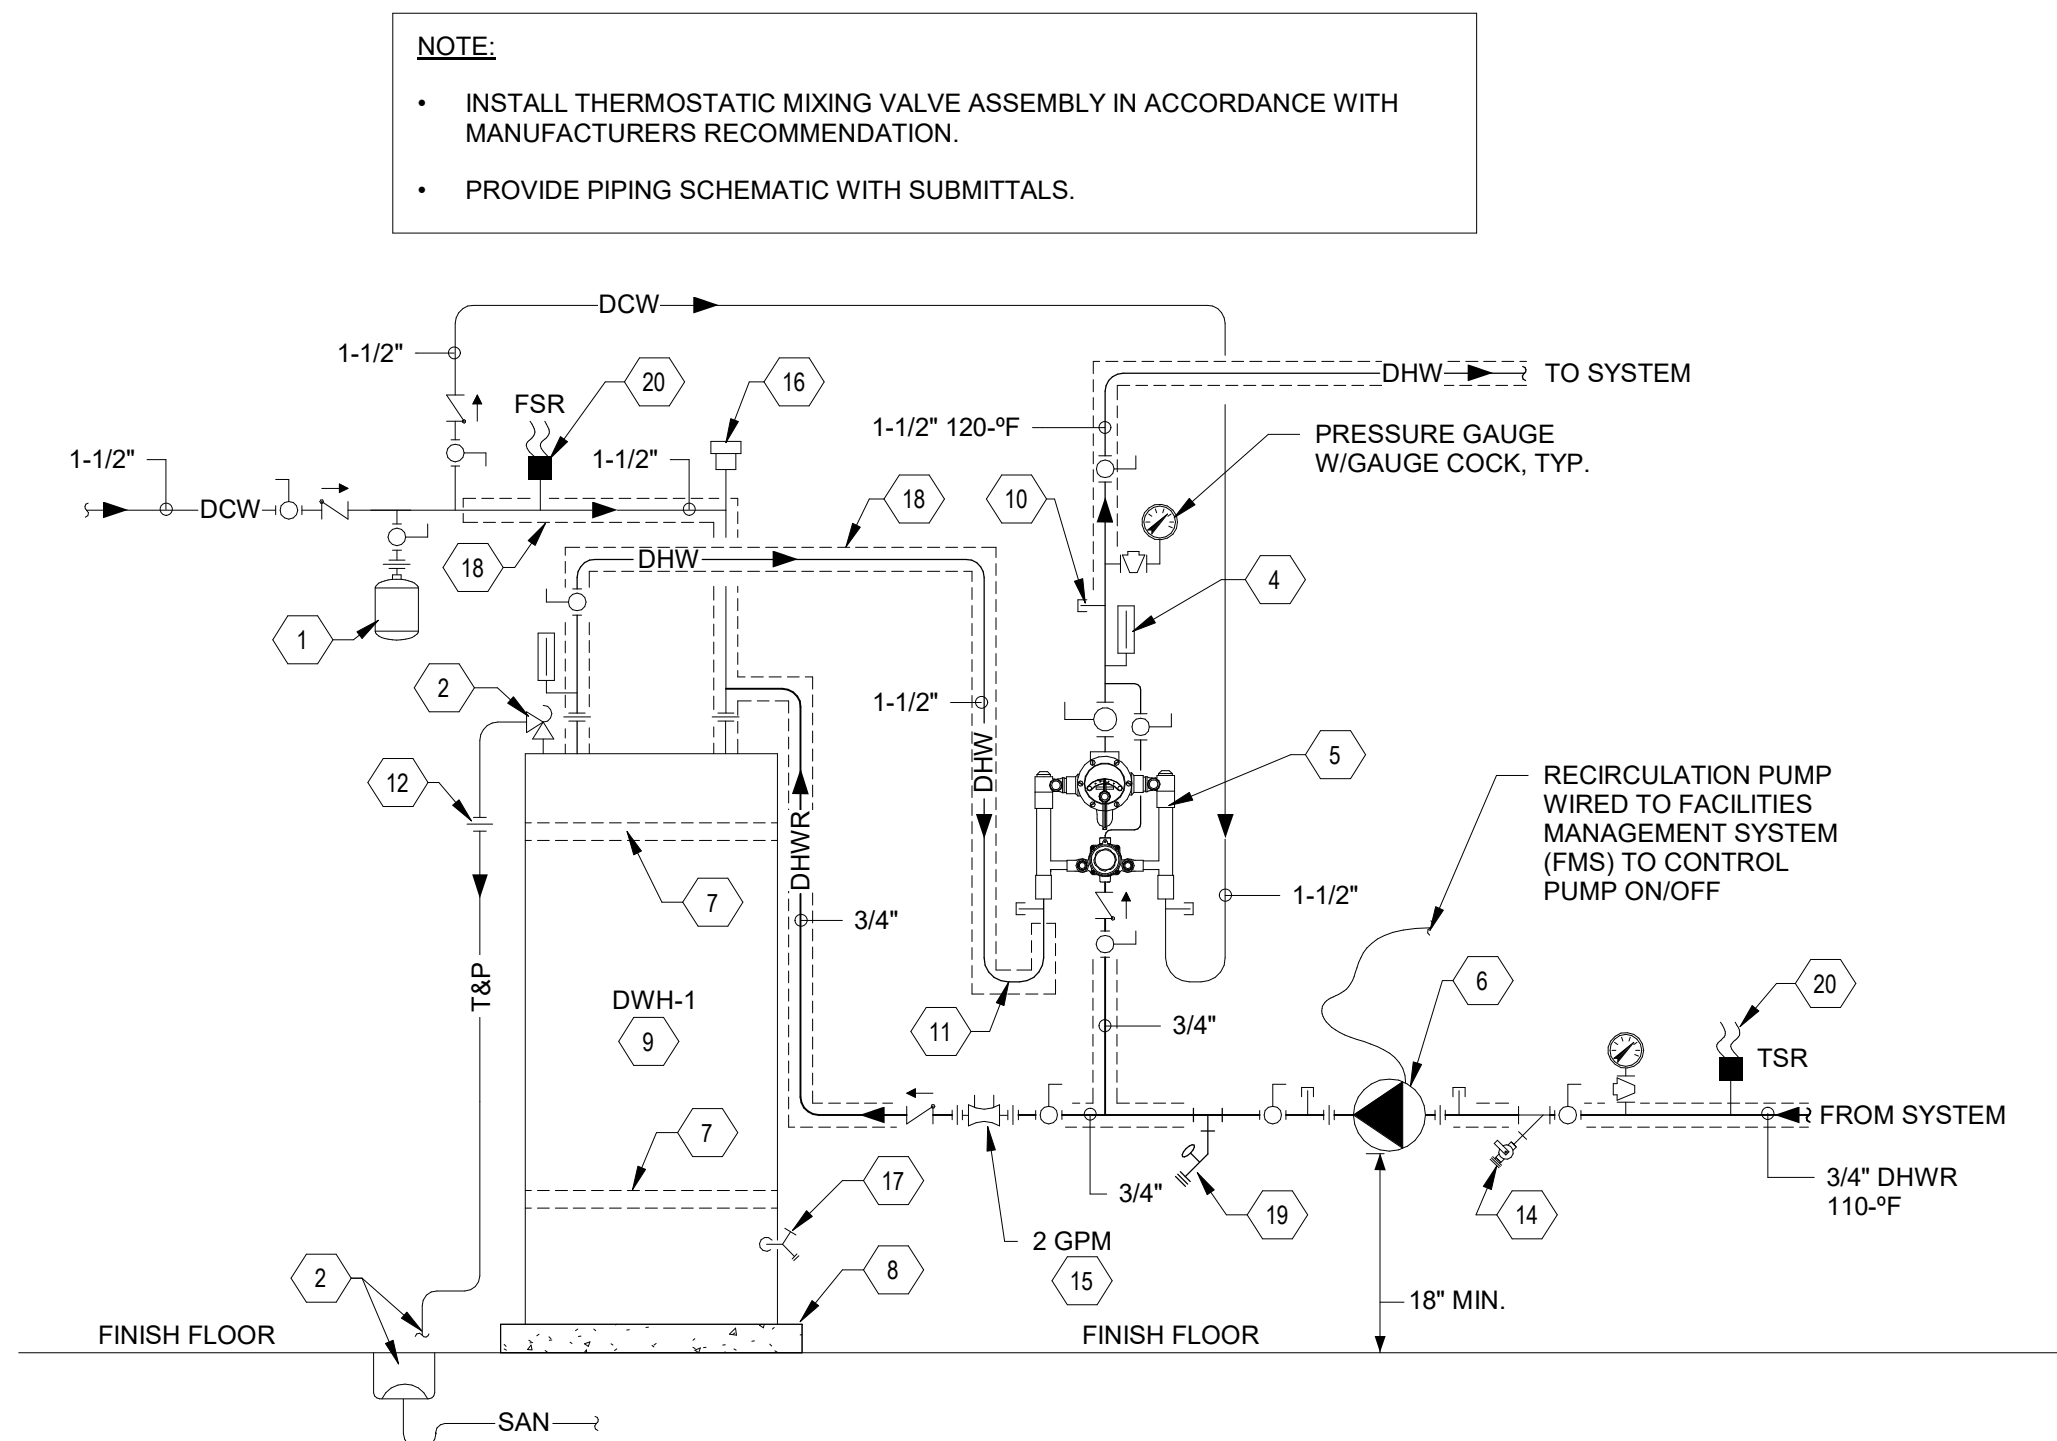

- 7 SEISMIC STRAPPING PER UPC 508.2 OR **IPC 502.4 (IF REQUIRED)**.
- 8 4" MIN. HOUSEKEEPING PAD
- 9 DOMESTIC WATER HEATER, SEE SPECS
- 10 PETE'S PLUGS (TYPICAL)
- 11 HEAT TRAP PER MFG. SPECS
- 12 UNION (TYPICAL)
- 13 NOT USED
- 14 WYE STRAINER WITH BLOWDOWN VALVE
- 15 CIRCUIT SETTER/BALANCING VALVE, SET TO GPM SHOWN
- 16 3/4" VACUUM RELIEF VALVE
- 17 TANK DRAIN, PROVIDE WITH BALL VALVE AND 3/4" NPT OUTLET
- 18 FIRST 8 FT OF PIPING INLET/OUTLET MUST BE INSULATED PER 2018 IECC (SEC. C404.3). INSULATE REST OF HOT WATER SYSTEM PER SPECIFICATIONS
- 19 PIPE MOUNT HOSE BIB
- 20 FLOW SENSOR (FSR) ON COLD WATER INLET, TEMPERATURE SENSOR (TSR) ON HOT WATER RETURN, WIRED TO FACILITY MANAGEMENT SYSTEM (FMS), PER 2018 IECC C404.6.1. COORDINATE WITH CONTROLS.

**C4 DOMESTIC WATER HEATER W/FMS - 2018 IECC**  
 SCALE: NOT TO SCALE

| ELECTRIC WATER HEATER SCHEDULE   |              |           |          |                    |                    |                     |                       |                  |            |    |    |                    |       |                    |            |          |   |
|--|--------------|-----------|----------|--------------------|--------------------|---------------------|-----------------------|------------------|------------|----|----|--------------------|-------|--------------------|------------|----------|---|
| NOTE: ALL WATER HEATERS SHALL COMPLY FULLY WITH THE 2018 IECC TABLE C404.2, MINIMUM PERFORMANCE OF WATER-HEATING EQUIPMENT |              |           |          |                    |                    |                     |                       |                  |            |    |    |                    |       |                    |            |          |   |
| SYMBOL   | MANUFACTURER | MODEL NO. | LOCATION | SERVICE            | TYPE               | SET POINT (DEGREES) | STORAGE VOLUME (GAL.) | OPERATION WEIGHT | ELECTRICAL |    |    |                    |       | HOT WATER RECOVERY |            | REMARKS: |   |
|  |              |           |          |                    |                    |                     |                       |                  | V          | PH | HZ | NUMBER OF ELEMENTS | WATTS | FLA                | RATE (GPH) |          | Δ T °F  |
| EWH-1  | A.O. SMITH   | DSE-30A   |          | DOMESTIC HOT WATER | ELECTRIC TANK TYPE | 140 F               | 40                    | 470 LBS.         |            |    | 60 | 1                  | 6000  |                    | 27         | 90       | INSTALL ON 4" MIN. HOUSEKEEPING PAD. ROUTE FULL SIZED T&P RELIEF VALVE TO EXTERIOR. |

| PLUMBING PUMP SCHEDULE |                |                              |          |                    |         |                 |               |            |            |            |    |    |          |   |
|------------------------|----------------|------------------------------|----------|--------------------|---------|-----------------|---------------|------------|------------|------------|----|----|----------|---|
| SYMBOL                 | MANUFACTURER   | MODEL NO.                    | LOCATION | SERVICE            | TYPE    | SYSTEM CAPACITY |               | PUMP (RPM) | MOTOR (HP) | ELECTRICAL |    |    |          | REMARKS:  |
|                        |                |                              |          |                    |         | GPM             | TOTAL FT. HD. |            |            | V          | PH | HZ | AMPS     |   |
| RCP-1                  | BELL & GOSSETT | ECOCIRC+ 20-18 NO. 9089B1004 |          | DOMESTIC HOT WATER | IN-LINE | 2               | 12            | VARIABLE   | 1/12       | 115        | 1  | 60 | .06-1.02 | STAINLESS STEEL BODY, FLANGED CONNECTION, ADJUSTABLE SPEED, LED INDICATORS, NUMERIC DISPLAY, FOR POTABLE WATER. |

| THERMOSTATIC MIXING VALVE SCHEDULE |              |                  |          |                    |                    |                 |                  |                  |                             |  |
|------------------------------------|--------------|------------------|----------|--------------------|--------------------|-----------------|------------------|------------------|-----------------------------|--|
| SYMBOL                             | MANUFACTURER | MODEL NO.        | LOCATION | SERVICE            | OUTLET TEMPERATURE | INLET PIPE SIZE | OUTLET PIPE SIZE | RETURN PIPE SIZE | SYSTEM FLOW & PRESSURE DROP | REMARKS:   |
| TMV-1                              | LEONARD      | TM-S20B-LF-DT-IT |          | DOMESTIC HOT WATER | 120 F              | 3/4"            | 1"               | 3/4"             | 19 GPM @ 5 PSIG             | ASME 1017, ROUGH BRASS, LEAD FREE, WALL MOUNT, INLET THERMOMETERS. |

| EXPANSION TANK SCHEDULE |              |           |                    |               |                    |                        |      |               |                      |
|-------------------------|--------------|-----------|--------------------|---------------|--------------------|------------------------|------|---------------|----------------------|
| SYMBOL                  | MANUFACTURER | MODEL NO. | SERVICE            | DESIGN DEG °F | TANK VOLUME (GAL.) | TANK ACCEPTANCE (GAL.) | PSIG | WEIGHT (LBS.) | REMARKS:             |
| EXP-1                   | AMTROL       | ST-SC-DD  | DOMESTIC HOT WATER | 140 F         | 2                  | 0.45                   | 55   | 10            | IN-LINE, ASME RATED. |



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**AG MOD PHASE 3: NEALE HALL DEMO**  
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 Las Cruces, NM 88001  
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SHEET TITLE  
 PLUMBING DETAILS


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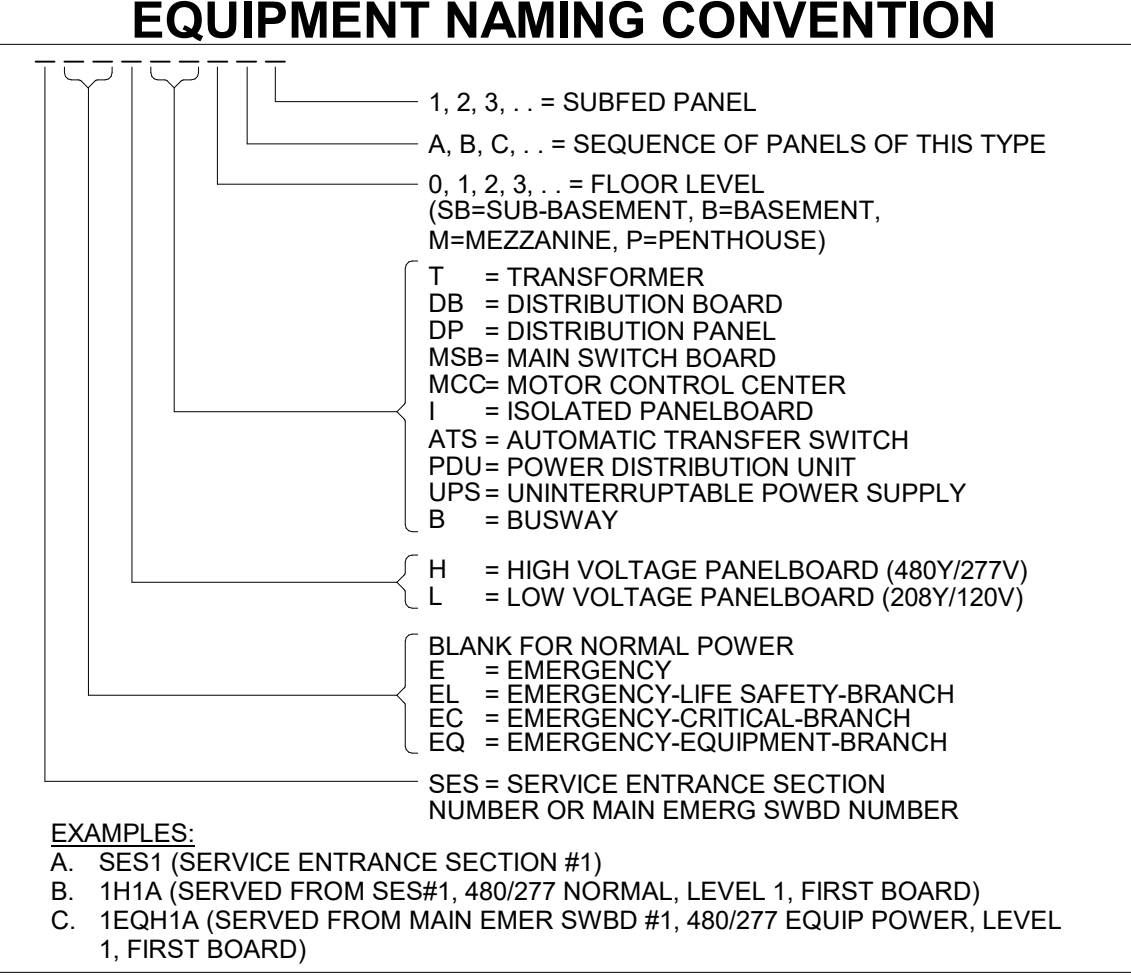
SHEET TITLE ELECTRICAL LEGEND

E-001


ELECTRICAL SYMBOL LEGEND (NOT ALL SYMBOLS APPLY TO THIS PROJECT)

UPDATED: 09/07/2016
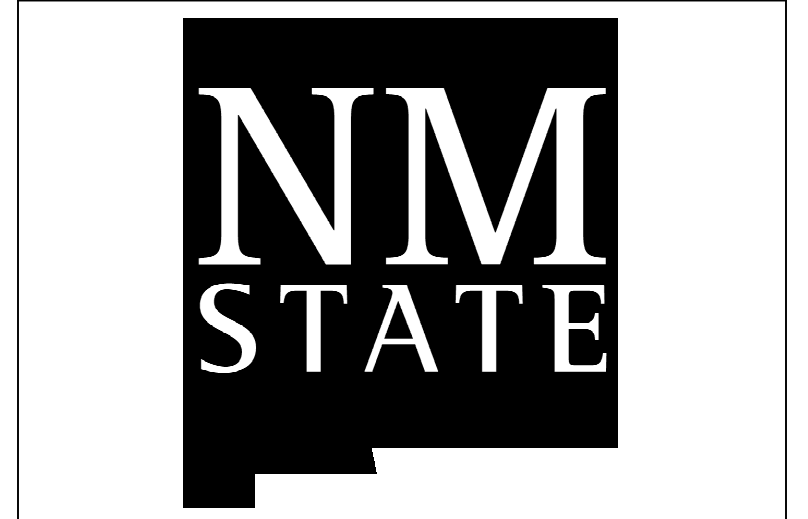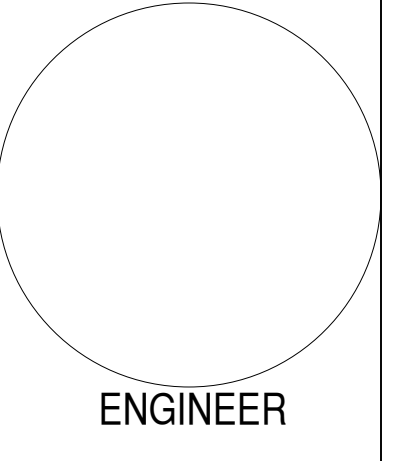
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DEMOLITION table with columns: SYMBOL, DESCRIPTION, NOTES

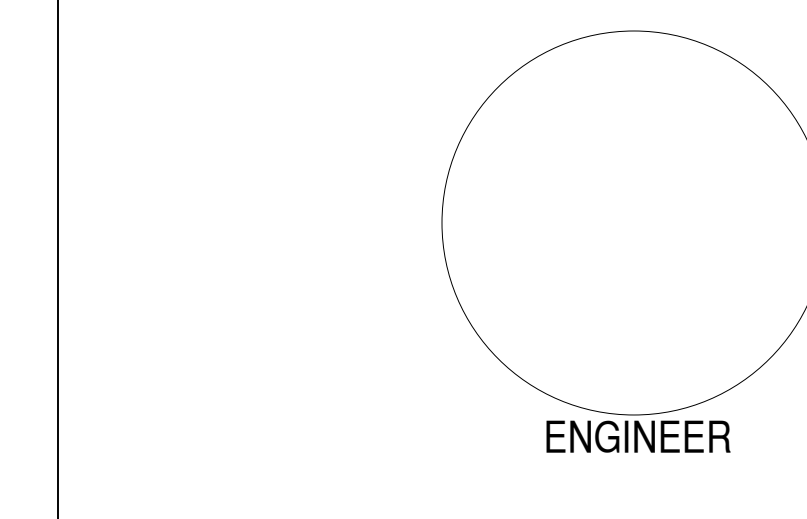DEVICES table with columns: SYMBOL, DESCRIPTION, MOUNTING LOC., HT.

EQUIPMENT table with columns: SYMBOL, DESCRIPTION
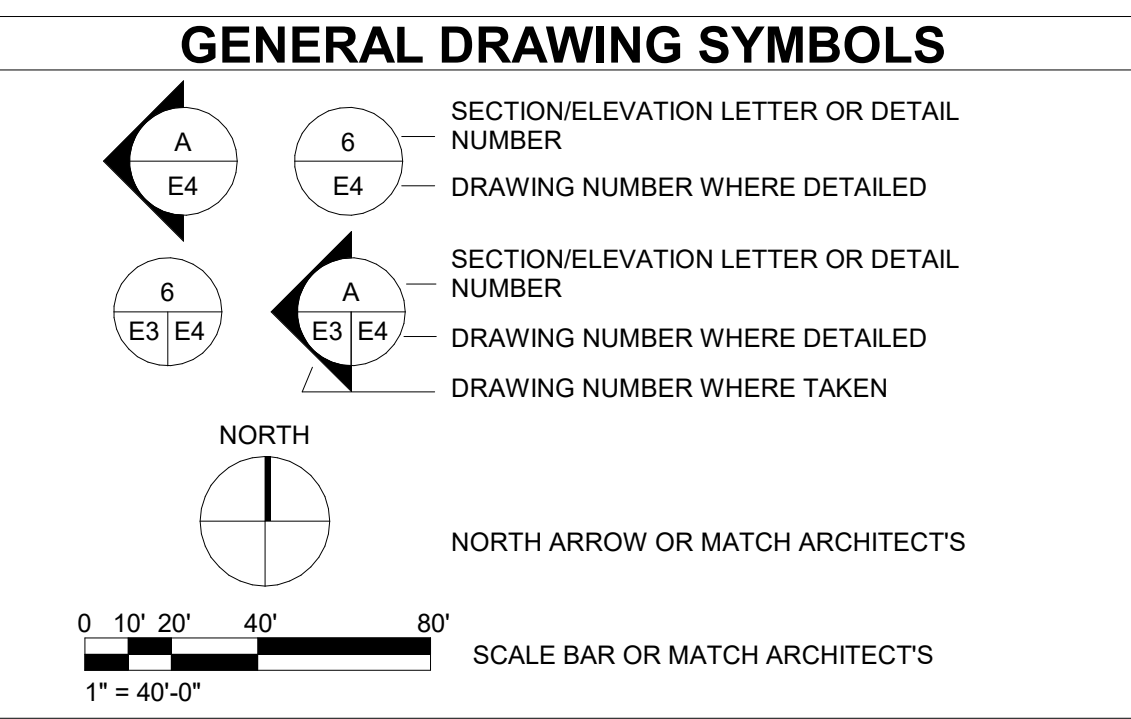
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UTILITIES table with columns: SYMBOL, DESCRIPTION

FIRE ALARM table with columns: SYMBOL, DESCRIPTION, MOUNTING LOC., HT.

ONE-LINE DIAGRAM table with columns: SYMBOL, DESCRIPTION



GENERAL NOTES

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- D. THIS DRAWING INDICATES THE INTENT OF DEMOLITION AT EXISTING BUILDING. NO ATTEMPT HAS BEEN MADE TO SHOW EACH AND EVERY SURFACE, ELEVATION, DETAIL, ETC. THE CONTRACTOR IS ADVISED TO VISIT THE JOB SITE TO BECOME FAMILIAR WITH THE SCOPE OF WORK PRIOR TO BIDDING. EXISTING DRAWINGS OF RECORD FOR THE BUILDING ARE AVAILABLE UPON REQUEST.
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- G. ALL DEMOLITION DRAWINGS INDICATE THE GENERAL SCOPE OF WORK. CONTRACTOR IS RESPONSIBLE TO DEMOLISH AND REMOVE ALL EXISTING BUILDING ELEMENTS REQUIRED TO COMPLETE NEW WORK.

KEYED NOTES

- 1. XXXX.

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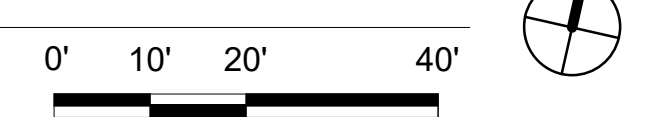
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SHEET TITLE  
 ELECTRICAL DEMOLITION SITE PLAN

ES100

A1 ELECTRICAL DEMOLITION SITE PLAN





**A1** ELECTRICAL SITE PLAN  
1" = 20'-0"



**GENERAL NOTES**

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- F. ALL DEMOLITION DRAWINGS INDICATE THE GENERAL SCOPE OF WORK. CONTRACTOR IS RESPONSIBLE TO DEMOLISH AND REMOVE ALL EXISTING BUILDING ELEMENTS REQUIRED TO COMPLETE NEW WORK.
- G. WHERE CONDUITS CROSS A DRIVEWAY, ROADWAY OR PARKING AREA, CONDUITS SHALL BE CONCRETE ENCASED.
- H. REFER TO SHEET SERIES "C", "AS", "M", "T" AND "P" FOR OTHER UTILITIES WITHIN ROUTING PATH OF ELECTRICAL RACEWAYS. CONTRACTOR SHALL COORDINATE THE INSTALLATION OF ANY UTILITIES SHOWN ON THIS SHEET PRIOR TO COMMENCEMENT OF ANY WORK FOR BEST LOCATION OF THESE UTILITIES.

**KEYED NOTES**

- 1. XXXX

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| SHEET TITLE          |
| ELECTRICAL SITE PLAN |

**ES101**

1 2 3 4 5 6

KEYED NOTES

1. XXXX.

GENERAL NOTES

- A. COORDINATE ALL 120 VOLT POWER REQUIREMENTS AND LOCATIONS WITH THE CONTROLS/ACCESS/SECURITY CONTRACTORS IN THE FIELD. REFER TO SPECIFICATION 230549 FOR ADDITIONAL INFORMATION.
- B. LOCATION OF EQUIPMENT IS APPROXIMATE AND SHOULD BE FIELD VERIFIED.
- C. IT SHALL BE THE RESPONSIBILITY OF THE CONTRACTOR TO COORDINATE WITH ALL TRADES FOR EXACT LOCATION OF EQUIPMENT AND APPURTENANCES THAT REQUIRE ELECTRICAL CONNECTIONS AND REQUIRE ALIGNMENT OF DEVICES.
- D. INSTALL ALL CONDUITS IN OPEN CEILING SPACE AS CLOSE TO STRUCTURE AS POSSIBLE.

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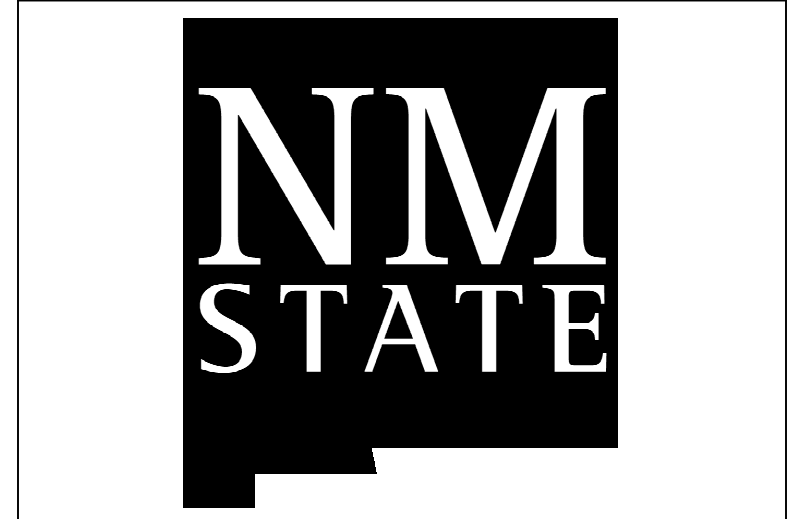
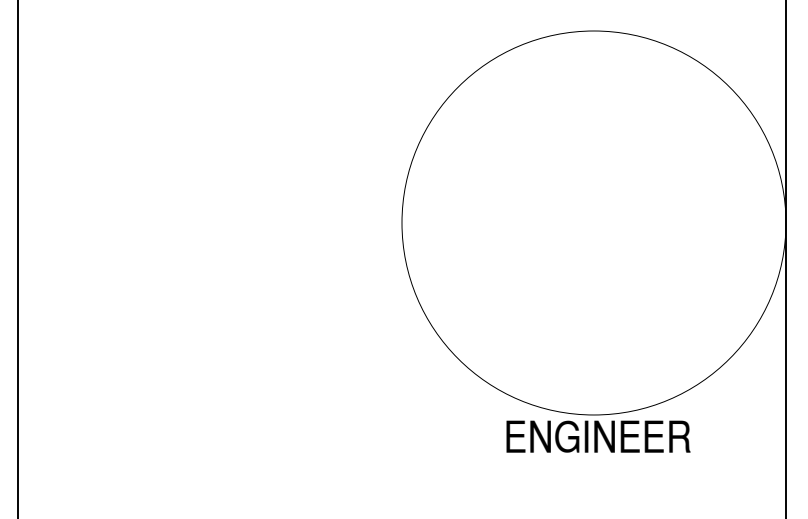
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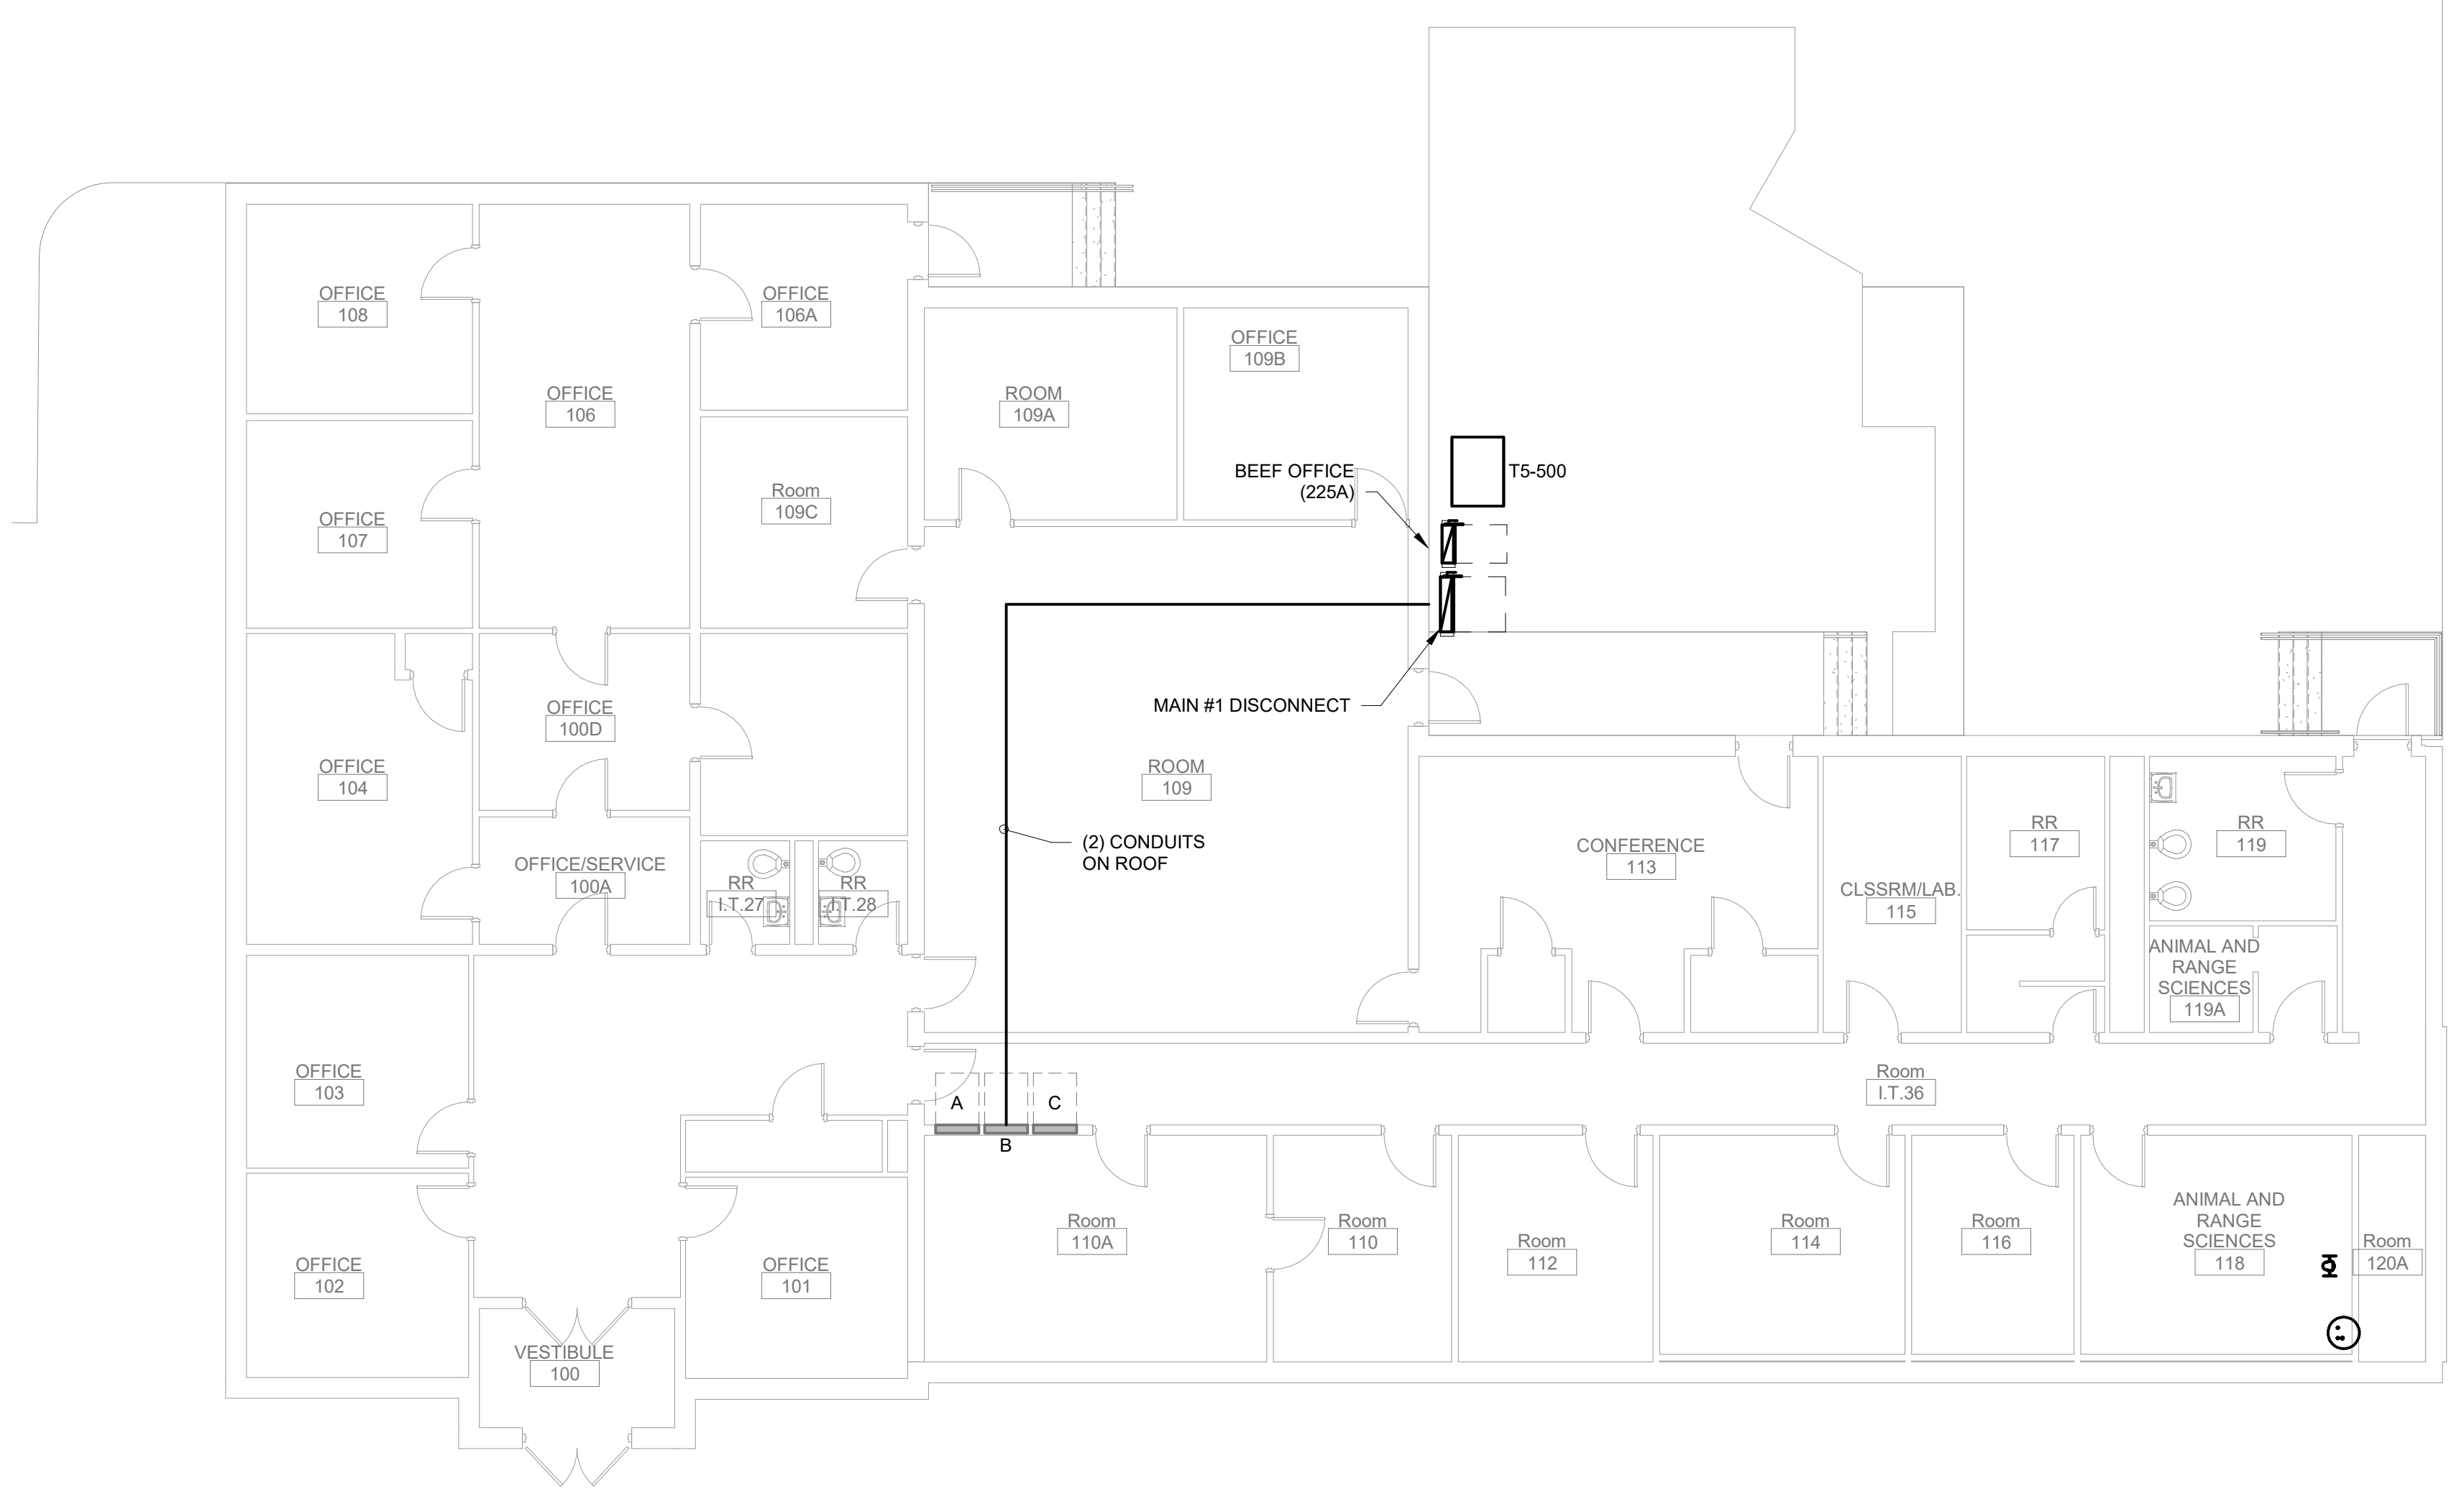
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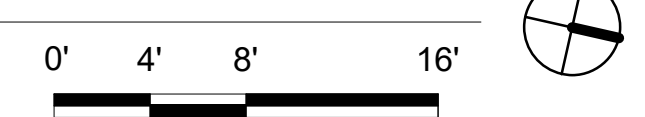
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SHEET TITLE  
POWER OVERALL PLAN

**EP100**



**A1** POWER OVERALL PLAN  
1/8" = 1'-0"



1 2 3 4 5 6



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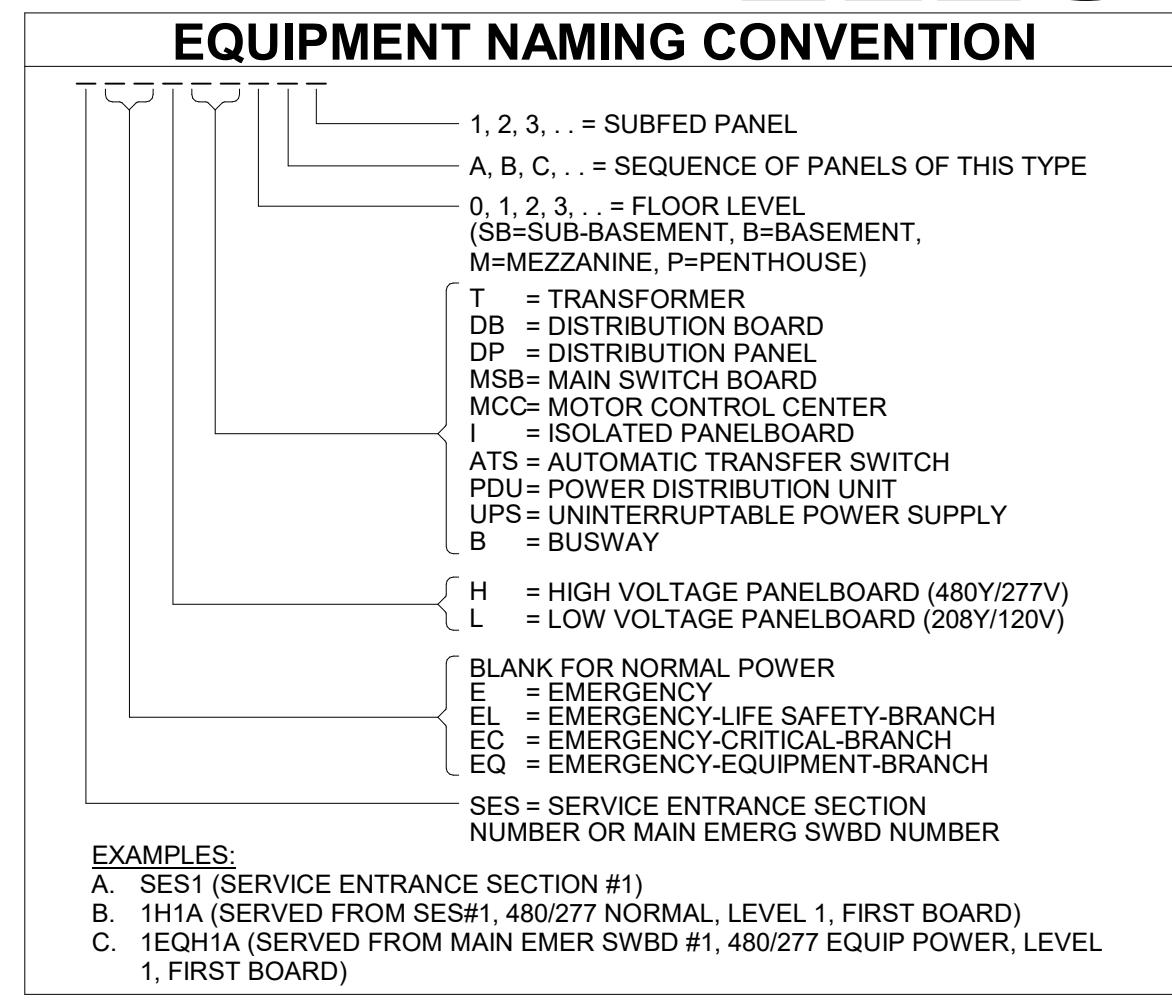
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SHEET TITLE ELECTRICAL LEGEND


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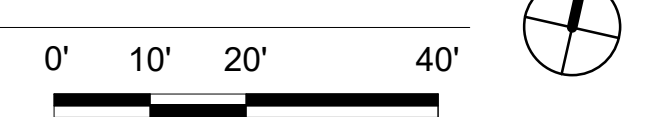
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SHEET TITLE

ELECTRICAL DEMOLITION SITE PLAN


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A1 ELECTRICAL DEMOLITION SITE PLAN



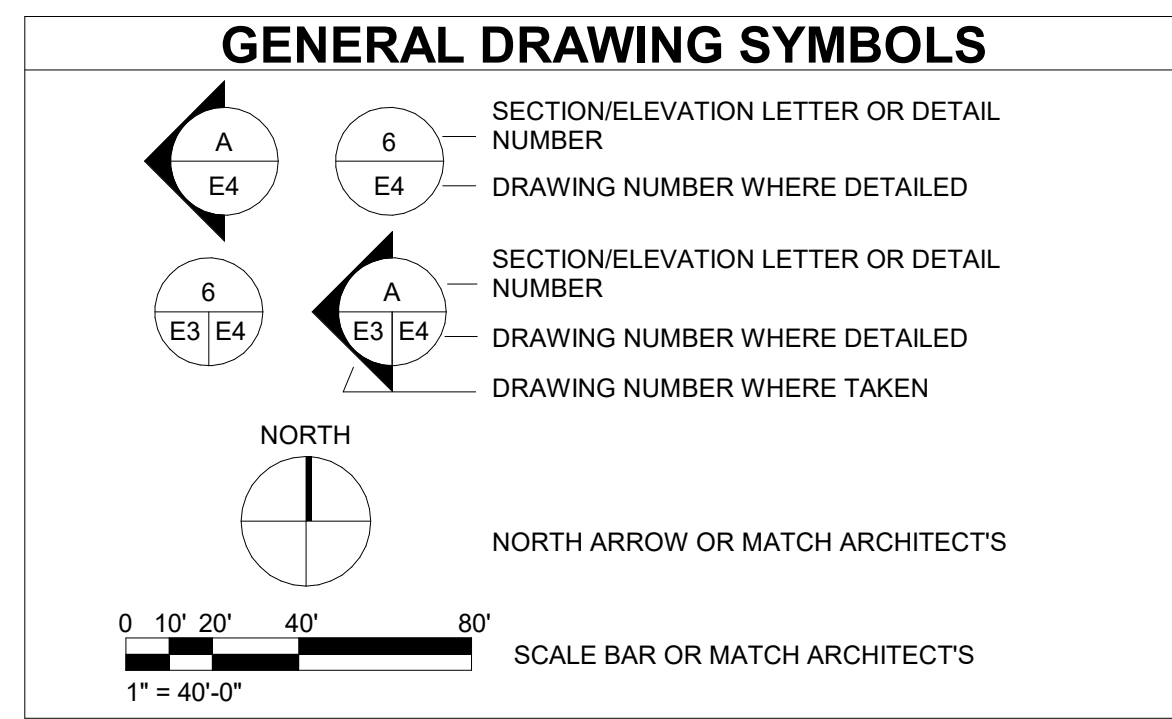

**A1** ELECTRICAL SITE PLAN  
1" = 20'-0"

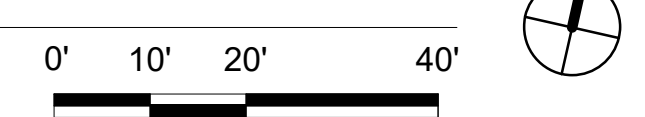

**GENERAL NOTES**

- A. INFORMATION SHOWN IS DIAGRAMMATIC AND IS NOT INTENDED TO REPRESENT PHYSICAL ARRANGEMENTS, LOCATIONS, ROUTING OR CONNECTIONS. PHYSICAL LAYOUTS ARE TO BE COORDINATED WITH OTHER UTILITIES, AND PER FIELD CONDITIONS PRIOR TO COMMENCEMENT OF ANY WORK.
- B. WHERE CIRCUITS EXTEND FROM AREAS OUTSIDE OF DEMOLISHING SCOPE CONTRACTOR IS TO SPICE, RE-ROUTE, AND EXTEND CIRCUIT AS NECESSARY TO MAINTAIN CONTINUITY TO REMAINING DEVICES.
- C. THIS DRAWING INDICATES THE INTENT OF DEMOLITION AT EXISTING BUILDING. NO ATTEMPT HAS BEEN MADE TO SHOW EACH AND EVERY SURFACE, ELEVATION, DETAIL, ETC. THE CONTRACTOR IS ADVISED TO VISIT THE JOB SITE TO BECOME FAMILIAR WITH THE SCOPE OF WORK PRIOR TO BIDDING. EXISTING DRAWINGS OF RECORD FOR THE BUILDING ARE AVAILABLE UPON REQUEST.
- D. ALL DEMOLITION WORK SHALL BE COORDINATED WITH RENOVATION PLANS AND NEW CONSTRUCTION PLANS.
- E. UTILITIES: LOCATE ALL EXISTING ACTIVE UTILITIES AND DETERMINE ALL REQUIREMENTS FOR DISCONNECTION, RECONNECTION, REROUTING OR CAPPING. CONTRACTOR SHALL PROTECT ALL UTILITIES DESIGNATED TO REMAIN FROM DAMAGE. CONTRACTOR SHALL COORDINATE ANY UTILITY INTERRUPTIONS WITH OWNER A MINIMUM OF 10 DAYS IN ADVANCE.
- F. ALL DEMOLITION DRAWINGS INDICATE THE GENERAL SCOPE OF WORK. CONTRACTOR IS RESPONSIBLE TO DEMOLISH AND REMOVE ALL EXISTING BUILDING ELEMENTS REQUIRED TO COMPLETE NEW WORK.
- G. WHERE CONDUITS CROSS A DRIVEWAY, ROADWAY OR PARKING AREA, CONDUITS SHALL BE CONCRETE ENCASED.
- H. REFER TO SHEET SERIES "C", "AS", "M", "T" AND "P" FOR OTHER UTILITIES WITHIN ROUTING PATH OF ELECTRICAL RACEWAYS. CONTRACTOR SHALL COORDINATE THE INSTALLATION OF ANY UTILITIES SHOWN ON THIS SHEET PRIOR TO COMMENCEMENT OF ANY WORK FOR BEST LOCATION OF THESE UTILITIES.

**KEYED NOTES**

- 1. xxxx

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ENGINEER

**NM STATE**

**AG MOD PHASE 3: NEALE HALL DEMO**  
**95% CONSTRUCTION DOCUMENTS**  
 3198 S. Espina St  
 Las Cruces, NM 88001  
 MARCH 13, 2024

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|----------------------|
| SHEET TITLE          |
| ELECTRICAL SITE PLAN |

**ES101**

**KEYED NOTES**

1. XXXX.

**GENERAL NOTES**

- A. COORDINATE ALL 120 VOLT POWER REQUIREMENTS AND LOCATIONS WITH THE CONTROLS/ACCESS/SECURITY CONTRACTORS IN THE FIELD. REFER TO SPECIFICATION 230549 FOR ADDITIONAL INFORMATION.
- B. LOCATION OF EQUIPMENT IS APPROXIMATE AND SHOULD BE FIELD VERIFIED.
- C. IT SHALL BE THE RESPONSIBILITY OF THE CONTRACTOR TO COORDINATE WITH ALL TRADES FOR EXACT LOCATION OF EQUIPMENT AND APPURTENANCES THAT REQUIRE ELECTRICAL CONNECTIONS AND REQUIRE ALIGNMENT OF DEVICES.
- D. INSTALL ALL CONDUITS IN OPEN CEILING SPACE AS CLOSE TO STRUCTURE AS POSSIBLE.

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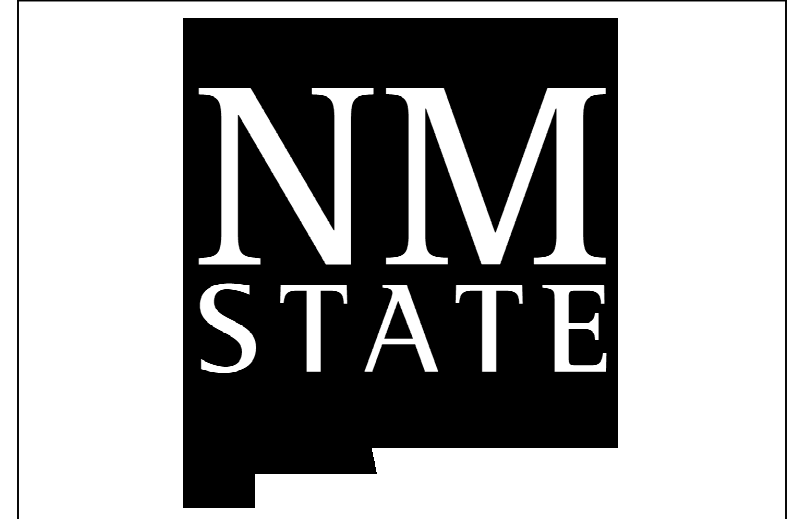
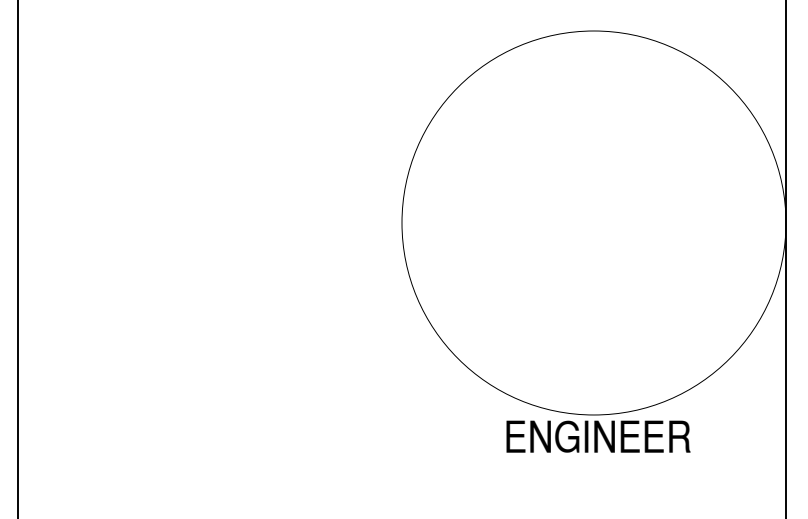
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**AG MOD PHASE 3: NEALE HALL DEMO**

**95% CONSTRUCTION DOCUMENTS**

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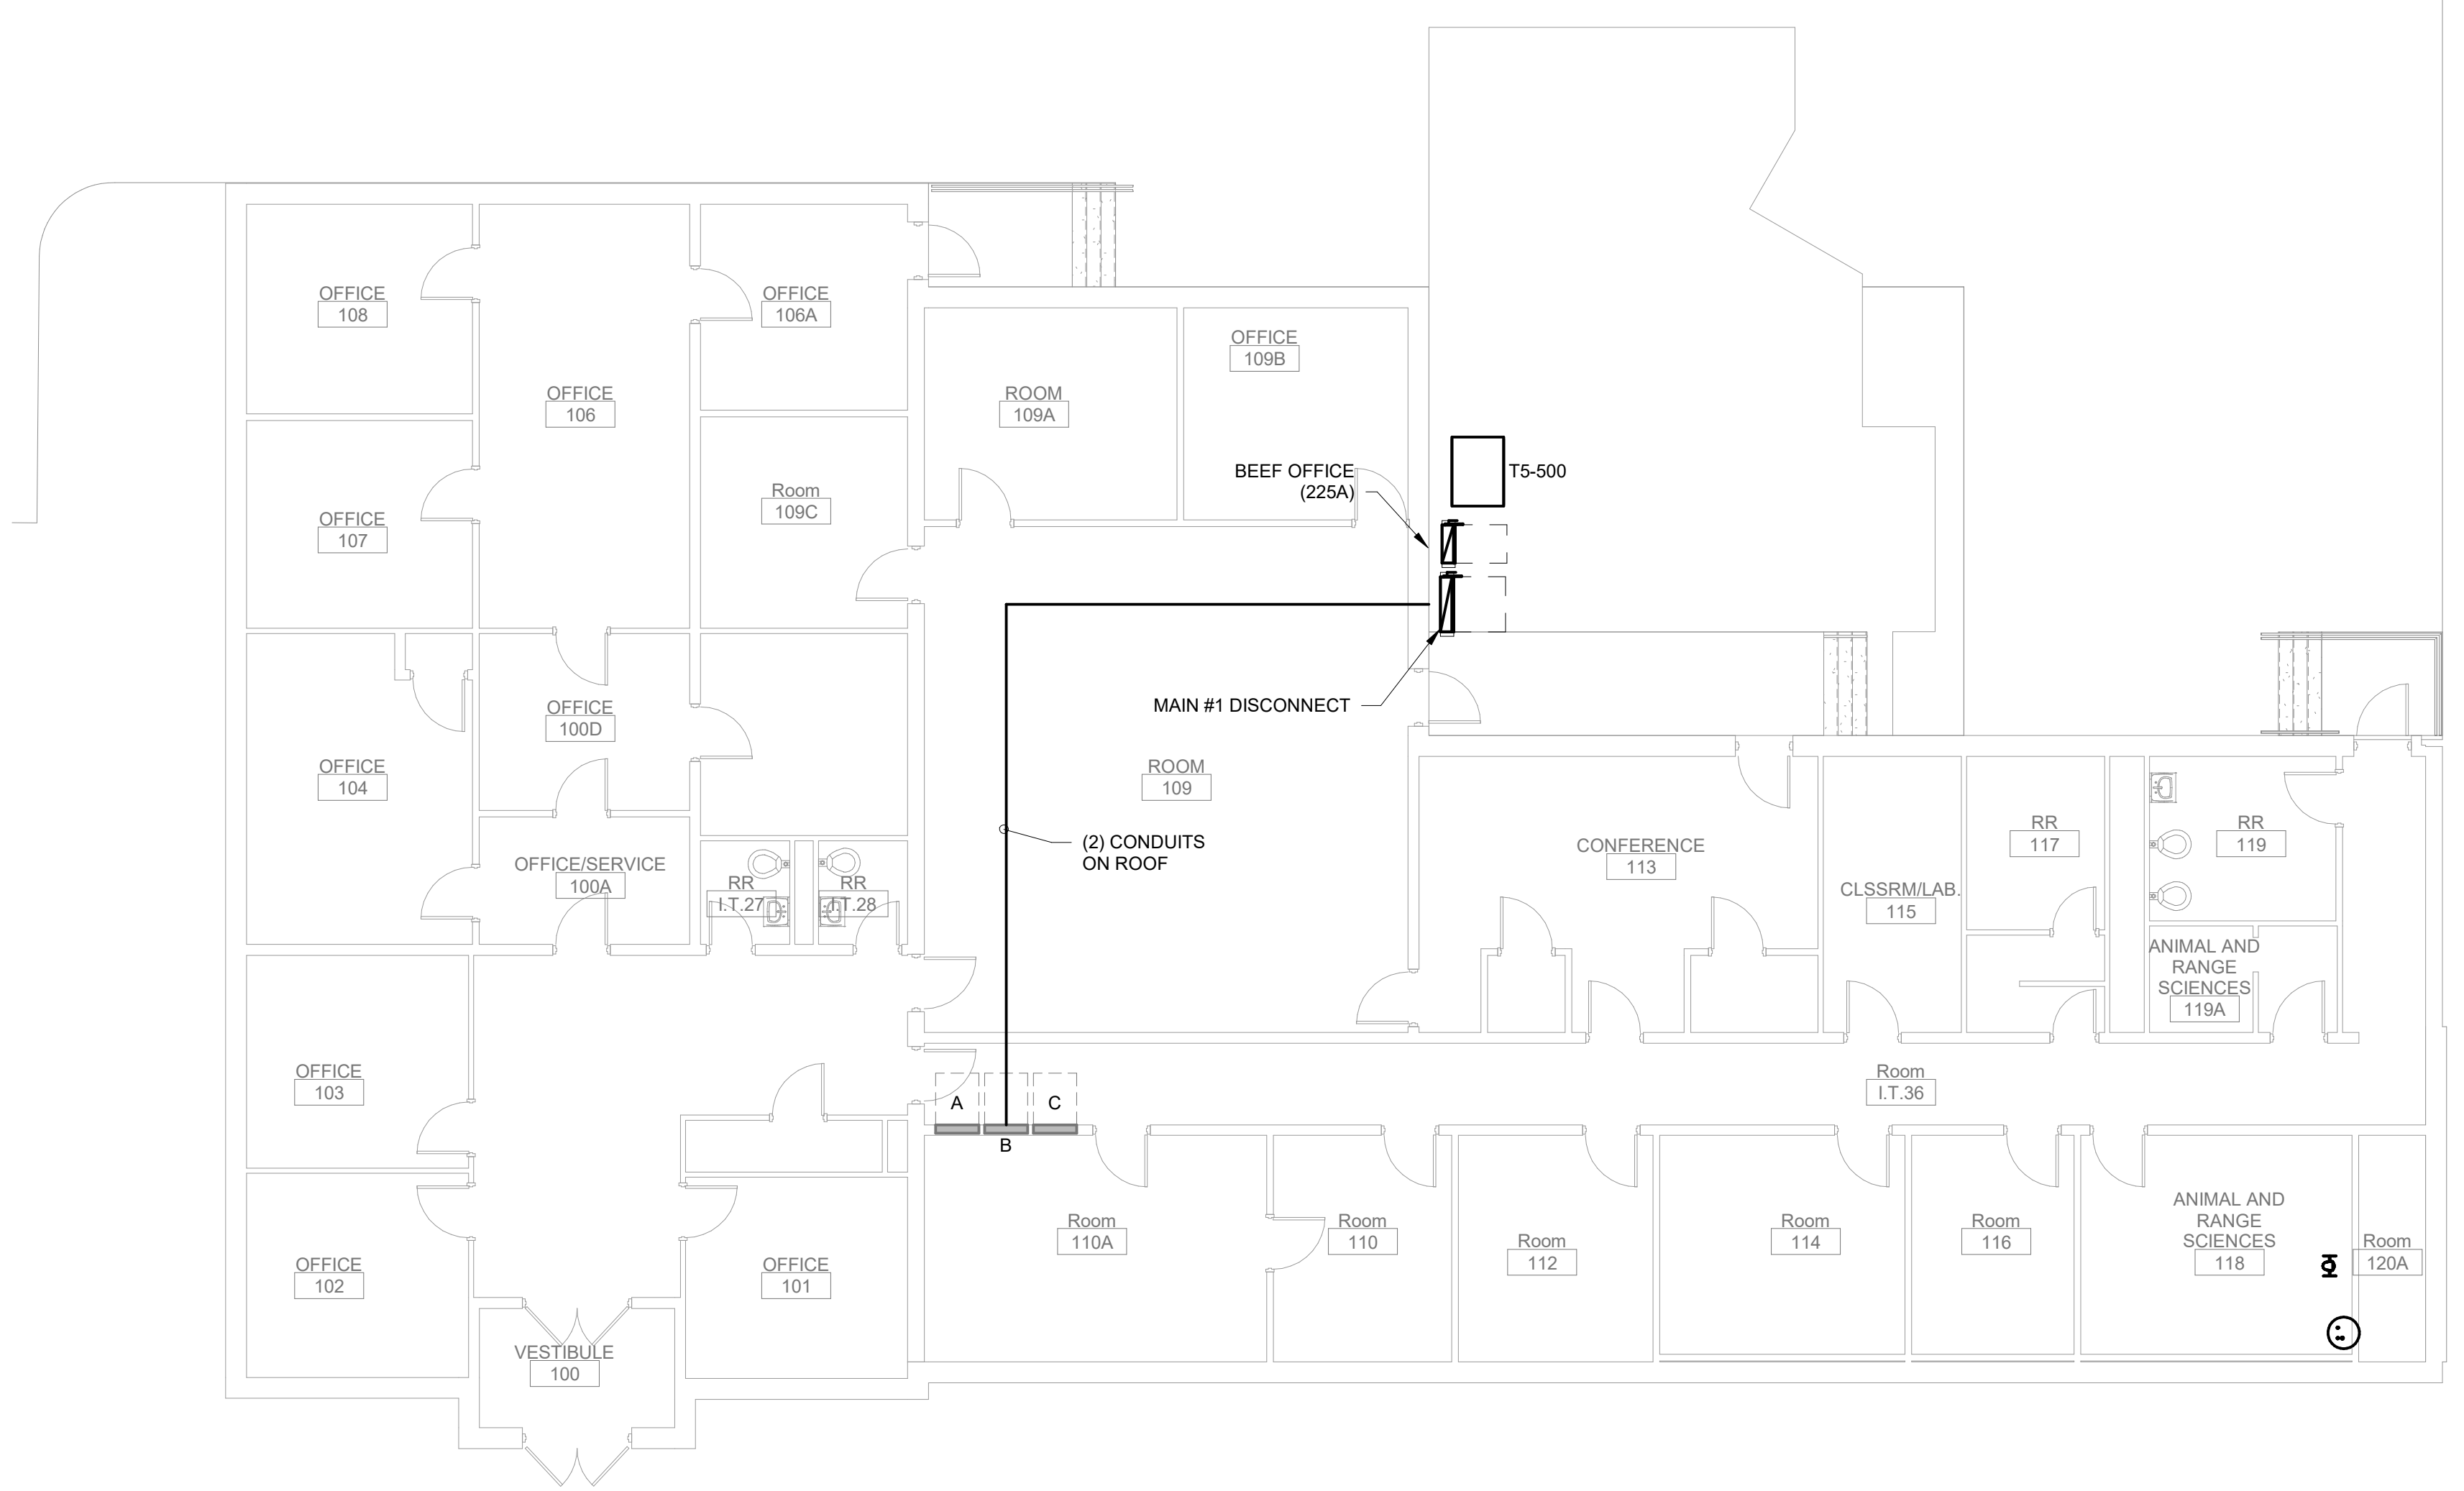
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SHEET TITLE  
POWER OVERALL PLAN

**EP100**



**A1** POWER OVERALL PLAN  
1/8" = 1'-0"

