New Mexico State University 3948 DACC Anthony Campus Gadsden Center Reroof 95% CD Set: April 15, 2024

OWNER:

NEW MEXICO STATE UNIVERSITY PO BOX 30000, MSC 3545 LAS CRUCES, NM 88003 **CONTACT: RICHARD HERNANDEZ, PROJECT** MANAGER, 575-646-2383, RFH@NMSU.EDU

DESIGNER:

ARMSTRONG GROUP INC. PO BOX 92977 ALBUQUERQUE, NM 87199 **CONTACT: DAVID ARMSTRONG** 505-235-7596, DAVIDA@AGICONSULTANTS.COM

INDEX OF SHEETS:

C-001	COVER SHEET
A-101	ROOF PLAN
A-501	ROOF DETAILS
A-502	ROOF DETAILS
A-503	ROOF DETAILS

CODE DATA:

REQUIRED CODES:	2021 NEW MEXICO COMMERCIAL BUILDIN
	2021 NEW MEXICO EXISTING BUILDING C
	2021 INTERNATIONAL BUILDING CODE
	2021 INTERNATIONAL EXISTING BUILDING
	2018 NEW MEXICO ENERGY CONSERVAT
	2021 NEW MEXICO PLUMBING CODE
	2021 NEW MEXICO MECHANICAL CODE
	2020 NEW MEXICO ELECTRICAL CODE
	2012 NEW MEXICO ELECTRICAL SAFETY
	2020 NATIONAL ELECTRICAL CODE
	2012 NATIONAL ELECTRICAL SAFETY CO
	ICC/ANSI A117.1-2017
CLASSIFICATION OF WORK:	REPAIR - EXISTING FACILITY
OCCUPANT TYPE:	B

AREA TABULATIONS: NEW METAL ROOF AREA: APPROX. 4,094 SF **NEW MEMBRANE ROOF AREA: APPROX. 28,329 SF NEW ROOF CLASS: CLASS A**

THE PROJECT CONSISTS OF REMOVAL AND REPLACEMENT OF EXISTING ROOFING SYSTEM.

THESE RENOVATIONS DO NOT CHANGE THE OCCUPANCY GROUP OR CONSTRUCTION TYPE WITHIN THE EXISTING BUILDING, NOR DO THEY CHANGE THE CONDITIONED OR OCCUPIED SPACES.

SCOPE OF WORK:

BASE BID WORK: THE SCOPE CONSISTS OF THE REMOVAL AND REPLACEMENT OF THE EXISTING CLAY TILE ROOFING AND THE INSTALLATION OF A NEW STANDING SEAM METAL ROOF SYSTEM. THE SCOPE ALSO CONSISTS OF THE INSTALLATION OF A NEW PVC OVERLAY ROOFING

SYSTEM.

SITE MAP:

ING CODE CODE

NG CODE **TION CODE**

CODE

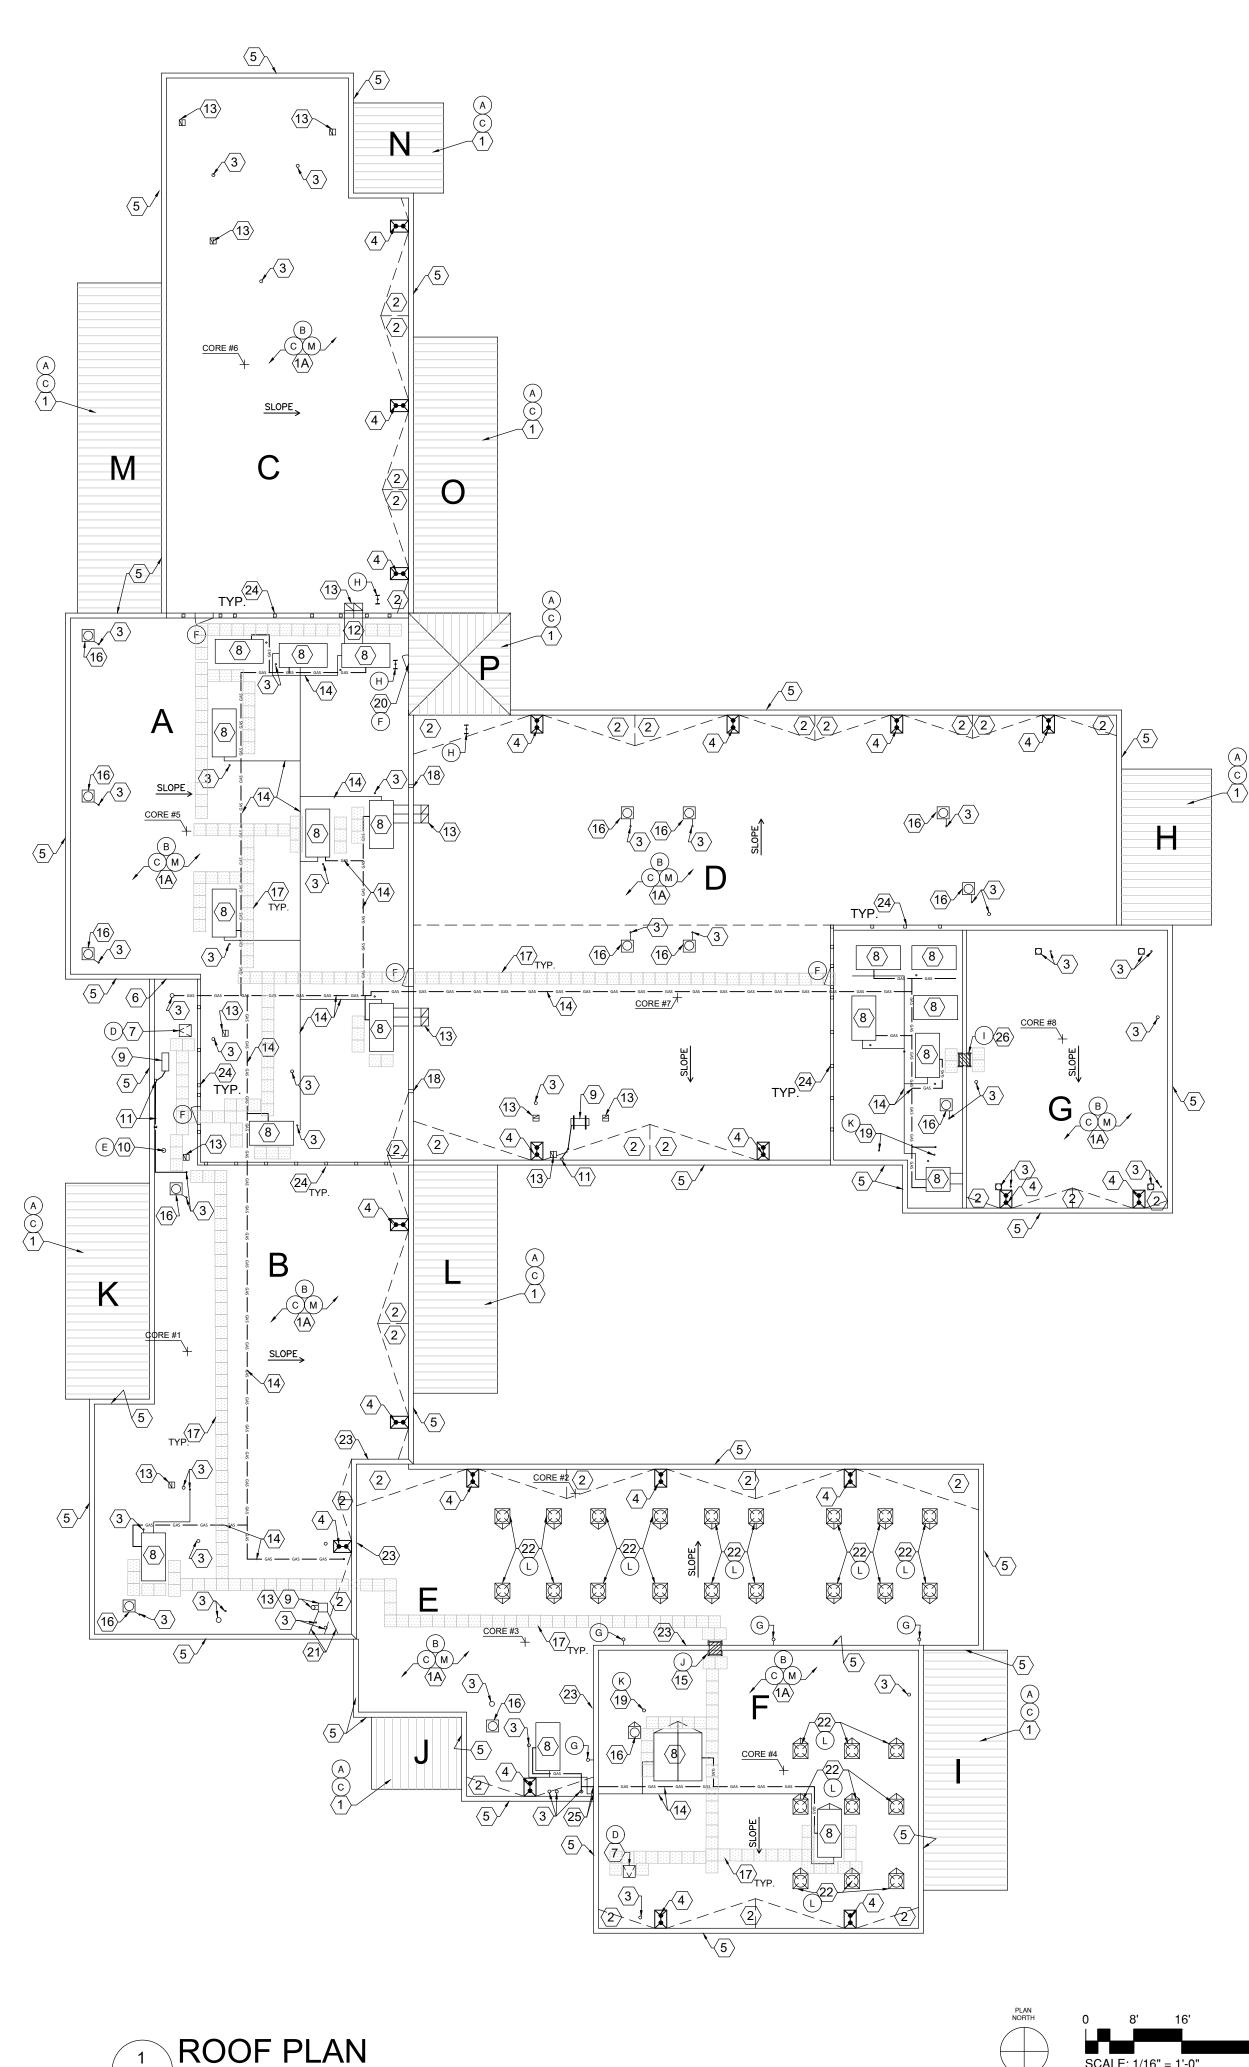
CODE





GADSDEN CENTER 1700 OHARA ROAD ANTHONY, NM 88021

Armstrong Group, Inc. PO Box 92977 Albuquerque, NM 87199 505.899.0089 www.agiconsultants.com Building Investigation Design & Consulting		
New Mexico State University 3948 DACC Anthony Campus 2948 DACC Anthony Campus 1200 Cherer Reroof 1700 Ohara Rd, Anthony, NM 88021		
Date 4/15/2024		
95% CD Set Drawn by AMB Checked by TPG/DRA		
Sheet title COVER SHEET		
Sheet No. C-001 Of TOT		




A-101 1/16" = 1'-0"



- A. CLAY TILE ROOF AREAS H-P REMOVE EXISTING ROOFING DOWN TO DECK: CLAY TILE
- B. FLAT ROOF AREAS A-G EXISTING ROOFING TO REMAIN. MEMBRANE MUST BE CUT IN 12'-0" SECTIONS:
- CORE #1 • TPO
- 1 1/2" POLYISO INSULATION 1/2" DENSDECK
- METAL DECK
- CORE #2 TPO
- 1/2" DENSDECK METAL DECK
- CORE #3
- TPO 1" DENSDECK
- METAL DECK
- CORE #4 • TPO
- 1/2" DENSDECK METAL DECK
- CORE #5
- TPO 1" POLYISO
- 1/2" DENSDECK METAL DECK
- CORE #6 TPO
- 1" POLYISO
- 1/2" DENSDECK METAL DECK
- CORE #7 TPO
- 1" POLYISO
- 1/2" DENSDECK METAL DECK
- CORE #8
- TPO
- 1 1/2" POLYISO 3" POLYISO
- 1/2" DENSDECK METAL DECK
- C. REMOVE ALL BASE FLASHING, PENETRATION FLASHING AND COPINGS.
- D. EXISTING ROOF HATCH TO REMAIN.
- E. EXISTING HOIST POLE TO REMAIN.
- F. EXISTING ACCESS DOOR TO REMAIN.
- G. PARAPET MOUNTED ANTENNA/PIPE SUPPORT TO REMAIN. DISCONNECT AND RECONNECT, AS REQUIRED TO ALLOW FOR NEW ROOFING INSTALLATION.
- H. EXISTING SURFACE MOUNTED EXTERIOR LIGHT AND STEEL SUPPORTS.
- EXISTING OVER PARAPET ACCESS LADDER TO REMAIN.
- I. EXISTING WALL MOUNTED ACCESS LADDER TO BE REMOVED AND REPLACED.
- K. EXISTING ROOF HYDRANT TO REMAIN.
- EXISTING SKYLIGHT TO REMAIN.
- M. BAD METAL DECKING IS ANTICIPATED. REMOVE ALL BAD DECKING. ALL RUSTED DECKING WILL NEED TO HAVE THE DECK RUST REMOVED AND PRIMED WITH A RUST PROHIBITOR. INCLUDE COSTS TO REPLACE 2,000 SF OF B-DECKING IN YOUR BID. ADD/DEDUCT UNIT PRICING WILL BE REQUIRED ON BID FORM.




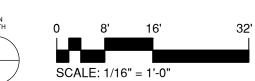- AND STICK UNDERLAYMENT, AS SPECIFIED, OVER MECH HD GYPSUM COVERBOARD OVER EXISTING METAL DECK FOR METAL ROOFING DETAILS.
- 1A. NEW FLAT ROOF OVERLAY SYSTEM: INSTALL 72 MIL PVC FIELD MEMBRANE. FULLY WELD MEMBRANE TO RHINO FASTENED THROUGH 1/4" DENSDECK TO BE FASTENED ROOF ASSEMBLY DOWN THROUGH THE METAL DECK WI MANUFACTURER-APPROVED FASTENERS AND RHINO PL
- ALL CRICKETS IN AREAS GRAPHICALLY REPRESENTED ON PROVIDE POSITIVE SLOPE AND DRAINAGE, WATER TESTE DRAINAGE. INSTALL NEW CRICKETS, AS REQUIRED. CRICH MINIMUM $\frac{1}{4}$ " GREATER THEN THE SLOPE OF THE ROOF. CRICKET) WITH 3 TO 1 RATIO TO CREATE POSITIVE SLOP FOR INTENT AND ARE NOT TO SCALE. CONTRACTOR IS RI POSITIVE DRAINAGE.
- VENT PIPE / ELECTRICAL / GAS PIPE PENETRATIONS THRO RAISED, AS REQUIRED, TO INSTALL NEW MEMBRANE RO REQUIRED TO TERMINATE NEW ROOFING. SEE DETAILS (
- PRIMARY AND OVERFLOW ROOF DRAINS: CLEAN, TEST F AND REINSTALL DRAIN STRAINER. IF STRAINER IS MISSIN REPLACE WITH CAST IRON. SEE DETAIL A1/A-501.
- TEAR OFF EIFS @ ALL TOP & BACK OF PARAPET WALL CO EXTERIOR WALLS AND INSTALL FAUX COPING. INSTALL WOOD NAILERS AT ALL PARAPETS. SEE DETAIL B1, B2, B
- INSTALL NEW COUNTERFLASHING ON HIGH WALL COND A2/A-501.
- INSTALL NEW SAFETY RAILING AT ROOF HATCH. SEE DET AND INSTALL TWO ROWS OF WALKPADS AT EXISTING H
- 8. INSTALL NEW FLASHING AT EXISTING HVAC MECHANICA EXISTING CURBS, AS REQUIRED, TO MEET HEIGHT REQU CONTRACT DOCUMENT DETAILS. IT IS THE CONTRACTOR MAKE ALL NECESSARY RECONNECTIONS AND EXTENSION PROVIDE TWO ROWS OF WALKPADS ON THREE SIDES O
- 9. INSTALL NEW KNEE CURBS AT EXISTING MECH. EQUIPM A3/A-501.
- 10. EXISTING HOIST. INSTALL NEW FLASHING PER DETAILS C
- 11. WALL MOUNTED ELECTRICAL BOX & CONDUITS TO REM. AS REQUIRED FOR NEW ROOFING INSTALLATION.
- 12. EQUIPMENT/DUCT SUPPORTS AT EXISTING MECH. EQUIP A3/A-502.
- 13. INSTALL NEW DUCT FLASHING PER DETAIL A4/A-502. RAI REQUIRED.
- 14. INSTALL NEW PIPE SUPPORTS PER DETAIL B2/A-502. GAS COAT OF YELLOW PAINT. PREP SURFACE TO REMOVE ALL PAINT BEFORE PAINTING.
- 15. INSTALL NEW ROOF ACCESS LADDER. PROVIDE TWO ROV LADDER LANDING. PROVIDE PROPER SECUREMENT. SEE I
- 16. INSTALL NEW BASE FLASHING AT CURB PER DETAIL A3/A
- 17. WALKPAD AS SPECIFIED TO BE INSTALLED: DOUBLE ROV ACCESS POINT AND THE THREE WORKING SIDES OF ROO PROVIDE SINGLE ROW WALKPAD FROM ALL ACCESS POIL PROVIDE TWO ROWS OF WALKPADS AT ALL ROOF HATC LANDINGS. LAYOUT SHOWN ON PLANS IS FOR INTENT. BASED ON ACTUAL FIELD CONDITIONS.
- 18. INSTALL NEW THRU WALL MEMBRANE COATED WALL S C1/A-502.
- 19. INSTALL NEW PIPE FLASHING AT EXISTING ROOF HYDRAI C3/A-501.
- 20. INSTALL NEW THRESHOLD FLASHING AT EXISTING ACCES A2/A-502.
- 21. INSTALL NEW GUIDEWIRE SUPPORT PER DETAIL B1/A-502
- 22. INSTALL NEW CURB FLASHING AT EXISTING SKYLIGHTS.
- 23. TEAR OFF EIFS AND WRAP MEMBRANE UP AND OVER IN DETAIL A1/A-502.
- 24. INSTALL NEW FLASHING AT SCREEN WALL TUBE COLUMI
- 25. INSTALL FLASHING AT THRU WALL PIPE PENETRATION.
- 26. AT EXISTING TO REMAIN ROOF ACCESS LADDER: PROVID WALKPADS AT LADDER LANDING. DETACH & REATTACH ROOFING INSTALLATION. PROVIDE PROPER SECUREMEN






	11	
S	GENERAL NOTES	
NSTALL NEW STANDING FINISH. INSTALL NEW PEEL CHANICALLY FASTENED 1/2"	1. THE CONTRACTOR SHALL NOT REMOVE ANY EXISTING ROOFING SYSTEM, DAMAGED DECKING, OR INSTALL NEW ROOFING SYSTEM WHEN WEATHER CONDITIONS THREATEN THE INTEGRITY OF THE BUILDING CONTENTS OR	STRONG GROUD
CHANICALLY FASTENED 1/2" CK. REFER TO SHEET A-503	OCCUPANTS. THE CONTRACTOR SHALL COMPLETE EACH DAY'S ROOFING CYCLE AND PROVIDE A WELDED OR FOAMED TEMPORARY SEAL AT JUNCTION OF NEW ROOF AND EXISTING ROOF. THE CONTRACTOR SHALL MAINTAIN A WATERPROOF	
VC BASEFLASHING AND O PLATES THAT HAVE BEEN	COMPLETED AREA WITH EACH ROOFING CYCLE. NO TOLERANCES WILL BE GIVEN. 2. ALL LOCATIONS OF ITEMS SHOWN ON ROOF PLANS ARE APPROXIMATE.	
ED THROUGH THE EXISTING WITH PLATES.	2. ALL LOCATIONS OF TIEMS SHOWN ON ROOF PLANS ARE APPROXIMATE. CONTRACTOR SHALL VERIFY ALL DIMENSIONS PRIOR TO BID. NO ALLOWANCES WILL BE MADE FOR ADDITIONAL AMOUNTS OF ROOFING MATERIAL, FLASHING, LABOR, ETC. NOT VERIFIED AND NOTIFIED BY THE CONTRACTOR TO THE OWNER REPRESENTATIVE PRIOR TO BID.	IN SPEC
ON DRAWINGS MUST STED TO INSURE POSITIVE ICKETS NEED TO BE	 PERFORM ALL DISCONNECTS, EXTENSIONS AND RECONNECTIONS AS REQUIRED TO ACCOMMODATE NEW ROOF HEIGHTS, FOR ITEMS BEING RAISED AND 	······································
F. (I.E. $\frac{1}{4}$ " SLOPE = $\frac{1}{2}$ " DPE. CRICKETS ARE SHOWN	REMOUNTED FOR RE-ROOFING WORK. AND MUST BE PART OF CONTRACTORS SUBMITTED WORK SCHEDULE AND MUST BE SCHEDULED PRIOR TO ANY	Armstrong Group, Inc.
S RESPONSIBLE FOR	DISCONNECT OR RECONNECT. RETURN ALL ITEMS TO OPERATIONAL CONDITION PRIOR TO END OF DAY'S WORK. NOTIFY THE ARCHITECT OF ANY DEFECTIVE ITEMS DISCOVERED DURING WORK.	PO Box 92977
HROUGH ROOF TO BE ROOF FLASHING AS LS C1, C2, C3/A-501.	 PIPES 1-1/2" AND SMALLER SHALL BE SUPPORTED AT 8'-0" O.C. MAXIMUM AND PIPES 2" AND LARGER SHALL BE SUPPORTED AT 10'-0" O.C. MAXIMUM. 	Albuquerque, NM 87199 505.899.0089 www.agiconsultants.com
T FOR POSITIVE DRAINAGE SING AND/OR PLASTIC,	5. THIS IS A POPULATED BUILDING SPECIAL CONSIDERATION, SCHEDULING, NOISE LEVELS AND STAGING WILL BE REQUIRED DURING ROOFING.	Building Investigation
CONDITIONS. WRAP L NEW 2X FIRE TREATED B3/A-501.	6. THE CONTRACTORS SHALL HAVE THE OPPORTUNITY TO ACQUAINT THEMSELVES WITH ALL EXISTING CONDITIONS AT THE PREBID AND BY APPOINTMENT IF SECONDARY INSPECTION IS NEEDED. NO ALLOWANCES SHALL BE MADE FOR CONDITIONS THAT ARE CLEARLY VISIBLE OR DETECTABLE WITH SOME RESEARCH	Design & Consulting
NDITIONS. SEE DETAILS	EFFORT. 7. THE LOADING AREA AVAILABLE AT GROUND LEVEL IS A FIRE, EMERGENCY AND	
ETAILS C4/A-501. PROVIDE	SECURITY ACCESS AREA, A STRICT SCHEDULE FOR STAGING OF DELIVERIES AND CRANING OF MATERIAL MUST BE SUBMITTED BY THE CONTRACTOR TO THE OWNER REPRESENTATIVE, SO THAT THE OWNER MAY COORDINATE ALL	
HATCH LANDING. CAL EQUIPMENT. EXTEND	NECESSARY PERMITS. ALL MATERIALS WILL HAVE TO BE STORED ON THE ROOF AREAS AND IN STAGING AREA, AS WELL AS SANITARY FACILITIES.	M-1/08S12019 Jobs/NM/NMSU/DACC/East Mesa ReBid Package/TED-SEAL 02-17-2020.jpg
QUIREMENTS SHOWN IN OR'S RESPONSIBILITY TO ONS. SEE DETAIL A4/A-501. OF MECHANICAL UNITS.	8. NO EMPLOYEES WILL BE ALLOWED IN THE BUILDING. ESCORTED SECURITY WILL NEED TO BE SCHEDULED FOR THE FOLLOWING: ACCESS TO THE ROOF THROUGH THE BUILDING AND ACCESS TO AREAS WITHIN THE BUILDING NECESSARY TO COMPLETE THE SCOPE OF WORK.	M:\UBS\2019 Jobs\VM\WMSUUDACCI;tast Mesa Rebid Pactage(TED-SEAL_02-17-2020.pg
MENT. SEE DETAILS A3,	 BEFORE ANY UTILITY CUT OFFS OR DEMOLITION IS TO OCCUR, A SCHEDULE MUST BE SUBMITTED TO THE ARCHITECT. A MINIMUM OF ONE WEEK'S ADVANCE 	
5 C2,C3/A-501.	NOTICE OF WORK IS REQUIRED. WORK SCHEDULES WILL BE REQUIRED TO BE SUBMITTED TO THE OWNER REPRESENTATIVE TWICE WEEKLY, ANTICIPATING THE	
MAIN. DETACH/REATTACH	NEXT WEEK'S WORK. 10. THE CONTRACTOR SHALL PROVIDE LICENSED PLUMBING, MECHANICAL AND	
UIPMENT. SEE DETAILS	ELECTRICAL CONTRACTORS TO REMOVE AND REINSTALL ALL EXISTING EQUIPMENT ON THE ROOF. ALL EQUIPMENT SHALL BE FULLY OPERATIONAL WHEN REINSTALLED. CONTRACTOR'S WORK SHALL MEET CURRENT APPLICABLE BUILDING	2 S
RAISE DUCT OUTLET AS	11. THE ROOFING CONTRACTOR SHALL PROVIDE FASTENERS AS REQUIRED FOR	sit P
GAS LINES TO RECEIVE NEW ALL DEBRIS AND LOOSE	CORROSIVE AGENTS ADDED TO TREATED WOOD NAILERS (IF PRESERVED WOODS ARE USED) AND AS RECOMMENDED BY THE ROOFING MANUFACTURER AND AS REQUIRED FOR THE WARRANTY.	zam 21 21
ROWS OF WALKPADS AT EE DETAIL B4/A-502.	12. ALL ROOFING SHALL BE ATTACHED TO THE BUILDING IN ACCORDANCE WITH FM 1-75 WIND UPLIFT FASTENING PATTERN AND ASCE 7 REQUIREMENTS.	
3/A-501. DW OF WALKPAD AT	13. THE DETAILS SHOWN IN DRAWINGS AND PLANS ARE FOR INTENT. THE MOST STRINGENT REQUIREMENTS BETWEEN CONSTRUCTION DOCUMENTS, MANUFACTURERS' DETAILS, SMACNA REQUIREMENTS AND NRCA RECOMMENDATIONS WILL BE REQUIRED.	
OOFTOP EQUIPMENT. OINTS TO THE EQUIPMENT. TCH AND ACCESS LADDER	14. ALL AREAS TO RECEIVE NEW ROOFING MEMBRANE SHALL BE INCORPORATED INTO ROOFING WARRANTY, INCLUDING NEW WALL AND PARAPET MEMBRANE WORK.	≤ a te o te
. FINAL LAYOUT MAY VARY	WARRANTY SHALL INCLUDE ALL PENETRATIONS, FLASHING AND TERMINATIONS. CONTRACTOR SHALL PROVIDE AND INSTALL ALL FLASHINGS, TRIM, SEALANTS, NAILERS, MATERIALS, ETC. REQUIRED TO PROVIDE A COMPLETE WATERPROOF	N a th
SCUPPER. SEE DETAIL	AND NO DOLLAR LIMIT WARRANTED SYSTEM.	ώ Υ Ω Υ
RANT. SEE DETAIL C2, CESS DOOR. SEE DETAIL	15. CONTRACTOR TO FIELD VERIFY ALL CONDITIONS PRIOR TO BID. NO ALLOWANCES WILL BE MADE FOR ADDITIONAL AMOUNTS OF ROOFING MATERIAL, FLASHING, LABOR, ETC. NOT VERIFIED AND NOTIFIED BY THE CONTRACTOR TO THE OWNER REPRESENTATIVE PRIOR TO BID.	
	16. THE ROOFING SYSTEM SHALL BE INSTALLED PER PLANS, DETAILS, SPECIFICATIONS & MANUFACTURER'S REQUIREMENTS, AND PROVIDE A 20 YEAR NO DOLLAR LIMIT	ĬŽ Ŭ Å Ĉ Ž
-502. S. SEE DETAIL C2/A-502.	WARRANTY AS OUTLINED IN THE SPECIFICATIONS. 17. PREDRILL ALL METAL FLASHING/ COUNTER FLASHING MATERIAL PRIOR TO	
INTERIOR WALL. SEE	INSTALLING FASTENERS. 18. THESE DRAWINGS INDICATE, IN GENERAL, ITEMS OF MATERIAL AND EQUIPMENT	A a a c
MNS. SEE DETAIL B3/A-502.	WHICH MUST BE REMOVED, REUSED, REFINISHED OR MODIFIED. NO ATTEMPT HAS BEEN MADE TO INDICATE EACH AND EVERY PORTION OF DEMOLITION AND REMODELING WORK. THE INTENT OF THE DRAWINGS IS TO PROVIDE A GUIDELINE	3 4 0
I. SEE C2, C3/A-502.	TO THE CONTRACTOR(S) TO BETTER ENABLE HIM TO ANTICIPATE THE ENTIRE SCOPE OF WORK. THE CONTRACTOR(S) ARE ADVISED TO VISIT THE JOB SITE TO	97 97
VIDE TWO ROWS OF CH AS REQUIRED FOR NEW ENT.	GET FAMILIAR WITH THE WORK : SCOPE, EXTENT AND ROOF AREAS, PRIOR TO BIDDING. SEE GENERAL NOTE 6 IN REGARD TO SCHEDULING SITE VISITS.	∠ m
	 ALL WALLS OVER 32" WILL REQUIRE INTERIM TERM BAR. FASTEN 12" O.C CONTRACTOR SHALL INCLUDE ALL MECHANICAL AND ELECTRICAL COSTS 	
	NECESSARY FOR DISCONNECTING OF EXISTING ROOFTOP EQUIPMENT AND ITS RE-INSTALLATION . CONDUCT NECESSARY TESTS TO VERIFY THAT UNITS ARE FUNCTIONAL. THIS INCLUDES RAISING OF CURBS TO MEET 12" ABOVE FINISHED ROOF. ALL CURBS GREATER THAN 24" WILL REQUIRE A CRICKET.	Date: 4/15/2024
	21. ON EXISTING ROOFING SYSTEMS AND WALLS THAT ARE NOT PART OF THIS ROOFING PROJECT, ANY DAMAGE OCCURRING DURING THE RENOVATION WORK SHALL BE REPAIRED AT NO EXPENSE TO THE OWNER. NOTIFY OWNER/ ARCHITECT IN WRITING PRIOR TO STARTING WORK IF ANY DAMAGES ARE PRESENT.	95% CD Set
	 DAMAGES NOT REPORTED WILL BE CONSIDERED NEW AND CONTRACTOR WILL BE RESPONSIBLE FOR REPAIRS. REPAIRS MUST NOT VOID ANY EXISTING WARRANTIES. 22. ALL SECURITY, SATELLITE, WEATHER STATIONS, PHONE AND BUILDING DECORATIONS WILL BE HANDLED BY OWNER. COORDINATE WITH OWNER ON DISCONNECT AND RECONNECT. 	Drawn by AMB Checked by TPG/DRA
	23. ALL TOOLS AND WORK RELATED EQUIPMENT MUST BE WITHIN WORKERS' POSSESSION AND CONTROL AT ALL TIMES.	Sheet title
	24. CONTRACTOR SHALL PROVIDE AN INVENTORY OF ALL NON WORKING AND ABANDONED MECHANICAL EQUIPMENT, SUPPLY LINES, DAMAGED CEILING TILES,	
	SIDEWALKS AND OTHER BLDG COMPONENTS THAT COULD BE AFFECTED BY ROOFING PROCESS. ALL ABANDONED ITEMS SHALL BE REMOVED. 25. COORDINATE ALL MECHANICAL UNIT SHUTOFFS WITH THE PROJECT MANAGER.	
	NO COORDINATION IS TO TAKE PLACE WITH THE USER GROUP. 26. THE DESIGNER AND CONSULTANT IS NOT RESPONSIBLE FOR THE ACT AND	ROOF PLAN
	OMISSION OF ANY CONTRACTOR, SUBCONTRACTOR, MATERIAL SUPPLIER, INCLUDING BUT NOT LIMITED TO THE FOLLOWING: SAFETY PRECAUTIONS / PROGRAMS AND THEIR ENFORCEMENT, OR FOR THE CONSTRUCTION MEANS AND	
	METHODS, TECHNIQUES, SEQUENCING AND PROCEDURES EMPLOYED BY THE CONTRACTORS AND THE INCLUSION OF THE REQUIREMENTS OF THE MANUFACTURE FROM THEIR PUBLISHED DOCUMENTS, PROCEDURES, AND THEIR	SCALE: NS
	STAFF ISSUED VERBAL AND WRITTEN INSTRUCTIONS AND REMEDIES. 27. ALL EQUIPMENT THAT CONTAINS FLAMMABLE FLUIDS MUST EITHER BE REMOVED	Sheet No.
	ON A DAILY BASIS OR THE EQUIPMENT TANK MUST BE DRAINED AT END OF EACH DAY. ANY FLAMMABLE FLUID IN CONTAINERS MUST BE REMOVED FROM THE ROOF ON A DAILY BASIS.	A-101
	28. ROOF MUST BE WATERTIGHT AT ALL TIMES. CONTRACTOR MUST SUBMIT A NIGHT SEAL PLAN.	
	29. THE CONTRACTOR IS RESPONSIBLE FOR OBTAINING ALL PERMITS.	Of TOT

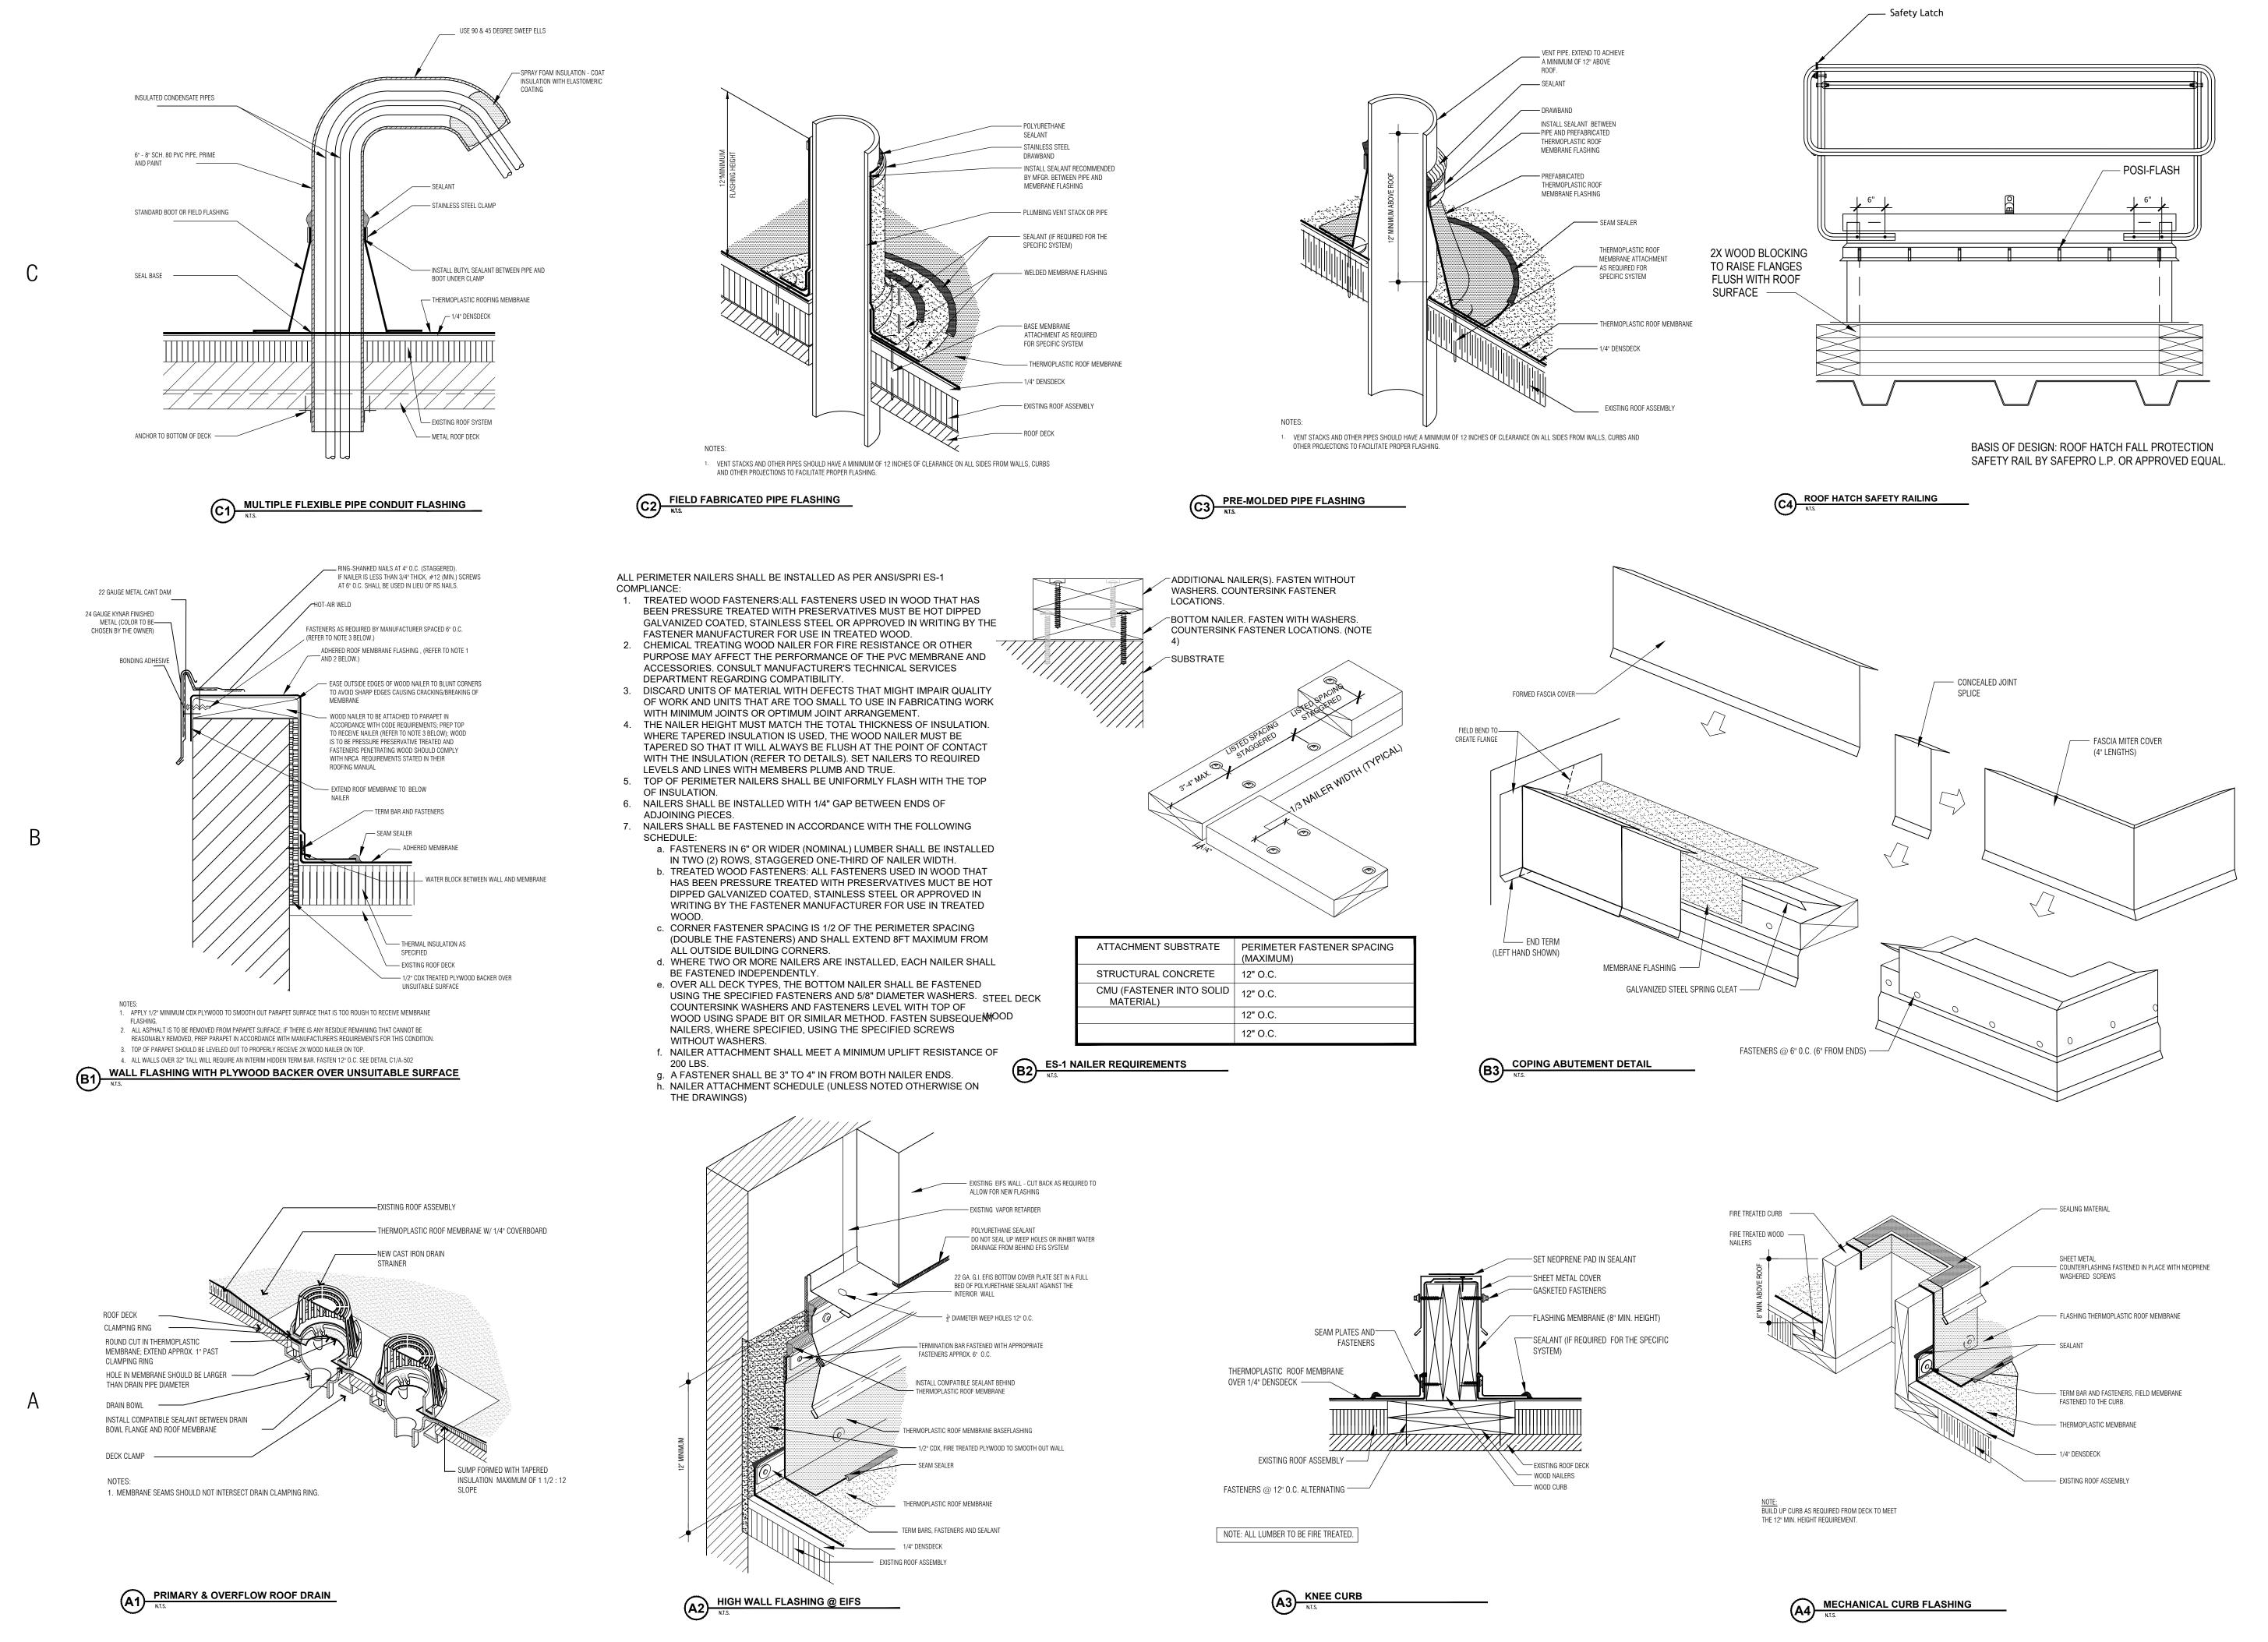



ATTACHMENT SUBSTRATE	PERIMETER FASTENER SPACING (MAXIMUM)
STRUCTURAL CONCRETE	12" O.C.
CMU (FASTENER INTO SOLID MATERIAL)	12" O.C.
	12" O.C.
	12" O.C.




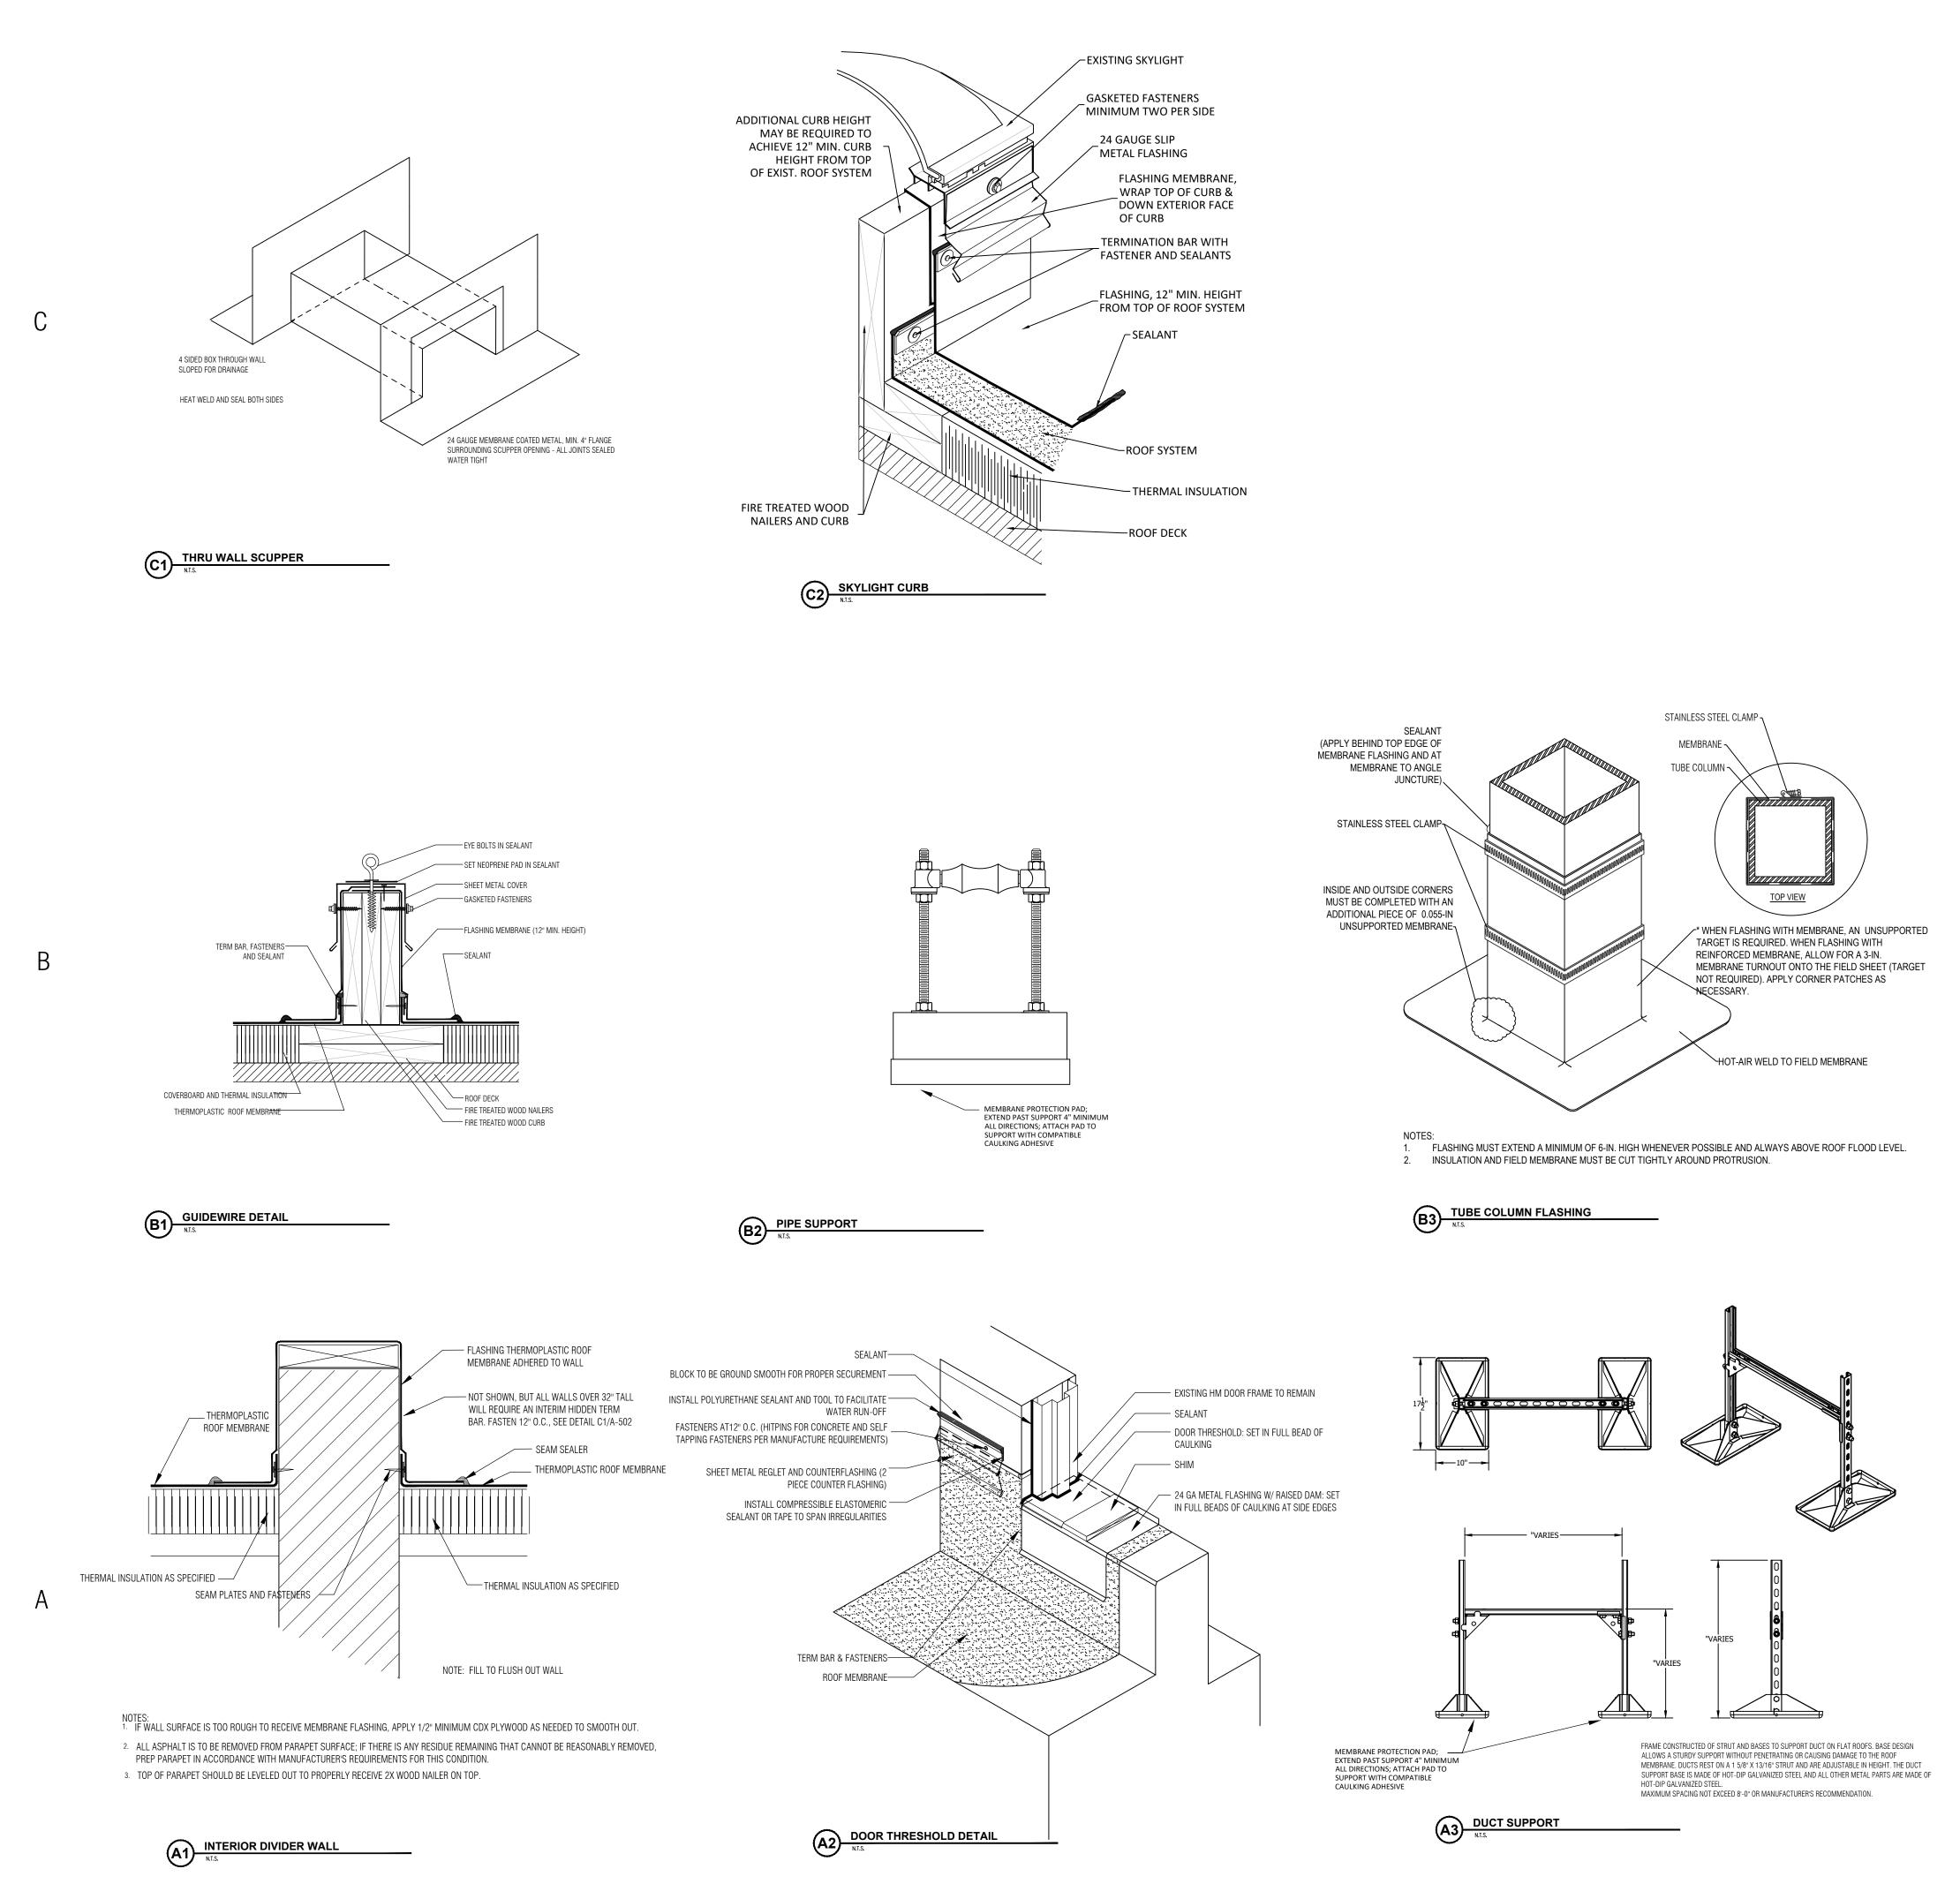

12" MINIMUM

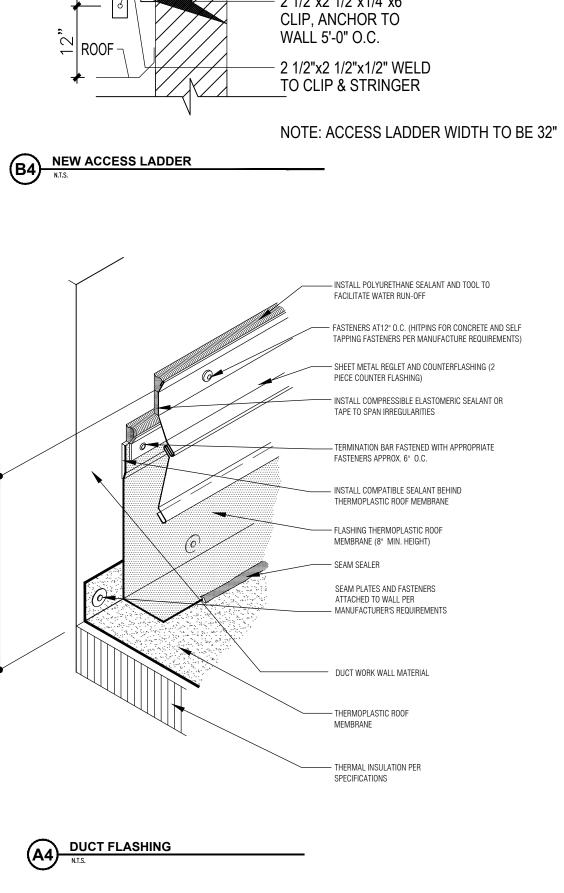

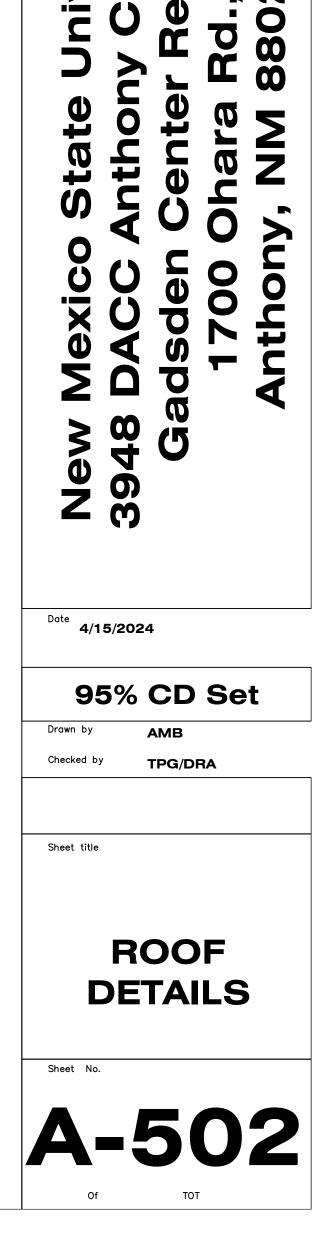

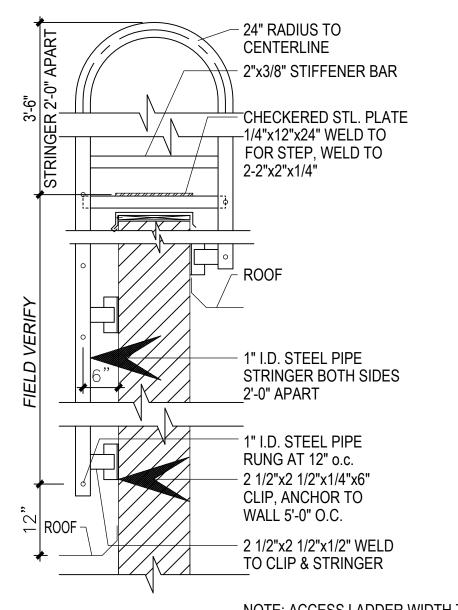

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East Mesa ReBid Package\TED-SEAL_02-17-2020.jpg

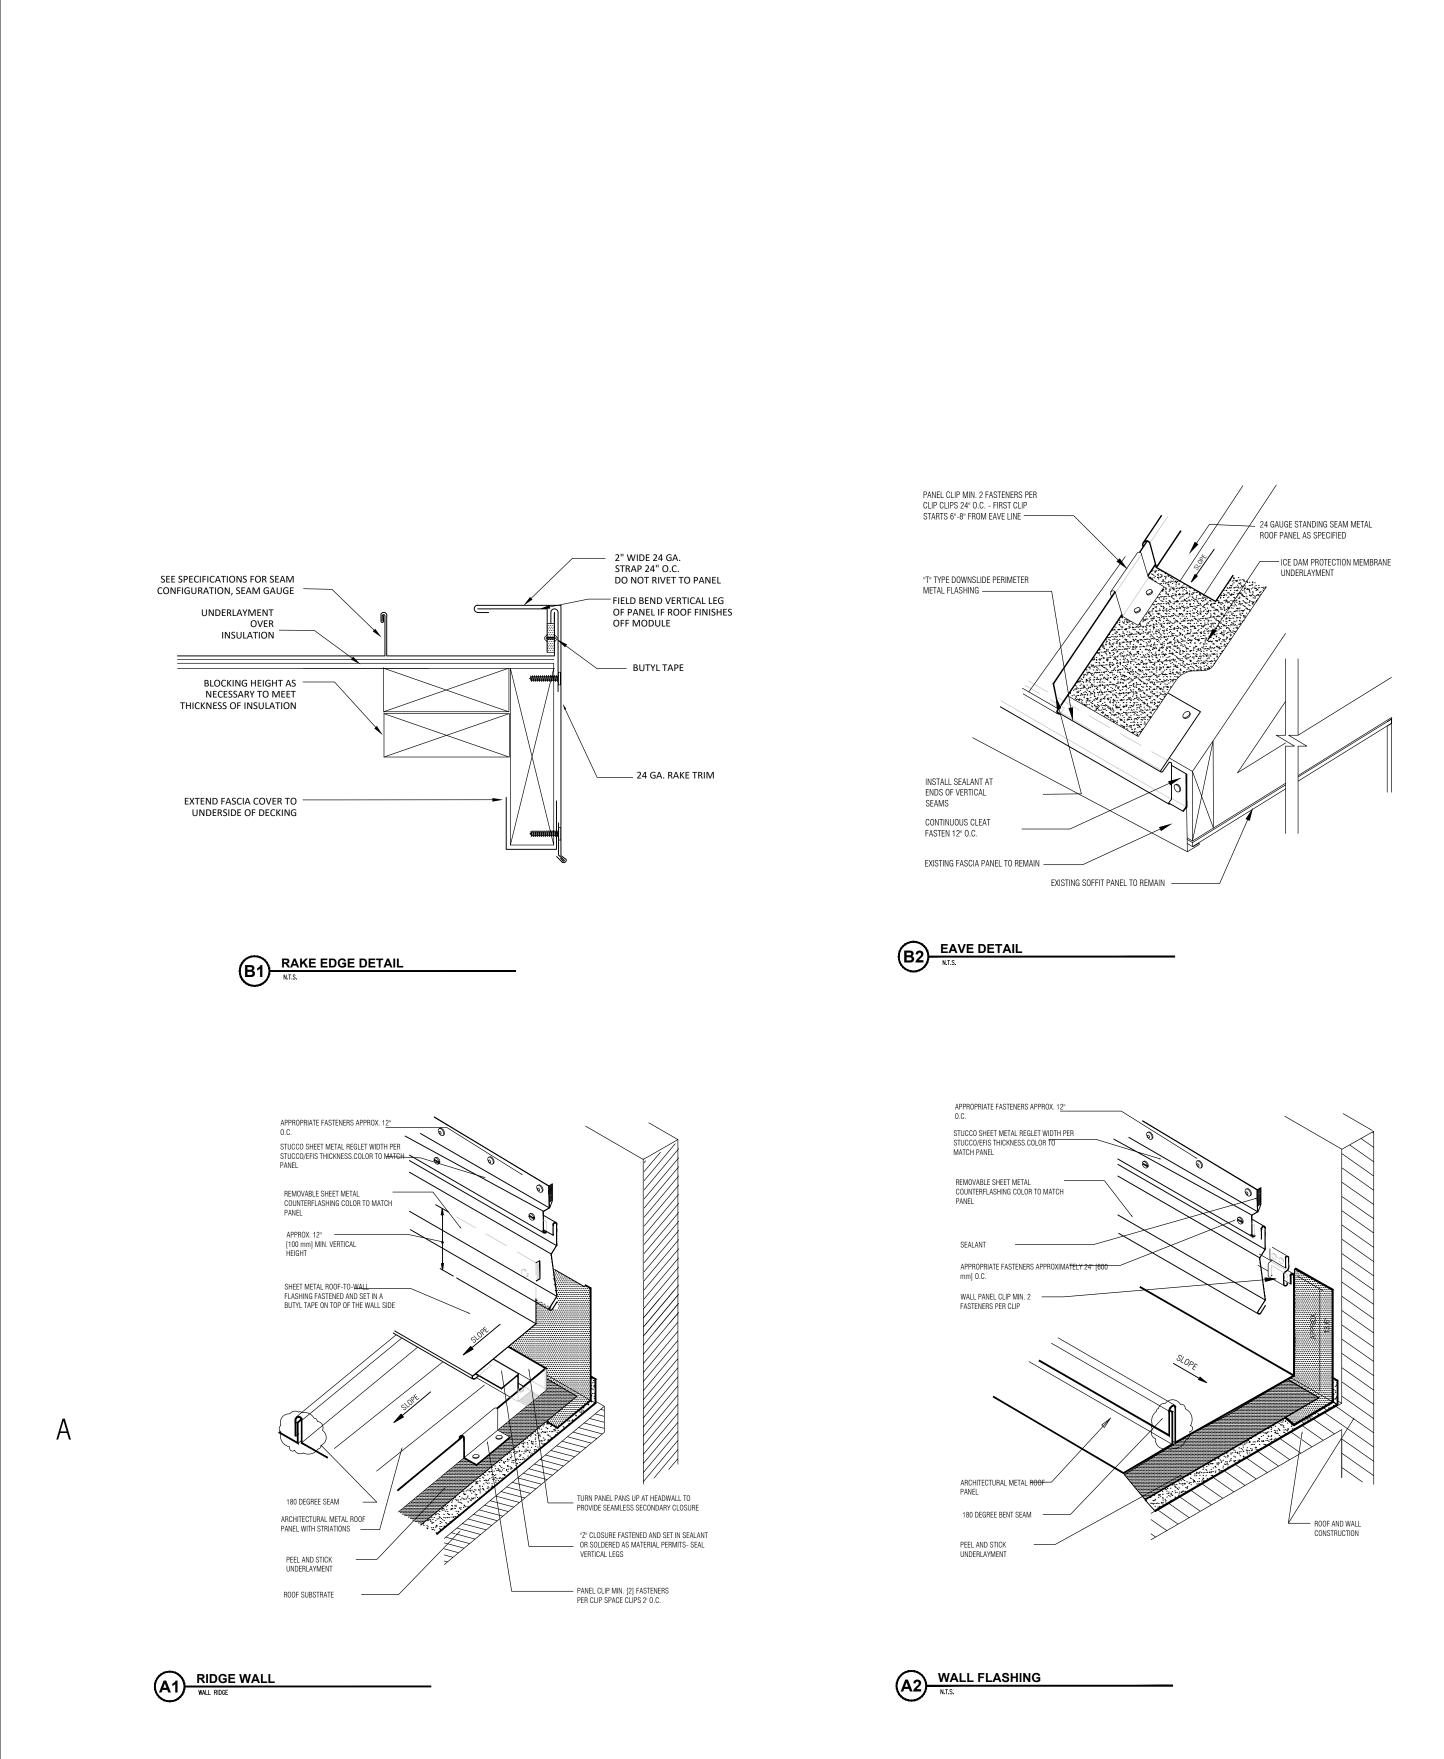
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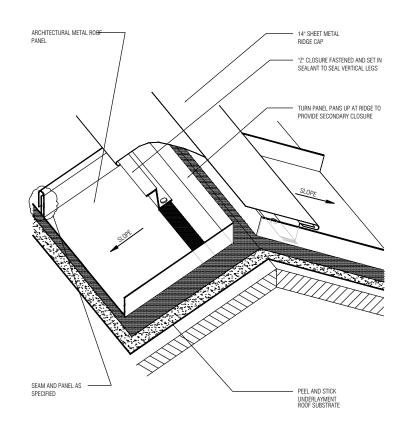
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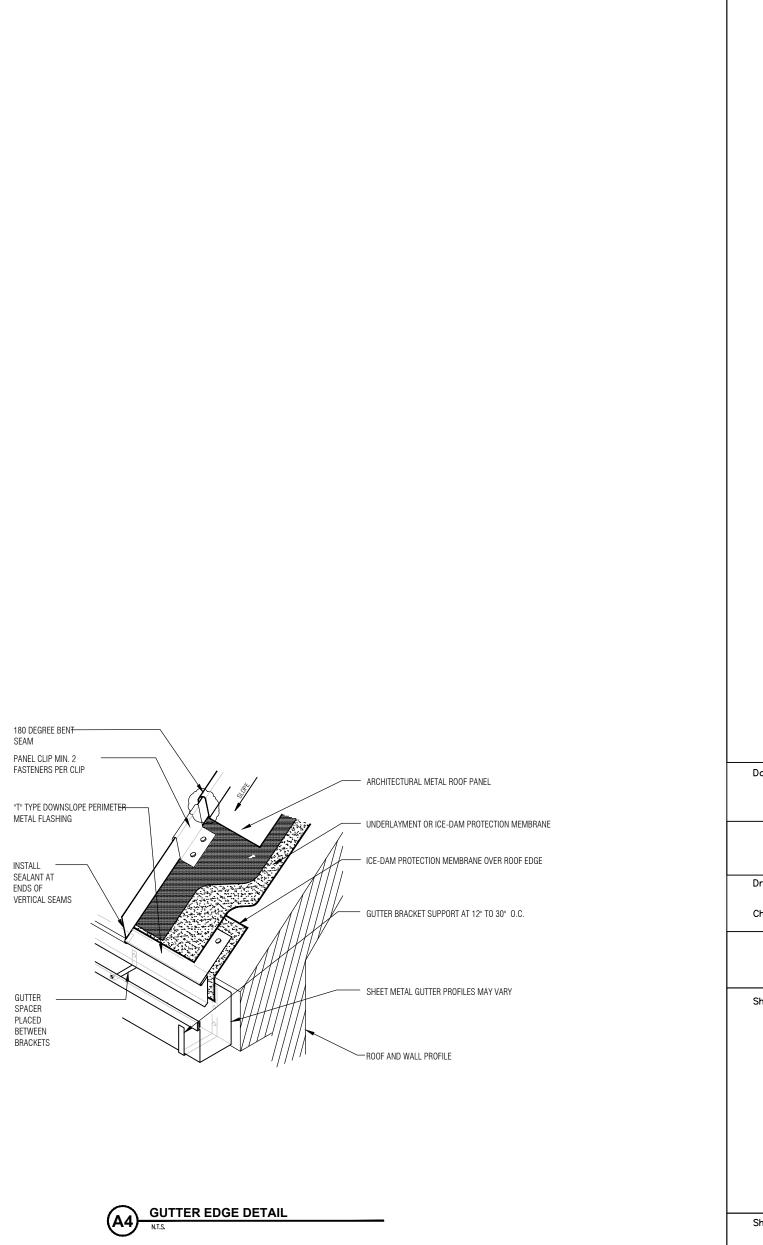


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A3 RIDGE/HIP DETAIL





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